


COMMUNITY CENTER FIRST FLOOR PLAN

COMMON AREA SIGN NOTES

- 51 INSTALL SIGN DISPLAYING INTERNATIONAL SYMBOL OF ACCESSIBILITY @ 60" A.F.F. AT EACH BUILDING ENTRANCE
- 52 PROVIDE TACTILE SIGN WITH THE WORDS "COMMUNITY BUILDING" 60" A.F.F. ON THE LATCH SIDE OF THE DOOR SHOWN.
- 53 PROVIDE SIGN STATING "FIRE ALARM CONTROL PANEL" (VERIFY EXACT WORDING AND LOCATION WITH CITY OF VALLEJO FIRE DEPARTMENT)
- 54 PROVIDE SIGN WITH THE WORDS "UTILITY ROOM" @ 60" A.F.F. ON THE LATCH SIDE OF THE DOOR.
- 55 PROVIDE TACTILE EXIT SIGN WITH THE WORDS "EXIT" @ 60" A.F.F. ON THE WALL ADJACENT TO THE LATCH SIDE OF A SINGLE-LEAF DOOR OR ON THE ADJACENT RIGHT WALL OF A DOUBLE-LEAF DOOR (CBC 10011.3, CBC 1117B.5.7)
- 56 PROVIDE TACTILE SIGN WITH THE WORDS "UTILITY ROOM." @ 60" A.F.F. ON THE LATCH SIDE OF THE DOOR.
- 57 PROVIDE TACTILE SIGN WITH THE WORDS "MEN" 60" A.F.F. ON THE LATCH SIDE OF THE DOOR SHOWN. SEE DOOR SCHEDULE FOR ADDITIONAL REQUIREMENTS.
- 58 PROVIDE TACTILE SIGN WITH THE WORDS "WOMEN" 60" A.F.F. ON THE LATCH SIDE OF THE DOOR SHOWN. SEE DOOR SCHEDULE FOR ADDITIONAL REQUIREMENTS.
- 59 PROVIDE SIGN WITH THE WORDS "STORAGE" 60" A.F.F. ON THE LATCH SIDE OF THE DOOR.
- 510 PROVIDE SIGN WITH THE WORDS "BUSINESS CENTER" 60" A.F.F. ON THE LATCH SIDE OF THE DOOR.
- 511 PROVIDE SIGN WITH THE WORDS "STORAGE / COPY" 60" A.F.F. ON THE LATCH SIDE OF THE DOOR.
- 512 PROVIDE SIGN WITH THE WORDS "OFFICE 1" 60" A.F.F. ON THE LATCH SIDE OF THE DOOR.
- 513 PROVIDE SIGN WITH THE WORDS "OFFICE 2" 60" A.F.F. ON THE LATCH SIDE OF THE DOOR.
- 514 PROVIDE SIGN WITH THE WORDS "FITNESS" 60" A.F.F. ON THE LATCH SIDE OF THE DOOR.
- 515 PROVIDE SIGN WITH THE WORDS "KITCHEN" 60" A.F.F. ON THE LATCH SIDE OF THE DOOR.
- 516 PROVIDE SIGN WITH THE WORDS "LL SCIENCE PROJECT" THE LATCH SIDE OF THE DOOR.

TACTILE EXIT SIGN DETAILS

THE MINIMUM CHARACTER HEIGHT SHALL BE 5/8" PLUS 1/8" PER FOOT OF VIEWING DISTANCE ABOVE 72"

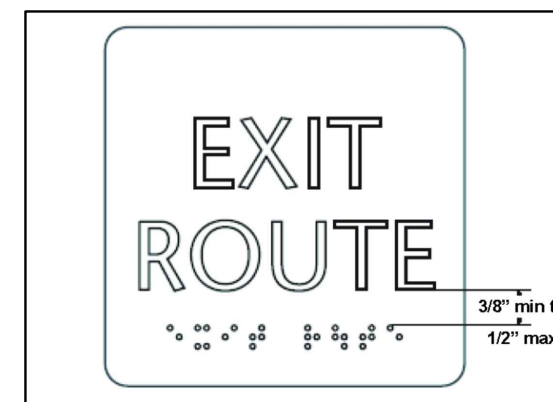

DRAWINGS FOR REVIEW AND BIDDING PURPOSES ONLY-NOT FOR CONSTRUCTION. SUBMIT RFI FOR CONFLICTS OR INFORMATION NOT SHOWN



KEYNOTES

- 1 METAL FENCE GAS METER ENCLOSURE. SEE NORTH ELEVATION
- 2 LIGHTING CONTROL PANEL. SEE ELECTRICAL DRAWINGS
- 3 SEE E ELECTRICAL DWGS FOR TELEPHONE PANEL LOCATION
- 4 FIRE SPRINKLER RISER
- 5 WATER HEATER. SEE MECH. DWGS
- 6 SEE MECHANICAL DWGS. FOR HVAC UNITS
- 7 CONDENSER
- 8 PAIR 2'-0" WIDE X 6' HIGH METAL GATES
- 9 HANDICAPPED ACCESSIBLE DRINKING FOUNTAIN. PROVIDE HIGH AND LOW DRINKING FOUNTAIN
- 10 DOUBLE SINK AND GARBAGE DISPOSAL. COMPLY WITH CBC 1115B.4.7(2)
- 11 DISHWASHER
- 12 RANGE AND OVEN
- 13 REFRIGERATOR WITH WATER SUPPLY FOR ICEMAKER
- 14 30' MIN. CLR. SPACE BELOW COUNTER
- 15 MICROWAVE
- 16 RANGE HOOD, AND FAN. MOUNT CONTROLS AT 44" ABOVE FIN. FLR.
- 17 BASE CABINETS
- 18 UPPER CABINETS
- 19 60" DIAMETER FOR ADA ACCESS
- 20 COUNTER
- 21 HOLES FOR DATA CABLES
- 22 COPIER LOCATION
- 23 FILE CABINET LOCATION
- 24 RECESSED FIRE EXTINGUISHER (PORTABLE) - TYPICAL ONE 2A-10BC TYPE AT LOCATIONS SHOWN
- 25 ADJUSTABLE OPEN SHELVES
- 26 TV/VIDEO GAME SPACE
- 27 FIRE DEPARTMENT KNOX BOX.
- 28 not used
- 29 WOOD TRELLIS
- 30 8' WALL MOUNTED MIRROR
- 31 ROOF DOWNSPOUTS
- 32 FABRIC AWNING
- 34 6' HIGH WOOD FENCE SEE DETAIL SHEET A9.4
- 35 16X16 WALL LOUVERS II AT 12' ABOVE FLOOR, 12" BELOW CEILING

GENERAL NOTES

- B. ALL DIMENSIONS ARE TO FACE OF STUD OR CENTERLINE OF PARTITION WALL, INTERIOR COLUMN/ WINDOW/ DOOR UNLESS OTHERWISE NOTED.
- C. DETAILS ARE KEYED AND NOTED "TYPICAL" ONLY ONCE ON THE PLANS WHEN THEY FIRST OCCUR, AND ARE REPRESENTATIVE OF SIMILAR CONDITIONS THROUGHOUT, UNLESS OTHERWISE NOTED.
- D. OTHERWISE NOTED.
- E. PROVIDE WATER-RESISTANT GYP. BOARD AT ALL WET WALL LOCATIONS.
- F. FOR DOOR AND WINDOW KEYS REFER TO DOOR AND WINDOW SCHEDULE. SEE A9.1
- G. REFER TO INTERIOR ELEVATION FOR CABINETS CALLOUTS. SEE SHEET A2.3, A2.4 & A2.5.
- H. FOR ALL TOILETS ACCESSORIES & HEIGHTS REFER TO A2.3, A2.4 & A2.5
- I. FOR FINISH FLOOR REFER TO FINISH SCHEDULE A4.1.
- J. PROVIDE ACOUSTICAL SEALANT AT ALL WALLS AND CEILING CONDITION.
- K. PROVIDE 5/8" THK. GYP. BD. MOISTURE RESISTANT AT WET AREAS , BATHROOMS & KITCHEN SINK AREA.
- L. PROVIDE WD. BLOCKING AT CEILING FOR BLINDS AT WINDOW WHERE REQUIRED.
- M. GROUND AND FLOOR SURFACES AT ACCESSIBLE ROUTES TO BE SLIP RESISTANCE PER N. CBC. 1124.B
- N. SLOPE FLOOR DRAIN 1/4"=1'-0 SEE PLUMBING DWGS.
- O. PROVIDE WD BLOCKING IN WALL AT GRAB BAR, CABINETS, SHELVES, AND CEILINGS AS P. REQUIRED FOR WINDOW SHADING.
- P. PLYWOOD SHEAR WALL TO EXTEND FULL HEIGHT OF THE WALL. SSD.
- Q. INTERIOR FINISHES CEILINGS & WALLS SHALL BE CLASSIFIED W/ASTME 84-TYPE "C" FLAMED SPREAD 76-200, SMOKE DEVELOPED AT 0-450. TESTED W/NFPA 286
- R. INTERIOR TRIM SHALL HAVE A MIN. CLASS C FLAMED SPREAD & SMOKE DEVELOP INDEX WHEN TESTED W/ASTME-84 AND NOT TO EXCEED 10% OF AGGREGATE WALL OR CLG. REFER TO SHEET A0.XX FOR WALL TYPE LEGEND

LEGEND

- ONE HOUR RATED WALL. SEE DETAIL SHEET X/XX
- INTERIOR FULL HT. PARTITION. SEE DETAIL SHEET X.XX
- INTERIOR BEARING PARTITION WALL. SEE DETAIL SHEET X.XX
- FIRE EXTINGUISHER

REVISIONS		BY
9/26/2011	PLAN CHECK	G.O.
11/20/2013	GAS METER	STAFF
1/20/2014	BIDDING	STAFF
WINDOW, DOOR MARKS ADDED.		
DOORS MODIFIED. FLOOR FINISHES CHANGED		

PROJECT TITLE: COMMUNITY CENTER  
HARBOR PARK APARTMENTS  
969 PORTER STREET, VALLEJO, CA 94560  
DRAWING TITLE: FIRST FLOOR PLAN


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Job No.:	2011-09
Sheet:	A2.1

Jan 27, 2014 - 4:03pm \\SERVER\Server Drive B\Year 2011 Jobs\2011-09-3 - Community Bldg\REVISED DRAWINGS FOR NEGOTIATED CONTRACT WITH W. LYONS\ARCHITECT\A2.21-A2.25-REVISED FOR WELYONS BID FOR DOOR SCHEDULE 1-14-2014.dwg

ACCESSIBILTY NOTES

- 29. BASE CABINETS WITH "BASELIFT" ADJUSTABLE SINK AND COUNTER. PROVIDE VINYL FINISH FLOOR.
- 30. BASE COUNTER TOP SHALL BE ADJUSTABLE TO 28" MINIMUM HEIGHT (SLUMLIFT OR EQUAL)
- 31. PROVIDE MINIMUM 30" X 48" CLEAR SPACE AT TUB FOR ACCESSIBILITY
- 32. GRAB BARS, AND SUPPORTS SHALL BE ABLE TO SUPPORT 250 POUND FORCE.
- 33. MOUNT ALL RECEPTACLE OUTLETS BETWEEN 15" AND 48" ABOVE FINISH FLOOR.
- 34. MOUNT ALL SWITCHES, THERMOSTATS, AND OTHER CONTROLS BETWEEN 15" AND 48 INCHES ABOVE FINISH FLOOR
- 35. BASE CABINETS UNDER SINK CABINET AREA, INCLUDING TOEBOARD, AND SHELVING SHALL BE REMOVABLE WITHOUT THE USE OF SPECIALIZED TOOLS OR SPECIALIZED KNOWLEDGE TO PROVIDE CLEARANCE FOR A WHEELCHAIR. FINISHED FLOORING SHALL BE PROVIDED BENEATH THE COUNTER TOP
- 36. PROVIDE A PERMANENTLY WIRED DOORBELL MOUNTED 48" ABOVE THE FLOOR AT MAIN ENTRY TO UNIT A, ACCESSIBLE UNIT

DETAIL A

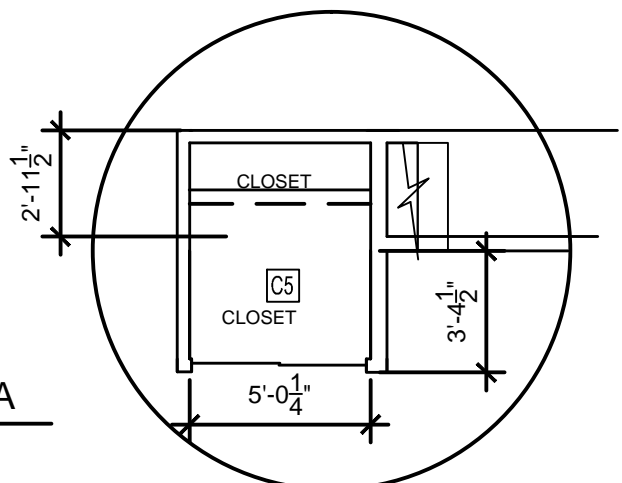

KEYNOTES

- 01 BASE CABINETS.
- 02 UPPER CABINETS
- 03 BACK SPLASH
- 04 P. LAM. FINISH.
- 05 DOUBLE SINK. MIN. 30" SPACE BELOW COUNTER
- 06 WOOD TRIM
- 07 PAPER TOWEL DISPENSER
- 08 BLOCK OUT WALL
- 09 TOILET TISSUE DISPENSER
- 10 CERAMIC TILE
- 11 MIRROR
- 12 RANGE HOOD
- 13 CONVENTIONAL OVEN/STOVE
- 14 ACCESSIBLE REFRIGERATOR 30" MIN. CLR.
- 15 FLOOR MOUNTED TOILET
- 16 FLOOR DRAIN
- 17 SOLID WOOD DOOR, SEE SHEET A15.1
- 18 COUNTER TOP MICROWAVE
- 19 DISHWASHER
- 20 SINK SPD
- 21 TUB SPD
- 22 SHOWER (STERLING MODEL 71150115-0 AT ADA UNIT)

INTERIOR STAIR NOTES

- 23. STAIR SHALL HAVE CLOSED VERTICAL RISERS.
- 24. THERE SHALL BE NO NOSING AT TREADS
- 25. PROVIDE SLIP RESISTANT TREADS OR CARPET FINISH
- 26. HANDRAILS ARE SHOWN AT EA. SIDE OF STAIRWAYS
- 27. HANDRAILS SHALL BE MOUNTED 34 TO 38 INCHES ABOVE TOP OF END OF TREAD
- 28. HANDRAILS SHALL BE 1.5" IN DIA, AND TERMINATE ION SAFETY TERMINALS. SEE 6/55.1 FOR MOUNTING

DETAIL

RISER CALCULATIONS:  
GROUND FLOOR TO SECOND FLOOR  
12'-7"=151" 151 / 7 = 21.57 USE 22 RISERS  
SECOND FLOOR TO THIRD FLOOR  
9'-1" + 15.875" FLOOR + 3.5" SHIM =128.375"  
128.375 / 7.75 =16.5645 RISERS USE 17 RISERS @ 7.5691"


GENERAL NOTES

- A. ALL DIMENSIONS ARE TO FACE OF STUD OR CENTERLINE OF PARTITION WALL, INTERIOR COLUMN/ WINDOW/ DOOR UNLESS OTHERWISE NOTED.
- B. DETAILS ARE KEYED AND NOTED "TYPICAL" ONLY ONCE ON THE PLANS WHEN THEY FIRST OCCUR, AND ARE REPRESENTATIVE OF SIMILAR CONDITIONS THROUGHOUT, UNLESS OTHERWISE NOTED.
- C. PROVIDE WATER-RESISTANT GYP. BOARD AT ALL WET WALL LOCATIONS.
- D. FOR DOOR AND WINDOW KEYS REFER TO DOOR AND WINDOW SCHEDULE. SEE A9.1 REFER TO INTERIOR ELEVATION FOR CABINETS CALLOUTS. SEE SHEET A2.3, A2.4 & A2.5.
- E. FOR ALL TOILETS ACCESSORIES & HEIGHTS REFER TO A2.3, A2.4 & A2.5
- F. FOR FINISH FLOOR REFER TO FINISH SCHEDULE A4.1.
- G. PROVIDE ACOUSTICAL SEALANT AT ALL WALLS AND CEILING CONDITION.
- H. PROVIDE 5/8" THK. GYP. BD. MOISTURE RESISTANT AT WET AREAS , E RESTROOMS, LAUNDRY AREA, CLASS RESTROOM, & KITCHEN SINK AREA.
- I. PROVIDE WD. BLOCKING BEHIND GYPSUM BD. PARTITION FOR ATTACHMENT FOR ALL FIXTURE, FITTINGS, ART WORK & ACCESSORIES.
- J. PROVIDE WD. BLOCKING AT CEILING FOR BLINDS AT WINDOW WHERE REQUIRED.
- K. PROVIDE TACTILE SIGN AT EXIT DOORS WITH THE WORD "EXIT" PER CBC. 1011.3.
- L. GROUND AND FLOOR SURFACES AT ACCESSIBLE ROUTES TO BE SLIP RESISTANCE PER CBC. 1124.B
- M. SLOPE FLOOR DRAIN 1/4"=1'-0" SEE PLUMBING DWGS.
- N. PROVIDE WD BLOCKING IN WALL AT GRAB BAR, CABINETS, SHELVES, AND CEILINGS AS REQUIRED FOR WINDOW SHADING.
- O. PLYWOOD SHEAR WALL TO EXTEND FULL HEIGHT OF THE WALL. SSD.
- P. INTERIOR FINISHES CEILINGS & WALLS SHALL BE CLASSIFIED W/ASTME 84-TYPE "C" FLAMED SPREAD 76-200, SMOKE DEVELOPED AT 0-450. TESTED W/NFPA 286
- Q. INTERIOR TRIM SHALL HAVE A MIN. CLASS C FLAMED SPREAD & SMOKE DEVELOP INDEX WHEN TESTED W/ASTME-84 AND NOT TO EXCEED 10% OF AGGREGATE WALL OR CLG.
- R. SEE ROOF PLAN FOR DOWNSPOUT LOCATIONS
- S. WALK DECK SHALL BE DEXTOTEX 500 URETHANE DECK OR EQUAL USE SLOPED SHAPED INSULATION BOARDS TO OBTAIN SLOPE AT ROOF DECK.

LEGEND

- ONE HOUR RATED WALL
- INTERIOR FULL HT. PARTITION
- INTERIOR BEARING PARTITION WALL
- FIRE EXTINGUISHER

REVISIONS	BY
9/26/2011 - PLAN CHECK	G.O.
2/13/2012 - REVISIONS	STAFF
1-08-14 ROOF DRAINAGE	STAFF
1-08-14 STAIRWAYS	

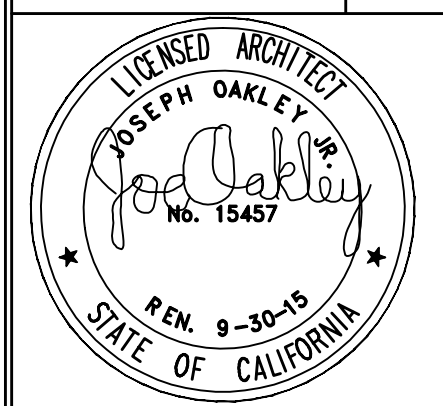

**OAKLEY & OAKLEY**  
ARCHITECT, CIVIL & STRUCTURAL ENGINEERS  
7700 E. DEWEATER DRIVE, SUITE 615  
DENVER, CO 80231  
TEL: 303.733.6021  
FAX: 303.733.6043

PROJECT TITLE: **COMMUNITY CENTER**  
HARBOR PARK APARTMENTS  
969 PORTER STREET, VALLEJO, CA 94560  
DRAWING TITLE: **SECOND FLOOR PLAN**


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Checked: RY  
Job No.: 2011-09  
Sheet:  
**A2.21**  
Of Sheets

**01 COMMUNITY CENTER SECOND FLOOR PLAN**  
SEE ACCESSIBLTY NOTE 29 THROUGH FOR ACCESSIBLE UNIT A

DRAWINGS FOR REVIEW AND BIDDING PURPOSES ONLY-NOT FOR CONSTRUCTION. SUBMIT RFI FOR CONFLICTS OR INFORMATION NOT SHOWN

**02 COMMUNITY CENTER THIRD FLOOR PLAN**

Jan 27, 2014 - 4:05pm \\SERVER\Server Drive D\Year 2011 Jobs\2011-09.3 - Community Bldg\REVISED DRAWINGS FOR NEGOTIATED CONTRACT WITH WE LYDINS\ARCHITECT\A221-A225-REVISED FOR WELYONS BID FOR DOOR SCHEDULE 1-14-2014.dwg

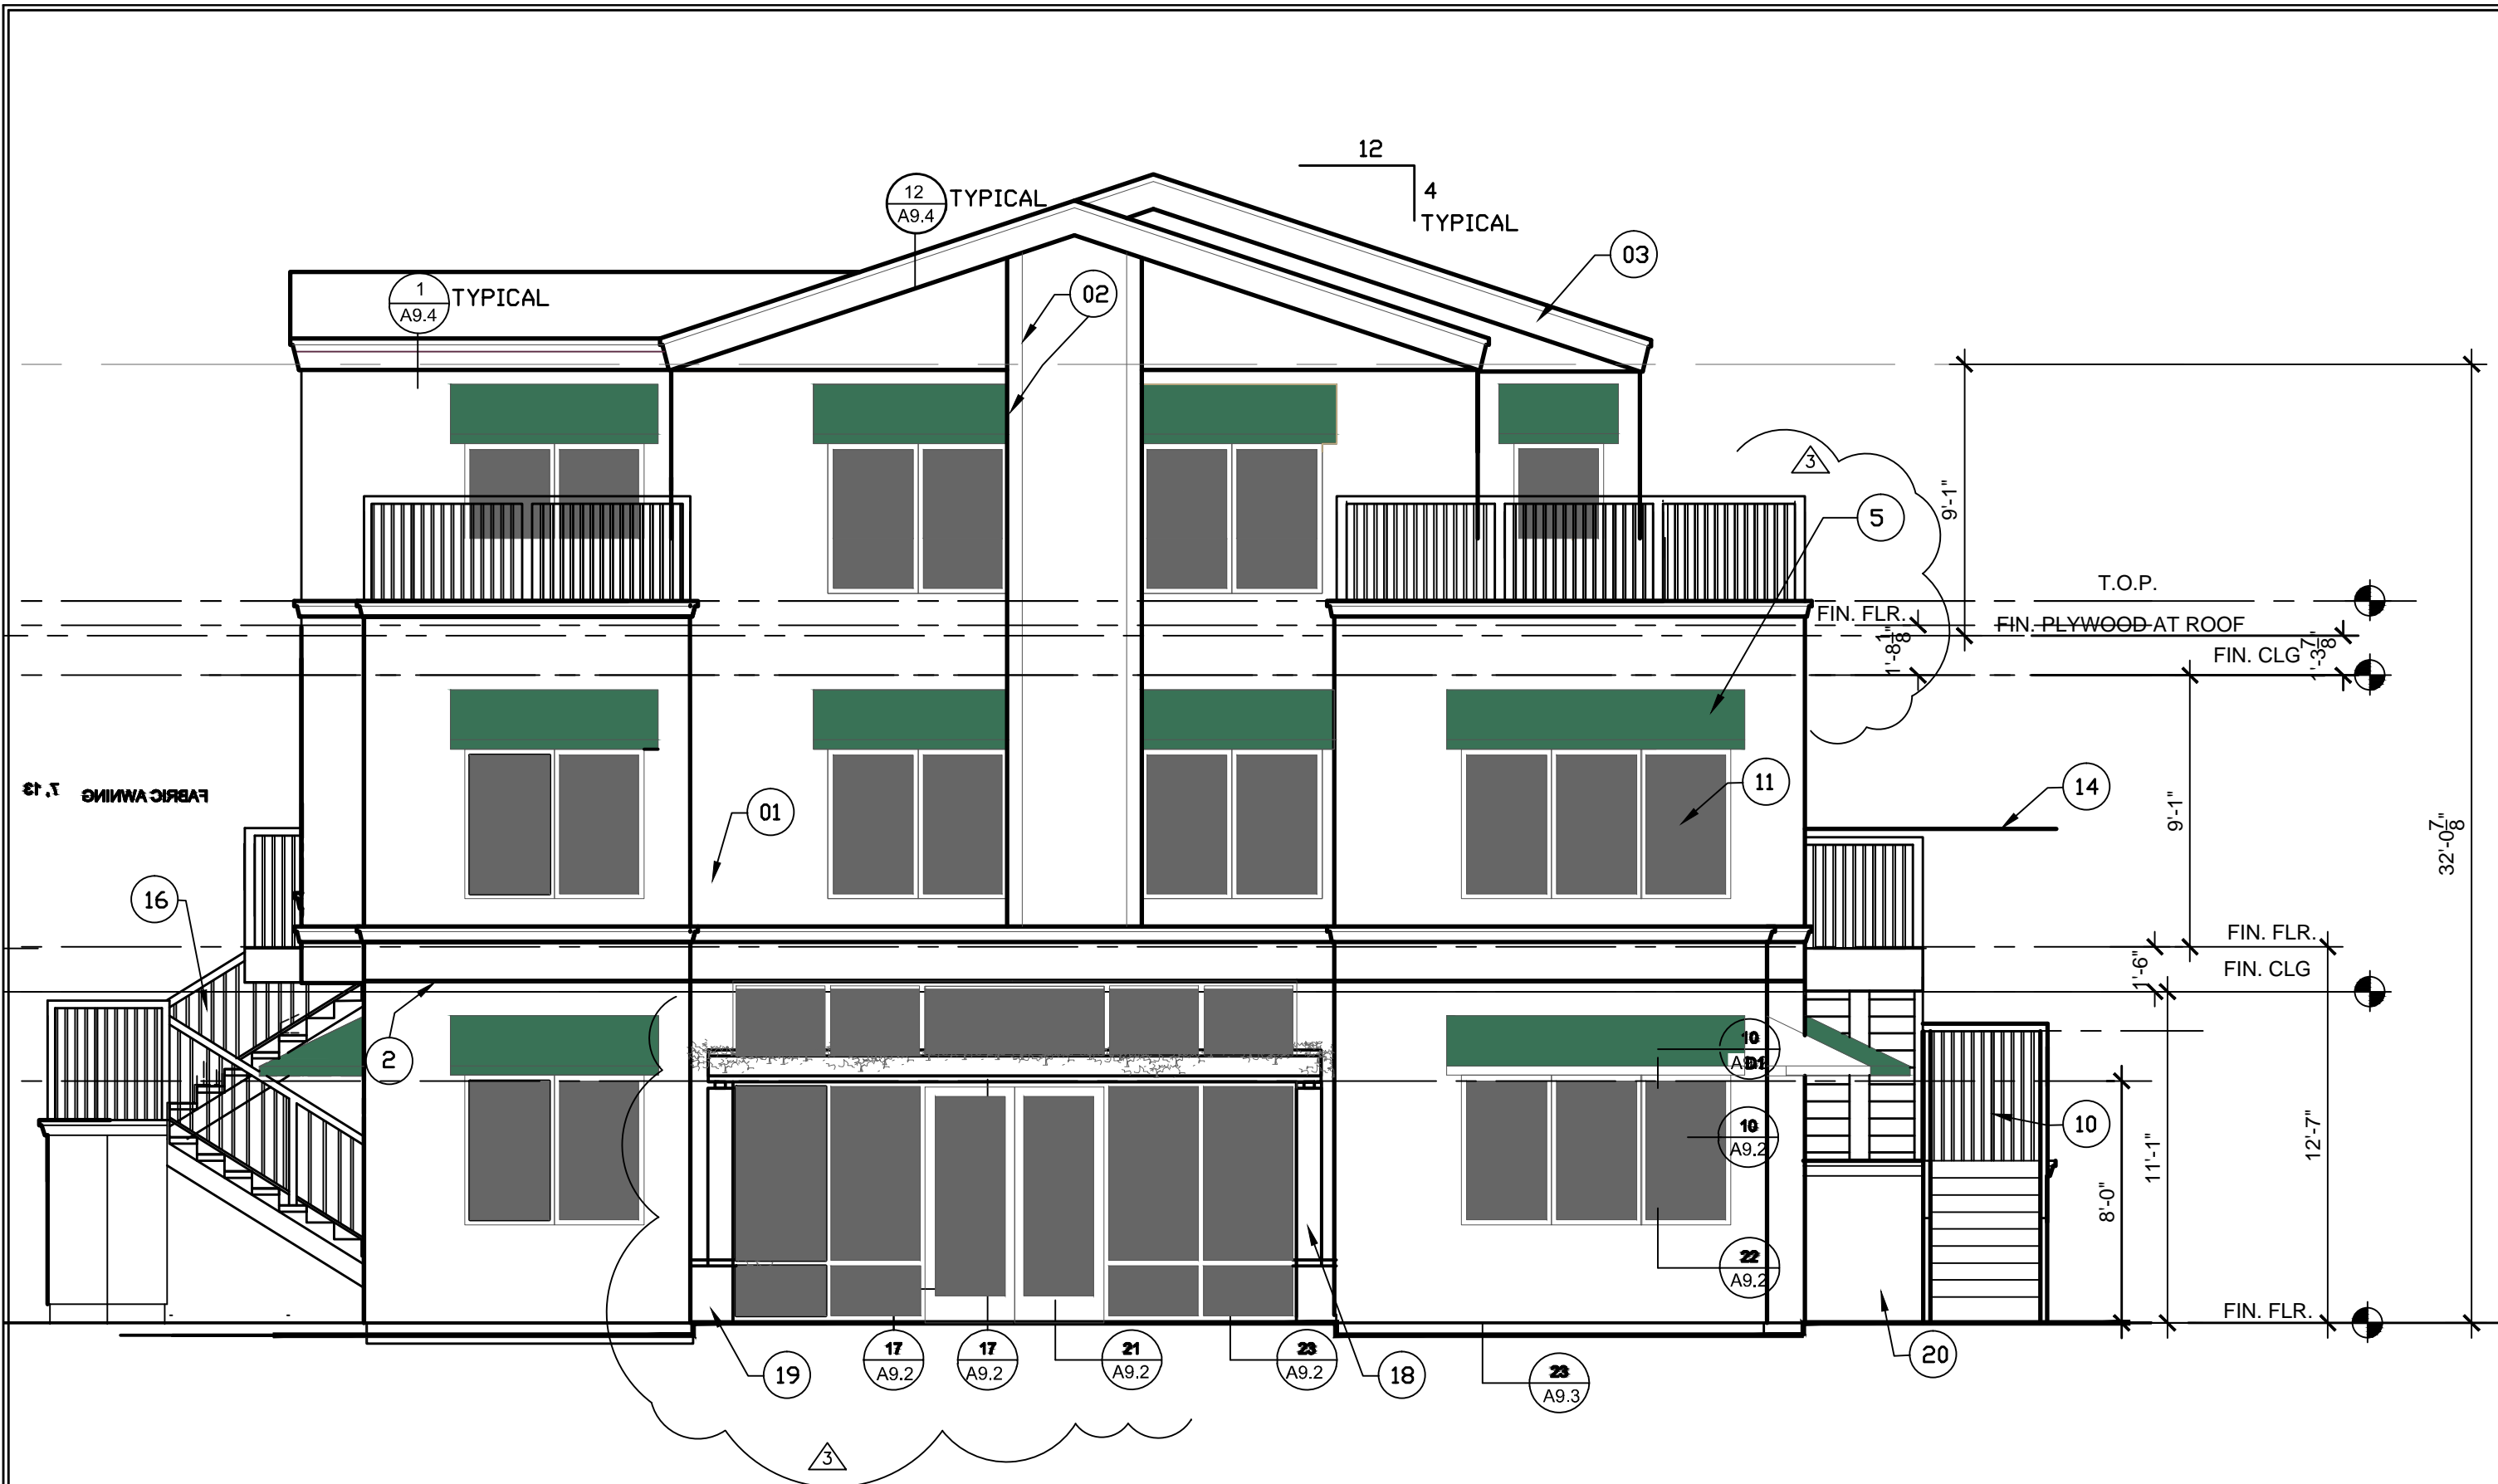

FRONT ELEVATION (SOUTH)



NORTH ELEVATION



PORTER STREET ELEVATION (WEST)

KEYNOTES ELEVATIONS

- 01 3 COATS OF CEMENT PLASTER SYSTEM WITH ACRYLIC FINISH
- 02 2" ALUMINUM REVEAL
- 03 EPS TRIM G.I. CAPPING
- 04 EPS TRIM
- 05 FABRIC AWNING
- 06 G.I. SCUPPER CONDUCTOR
- 07 METAL & WOOD TRELLIS
- 08 METAL STAIRS
- 09 WOOD TRELLIS
- 10 METAL STAIRS
- 11 VINYL WINDOW. SEE WINDOW SCHEDULE
- 12 ALUMINUM STOREFRONT SYSTEM - SEE WINDOW SCHEDULE
- 13 EXTERIOR WOOD DOORS, SEE DOOR SCHEDULE
- 14 STEEL RAILING
- 15 VINYL WINDOW
- 16 MTL. RAILING
- 17 LOUVER DOOR
- 18 WOOD COLUMN
- 19 PLANTER BOX
- 20 WHEEL CHAIR LIFT
- 21 6" WOOD FENCE-SELECTION BY OWNER
- 22 EXHAUST FAN OUTLET

GENERAL NOTES

- A. ALL DIMENSIONS ARE TO FACE OF STUD OR CENTERLINE OF PARTITION WALL, INTERIOR COLUMN/ WINDOW/ DOOR UNLESS OTHERWISE NOTED.
- B. DETAILS ARE KEYED AND NOTED "TYPICAL" ONLY ONCE ON THE PLANS WHEN THEY FIRST OCCUR, AND ARE REPRESENTATIVE OF SIMILAR CONDITIONS THROUGHOUT, UNLESS OTHERWISE NOTED.
- C. FOR DOOR AND WINDOW KEYS REFER TO DOOR AND WINDOW SCHEDULE.

LEGEND

- ONE HOUR RATED WALL
- INTERIOR FULL HT. PARTITION
- INTERIOR BEARING PARTITION WALL
- EPS TRIM - MOLDING

DRAWINGS FOR REVIEW AND BIDDING PURPOSES ONLY-NOT FOR CONSTRUCTION. SUBMIT RFI FOR CONFLICT OR INFORMATION NOT SHOWN

REVISIONS		BY
9/26/2011	PLAN CHECK	G.O.
1/ 08 / 14	BIDDING	T.O.
GUARDRAIL AND WINDOWS		
REVISION: PARAPET RAISED FOR BUILT UP ROOF, 9'-9" CLG., 7"		
STOREFRONT DOORS, WINDOWS		
REVISED		
BIDDING		
REVISION		

JOSEPH OAKLEY  
No. 15457  
REN. 9-30415  
STATE OF CALIFORNIA

PROJECT TITLE: COMMUNITY CENTER  
HARBOR PARK APARTMENTS  
969 PORTER STREET, VALLEJO, CA 94560

DRAWING TITLE: SECOND FLOOR PLAN

Date: 08/30/2011

Scale: 3/16" = 1'-0"

Drawn: STAFF


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Job No.: 2011-09


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Of Sheets

Jan 27, 2014 - 4:07pm \\SERVER\Server Drive B\Year 2011 Jobs\A221-093 - Community Bldg\REVISED DRAWINGS FOR NEGOTIATED CONTRACT WITH WE LYDINS\ARCHITECT\A221-A225-REVISED FOR WELYONS BID FOR DOOR SCHEDULE 1-14-2014.dwg



WEST ELEVATION

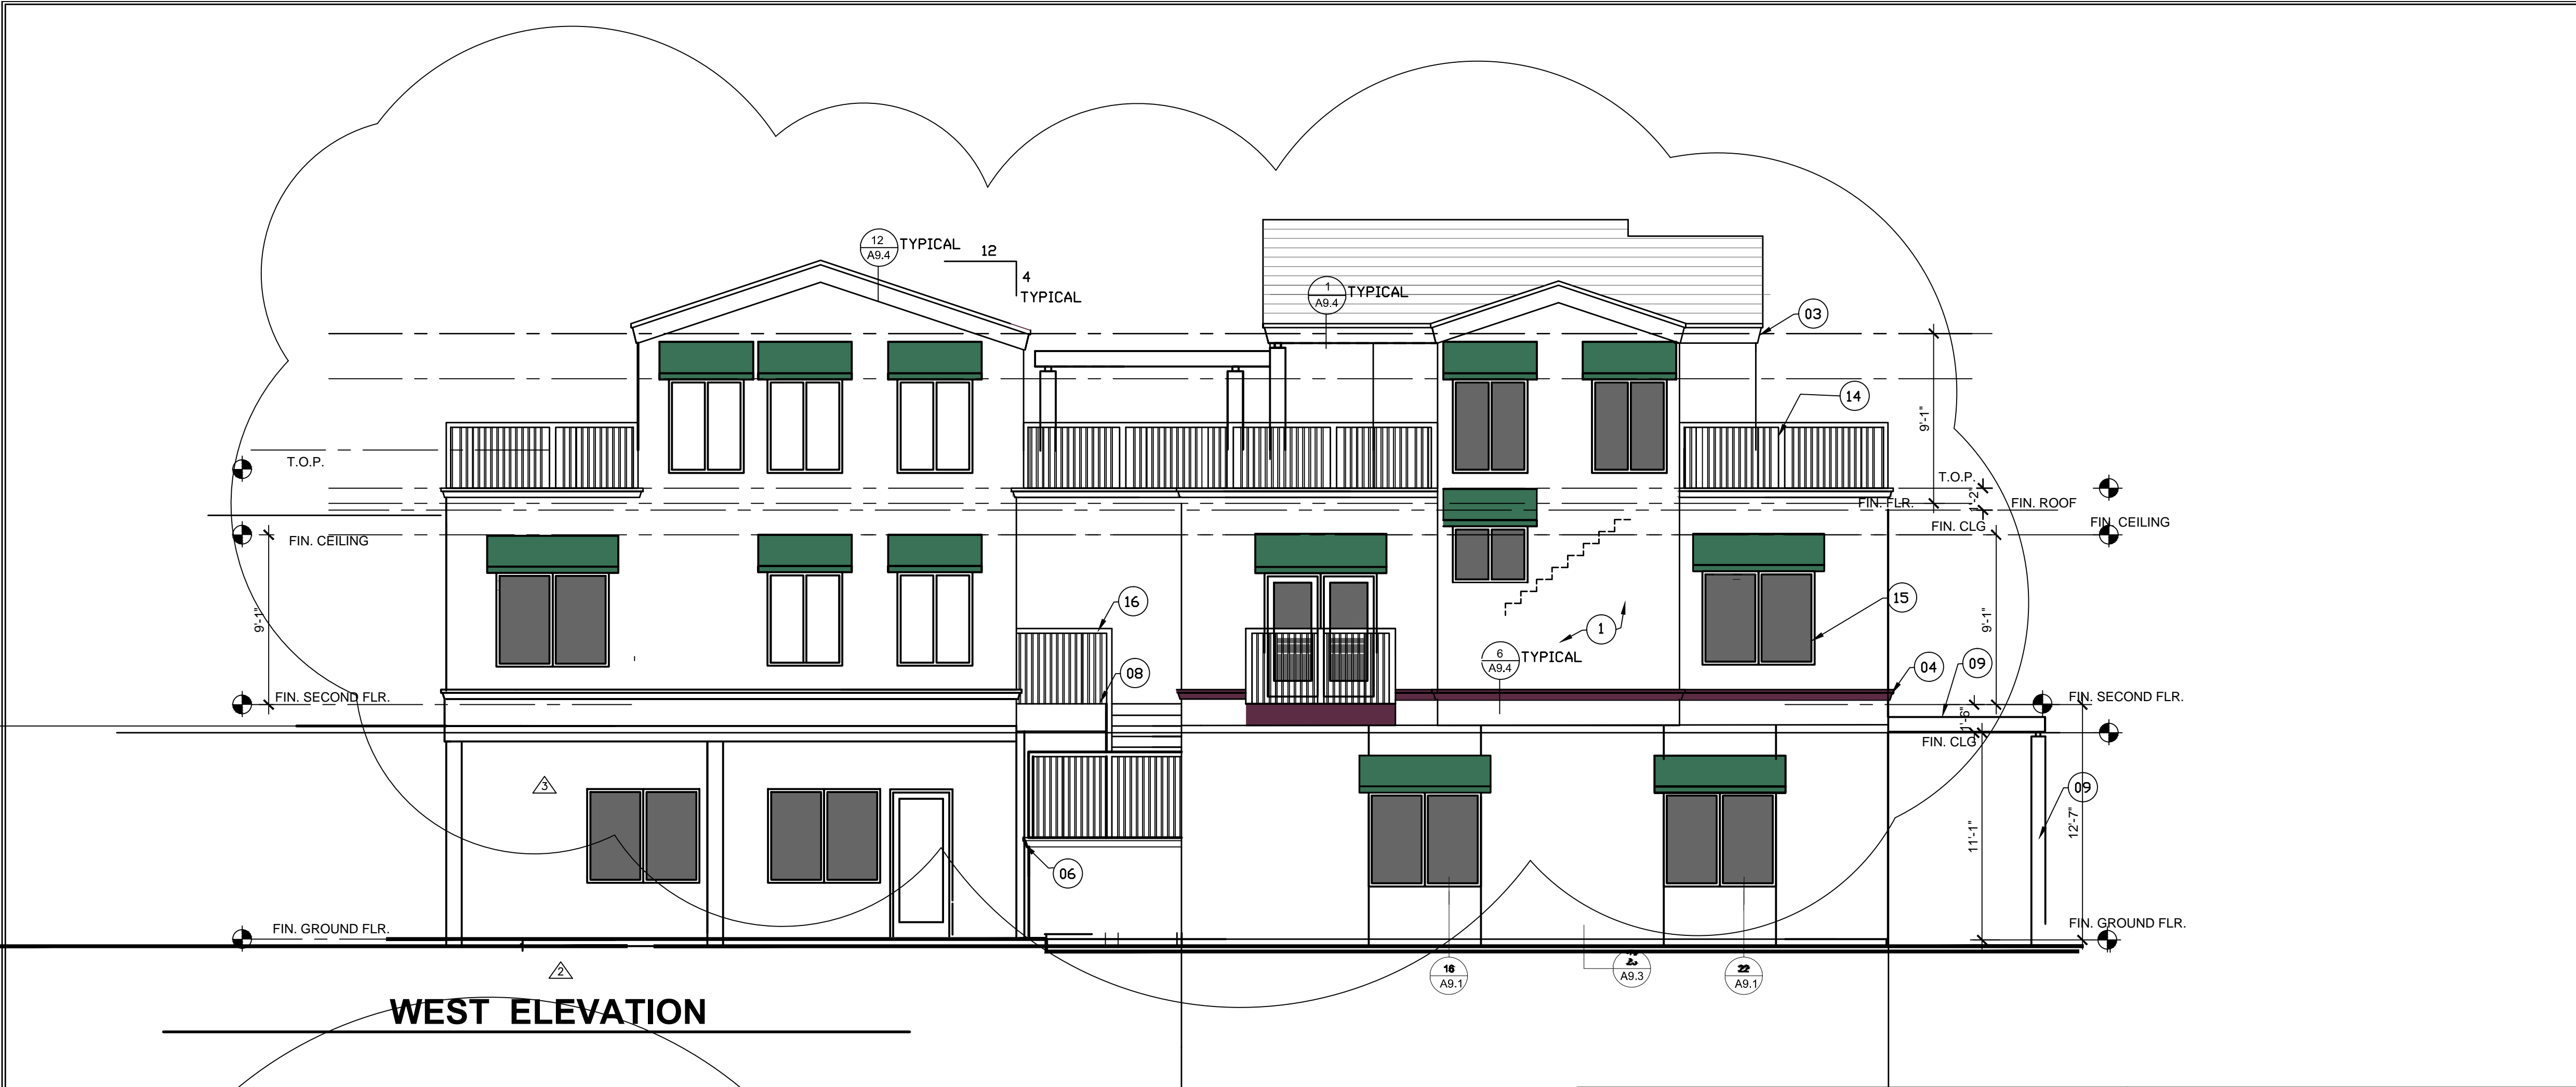

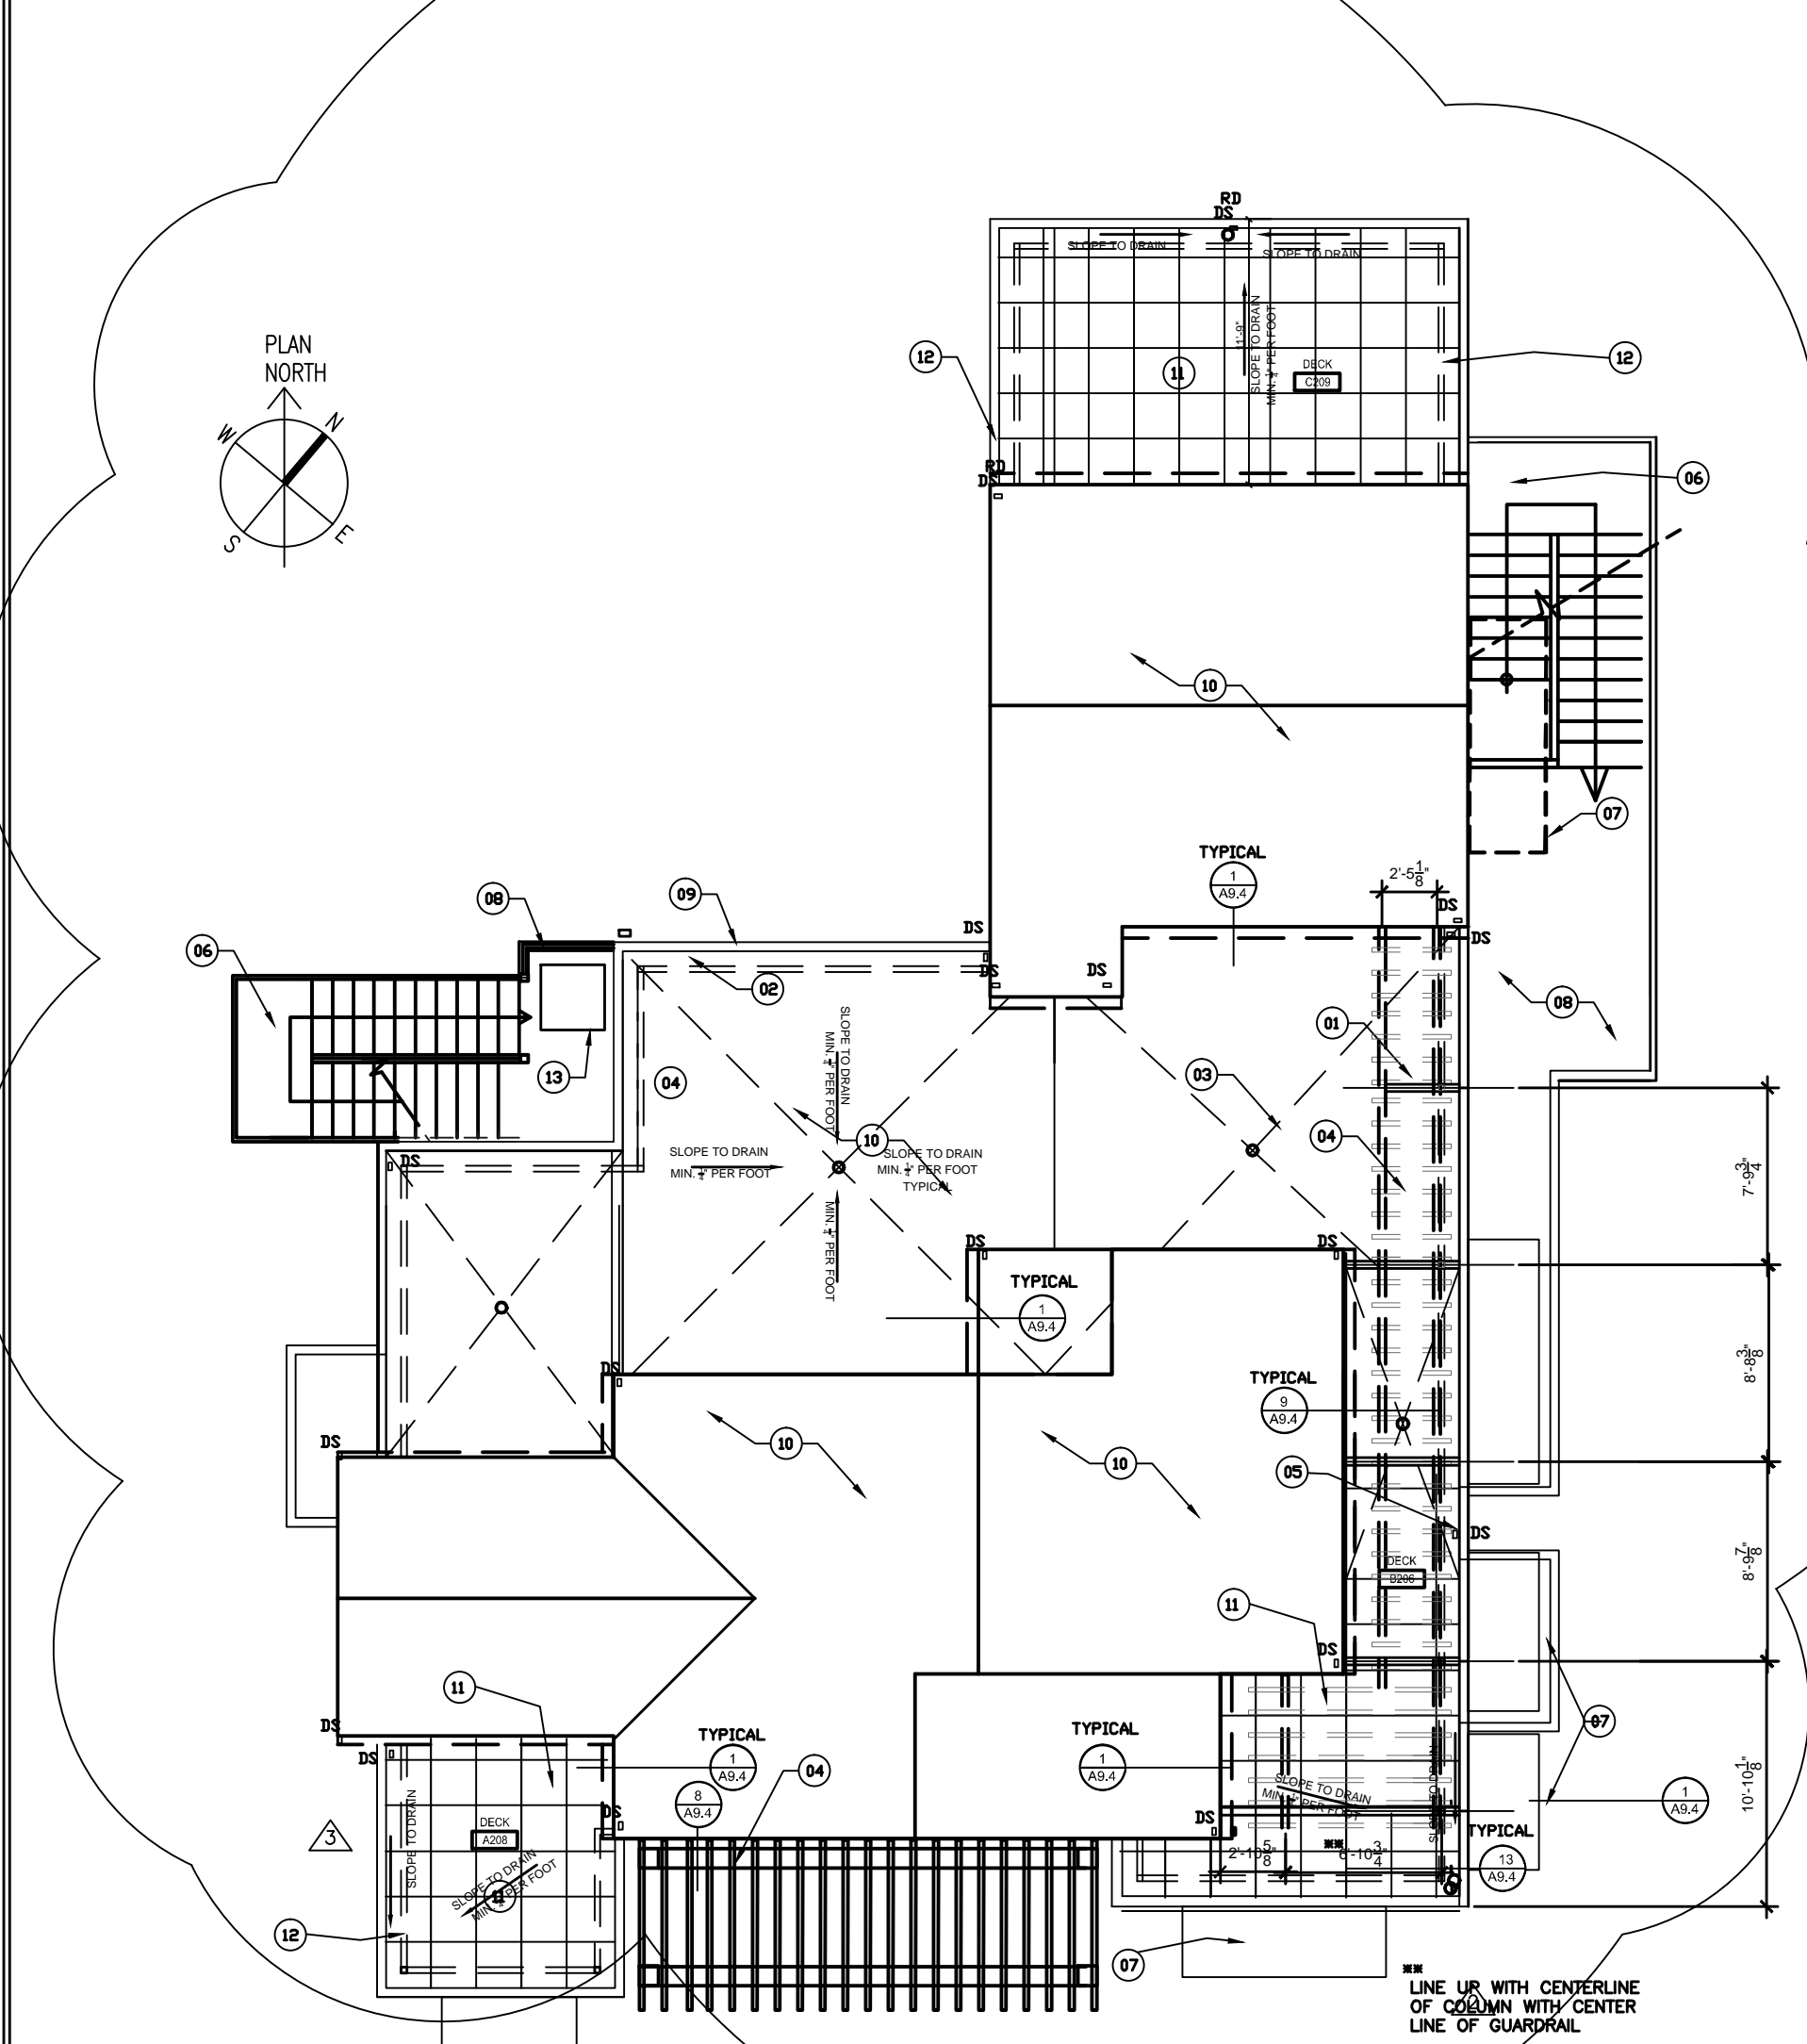COMMUNITY CENTER ROOF PLAN

SCALE 1/8" = 1'-0" SEE SHEET A2.26 FOR ENLARGED ROOF PLAN

KEYNOTES ROOF PLAN

- 01 ROOF CRICKET.
- 02 ROOF LINE OF PARAPET.
- 03 BUILT UP ROOF WITH 90 LB. CAP SHEET
- 04 CLASS B ROOF SYSTEM. PROVIDE MIN 1/4" SLOPE @ VALLEY
- 05 TRELLIS W/ WOOD FRAME WITH STEEL POSTS
- 06 THROUGH WALL SCUPPER AND 3/4" DOWN SPOUT. TERMINATE AT DOWNSPOUT AT SPLASH BLOCK.
- 07 EXTERIOR STAIRS BELOW
- 08 FABRIC AWNING BELOW.
- 09 DECKING BELOW.
- 10 CORNICE AT EDGE OF PARAPET.
- 11 ASPHALT SHINGLE ROOF
- 12 ROOF DECK
- 13 METAL RAIL
- 14 CHAIR LIFT



GENERAL NOTES

- A. ALL RAIN WATER LEADERS & DOWNSPOUT BE CONNECTED TO STORM DRAIN SYSTEM.
- B. ALL DIMENSIONS ARE TO FACE OF STUDS OR CENTER OF COLUMN LINE AS APPLICABLE, UNON

LEGEND

- CRICKET. SEE DET. SHEET A9.3

WHEELCHAIR LIFT DETAILS

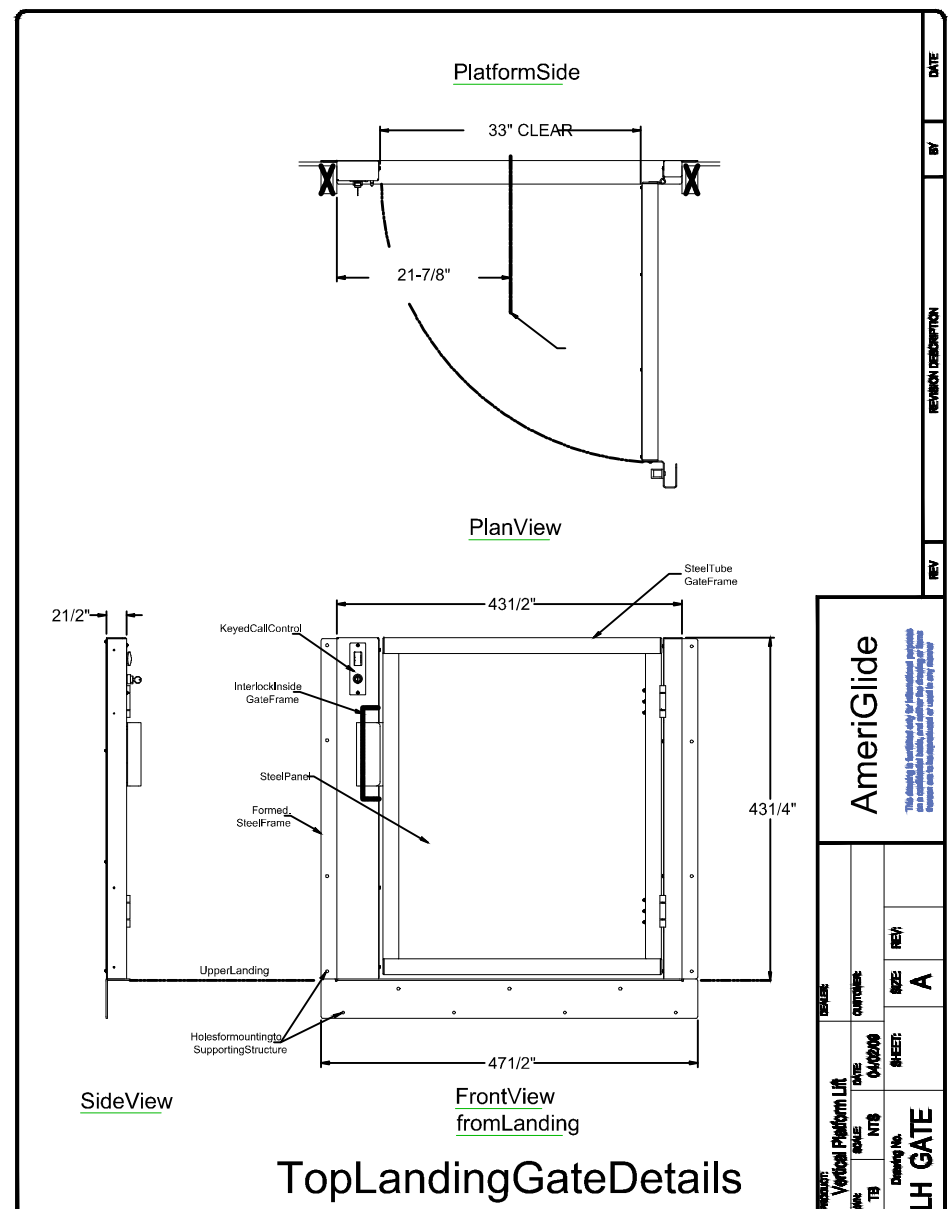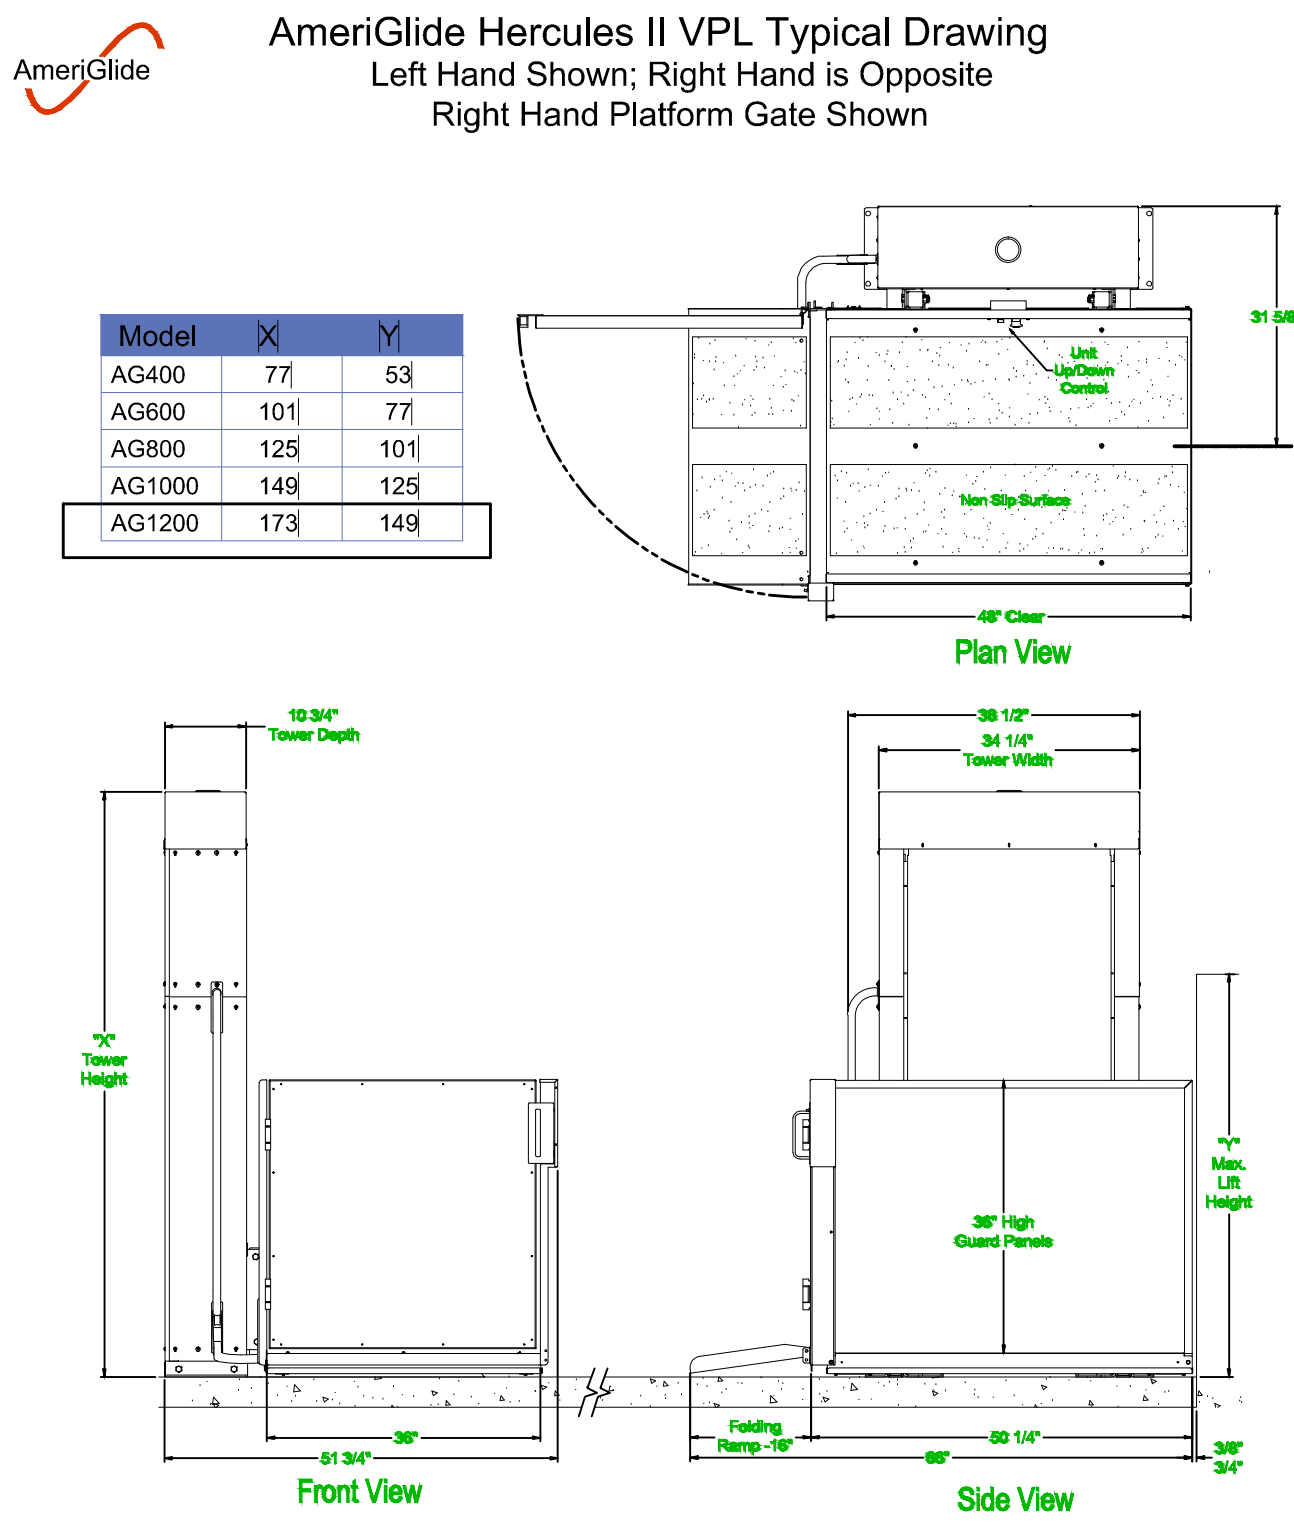

DRAWINGS FOR REVIEW AND BIDDING PURPOSES ONLY-NOT FOR CONSTRUCTION. SUBMIT RFI FOR CONFLICTS OR INFORMATION NOT SHOWN

KEYNOTES ELEVATIONS

- 01 3 COATS OF CEMENT PLASTER SYSTEM
- 02 2" ALUMINUM REVEAL
- 03 EPS TRIM G.I. CAPPING
- 04 EPS TRIM
- 05 FABRIC AWNING
- 06 G.I. SCUPPER CONDUCTOR
- 07 METAL & WOOD TRELLIS
- 08 METAL STAIRS
- 09 WOOD TRELLIS
- 10 METAL STAIRS
- 11 VINYL WINDOW. SEE WINDOW SCHEDULE
- 12 ALUMINUM STOREFRONT SYSTEM. SEE WINDOW SCHEDULE
- 13 EXTERIOR WOOD DOORS, SEE DOOR SCHEDULE
- 14 STEEL RAILING.
- 15 VINYL WINDOW
- 16 MTL. RAILING.
- 17 LOUVER DOOR
- 18 STL. COLUMN. SED
- 19 PLANTER BOX.

GENERAL NOTES

- A. ALL DIMENSIONS ARE TO FACE OF STUD OR CENTERLINE OF PARTITION WALL, INTERIOR COLUMN/ WINDOW/ DOOR UNLESS OTHERWISE NOTED.
- B. DETAILS ARE KEYED AND NOTED 'TYPICAL' ONLY ONCE ON THE PLANS WHEN THEY FIRST OCCUR, AND ARE REPRESENTATIVE OF SIMILAR CONDITIONS THROUGHOUT, UNLESS OTHERWISE NOTED.
- C. FOR DOOR AND WINDOW KEYS REFER TO DOOR AND WINDOW SCHEDULE.

LEGEND

- ONE HOUR RATED WALL
- INTERIOR FULL HT. PARTITION
- INTERIOR BEARING PARTITION WALL
- EPS TRIM - MOLDING

REVISIONS		BY
9/26/2011	PLAN CHECK	G.O.
1/09/2014		STF
GUARDAIL REVISED		
1/09/2014		
REVISED ROOF DRAINAGE		
1-10-2014		
REVISED ROOF DRAINAGE, WINDOWS AT HALLWAY		


JOSEPH OAKLEY  
No. 15457  
REN. 9-30-15  
STATE OF CALIFORNIA

OAKLEY & OAKLEY  
ARCHITECT, CIVIL & STRUCTURAL ENGINEERS  
7700 EDGEWATER DRIVE, SUITE 615  
VALLEJO, CA 94560  
TEL: 925.602.6021  
FAX: 925.602.6043

PROJECT TITLE: COMMUNITY CENTER  
HARBOR PARK APARTMENTS  
969 PORTER STREET, VALLEJO, CA 94560  
DRAWING TITLE: LEFT ELEVATION AND ROOF PLAN  
CHAIR LIFT DETAILS

Date: 04/10/2012  
Scale: 3/16" = 1'-0"  
Drawn: STAFF  
Checked: RY  
Job No.: 2011-09  
Sheet: A2.25  
Of: Sheets

Jan 28, 2014 - 12:27am \\server\server drive d\Year 2011 Jobs\2011-09-3 - Community Bldg REVISED DRAWINGS FOR NEGOTIATED CONTRACT WITH WE LYONS\ARCHITECT\UA21-A225-REVISED FOR WELYONS BID FOR DOOR SCHEDULE 1-14-2014.dwg

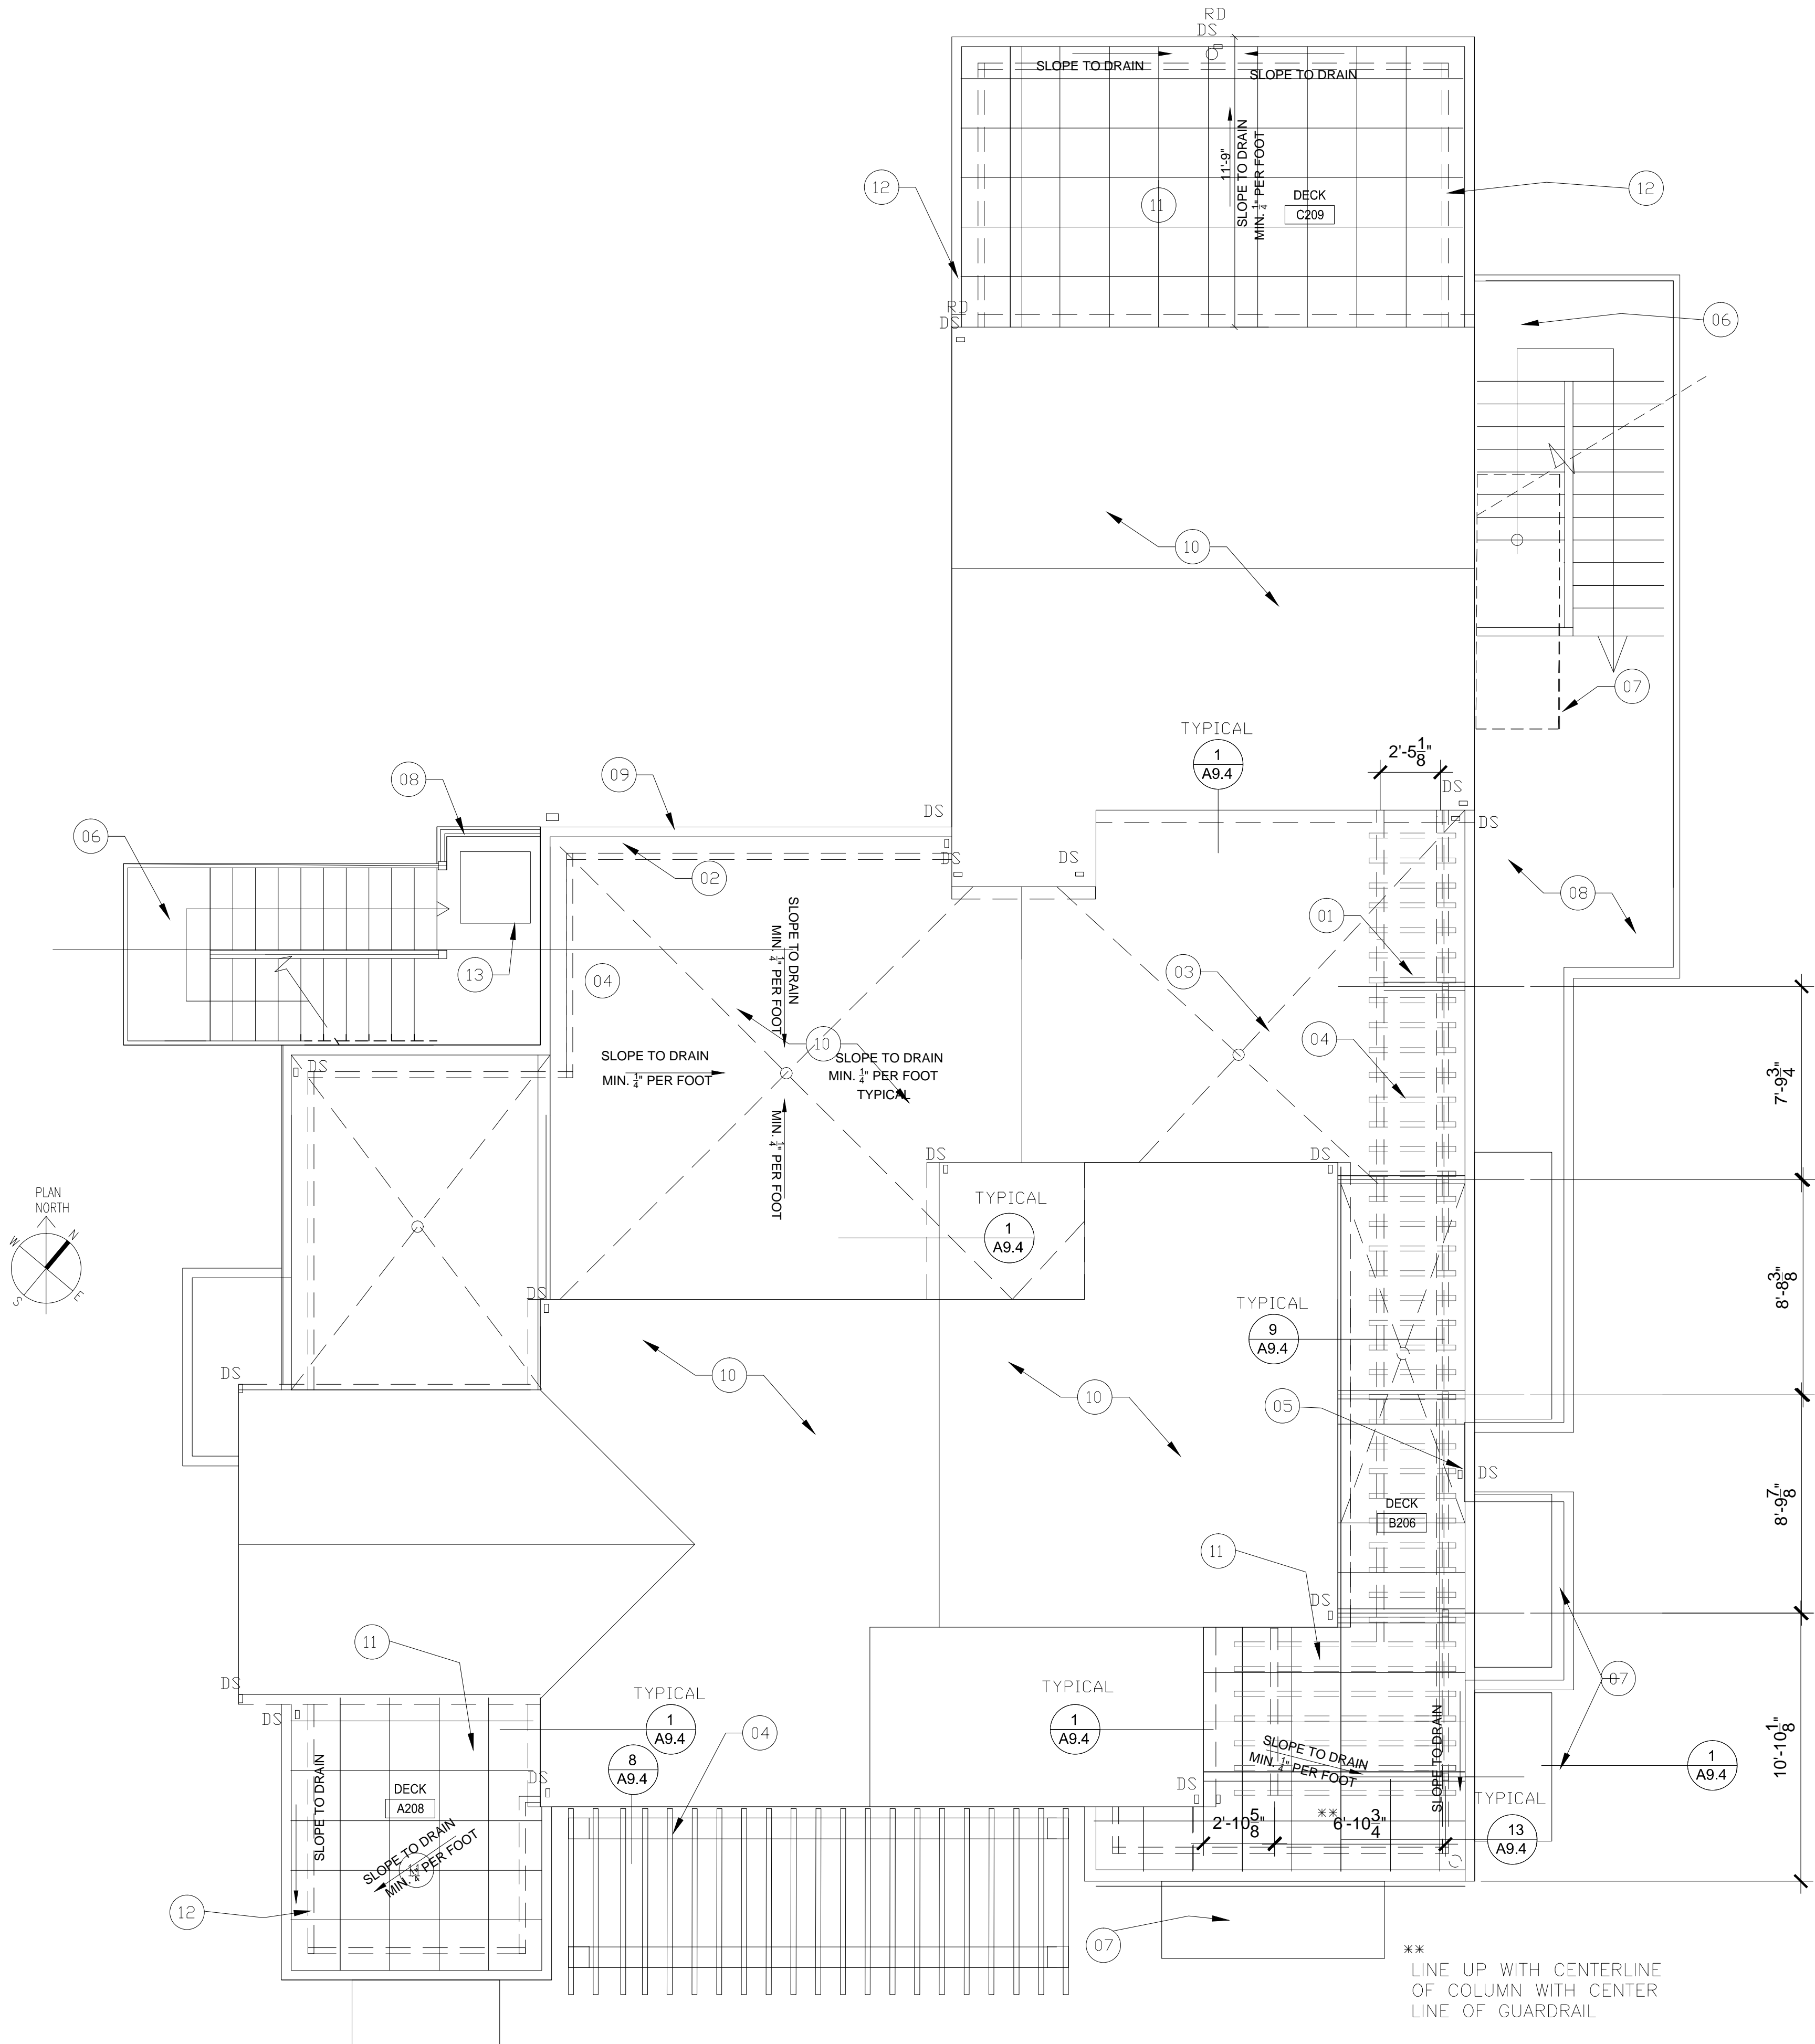

01 COMMUNITY CENTER ROOF PLAN

## GENERAL NOTES

- A. ALL DIMENSIONS ARE TO FACE OF STUD OR CENTERLINE OF PARTITION WALL, INTERIOR COLUMN/ WINDOW/ DOOR UNLESS OTHERWISE NOTED.
- B. DETAILS ARE KEYED AND NOTED "TYPICAL" ONLY ONCE ON THE PLANS WHEN THEY FIRST OCCUR, AND ARE REPRESENTATIVE OF SIMILAR CONDITIONS THROUGHOUT, UNLESS OTHERWISE NOTED.
- C. FOR DOOR AND WINDOW KEYS REFER TO DOOR AND WINDOW SCHEDULE.


## LEGEND

- ONE HOUR RATED WALL
- INTERIOR FULL HT. PARTITION
- INTERIOR BEARING PARTITION WALL
- EPS TRIM - MOLDING

## KEYNOTES ROOF PLAN

- 01 BEAM AT ROOF TRELLIS.
- 02 ROOF LINE OF PARAPET.
- 03 BUILT UP ROOF WITH 90 LB. CAP SHEET  
CLASS B ROOF SYSTEM. PROVIDE MIN 1/4" SLOPE @ VALLEY
- 04 TRELLIS W/ WOOD FRAME WITH STEEL POSTS
- 05 THROUGH WALL SCUPPER AND 3X4 DOWN SPOUT. TERMINATE AT DOWNSPOUT AT SPLASH BLOCK.
- 06 EXTERIOR STAIRS BELOW
- 07 FABRIC AWNING BELOW.
- 08 DECKING BELOW.
- 09 CORNICE AT EDGE OF PARAPET.
- 10 ASPHALT SHINGLE ROOF
- 11 ROOF DECK
- 12 METAL RAIL
- 13 CHAIR LIFT

REVISIONS	BY
9/26/2011 - PLAN CHECK	G.O.
1/09/2014	STF
GUARDAIL REVISED	
1/09/2014	
REVISED ROOF DRAINAGE	
1-10-2014	
REVISED ROOF DRAINAGE, WINDOWS AT HALLWAY	
1-26-2014	
ADDED ENLARGED PLAN SHEET	






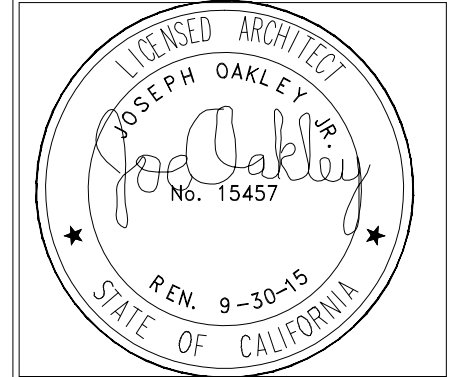


**OAKLEY & OAKLEY**  
ARCHITECT, CIVIL & STRUCTURAL ENGINEERS  
7000 N. DECEMBER DRIVE, SUITE 615  
DALLAS, TEXAS 75243  
PHONE: 214.662.6028  
FAX: 214.662.6043

PROJECT TITLE:  
**COMMUNITY CENTER**  
HARBOR PARK APARTMENTS  
969 PORTER STREET, VALLEJO, CA 94560

DRAWING TITLE:  
**ENLARGED ROOF PLAN**




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Job No.:	2011-09
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Of	Sheets

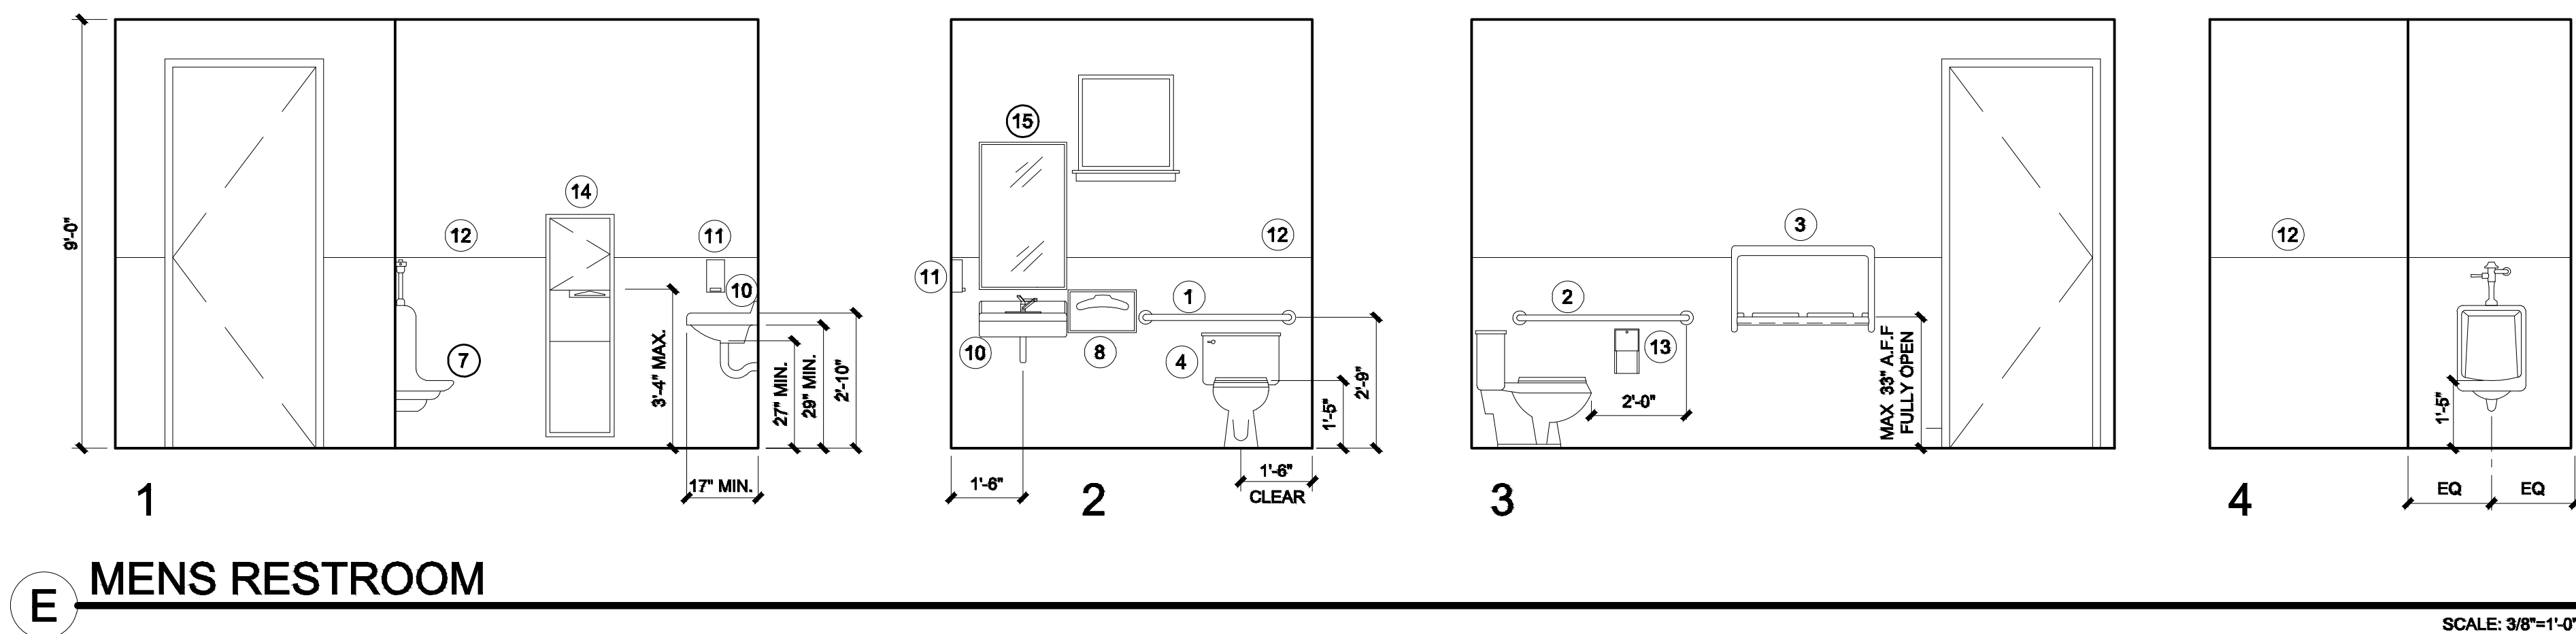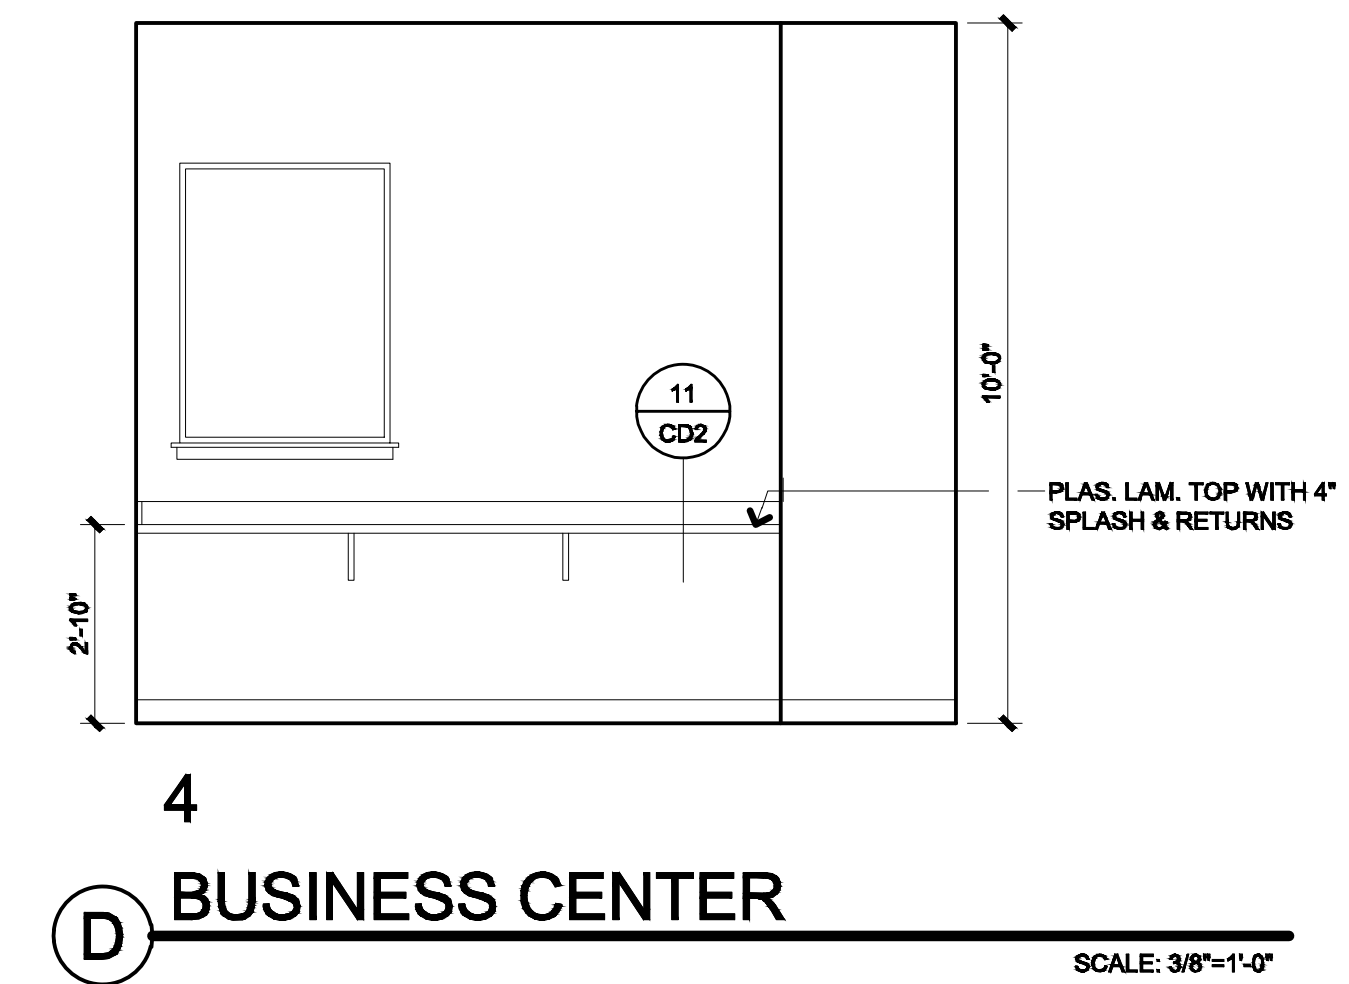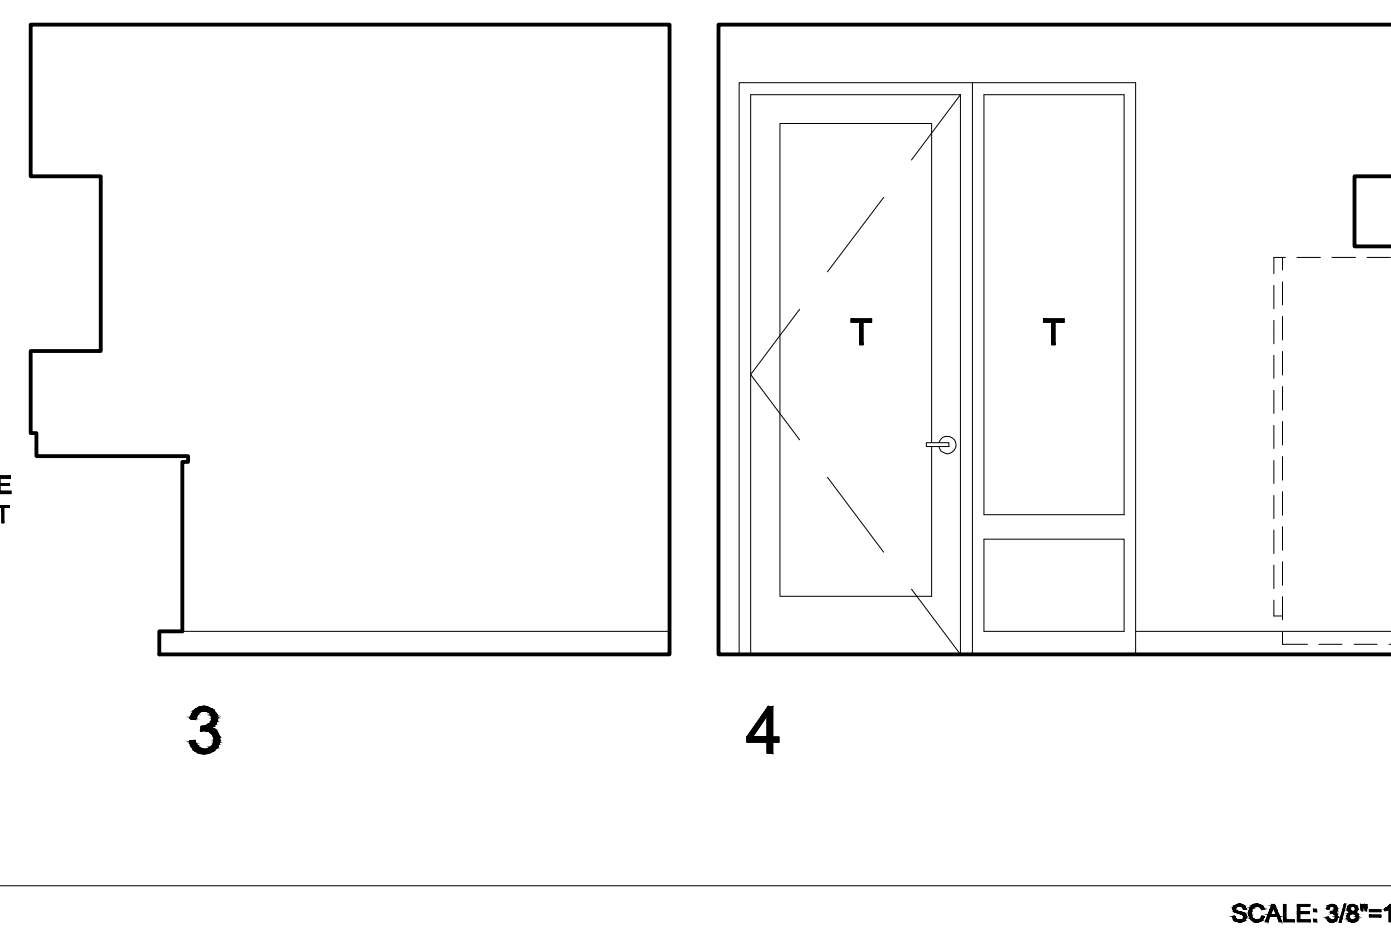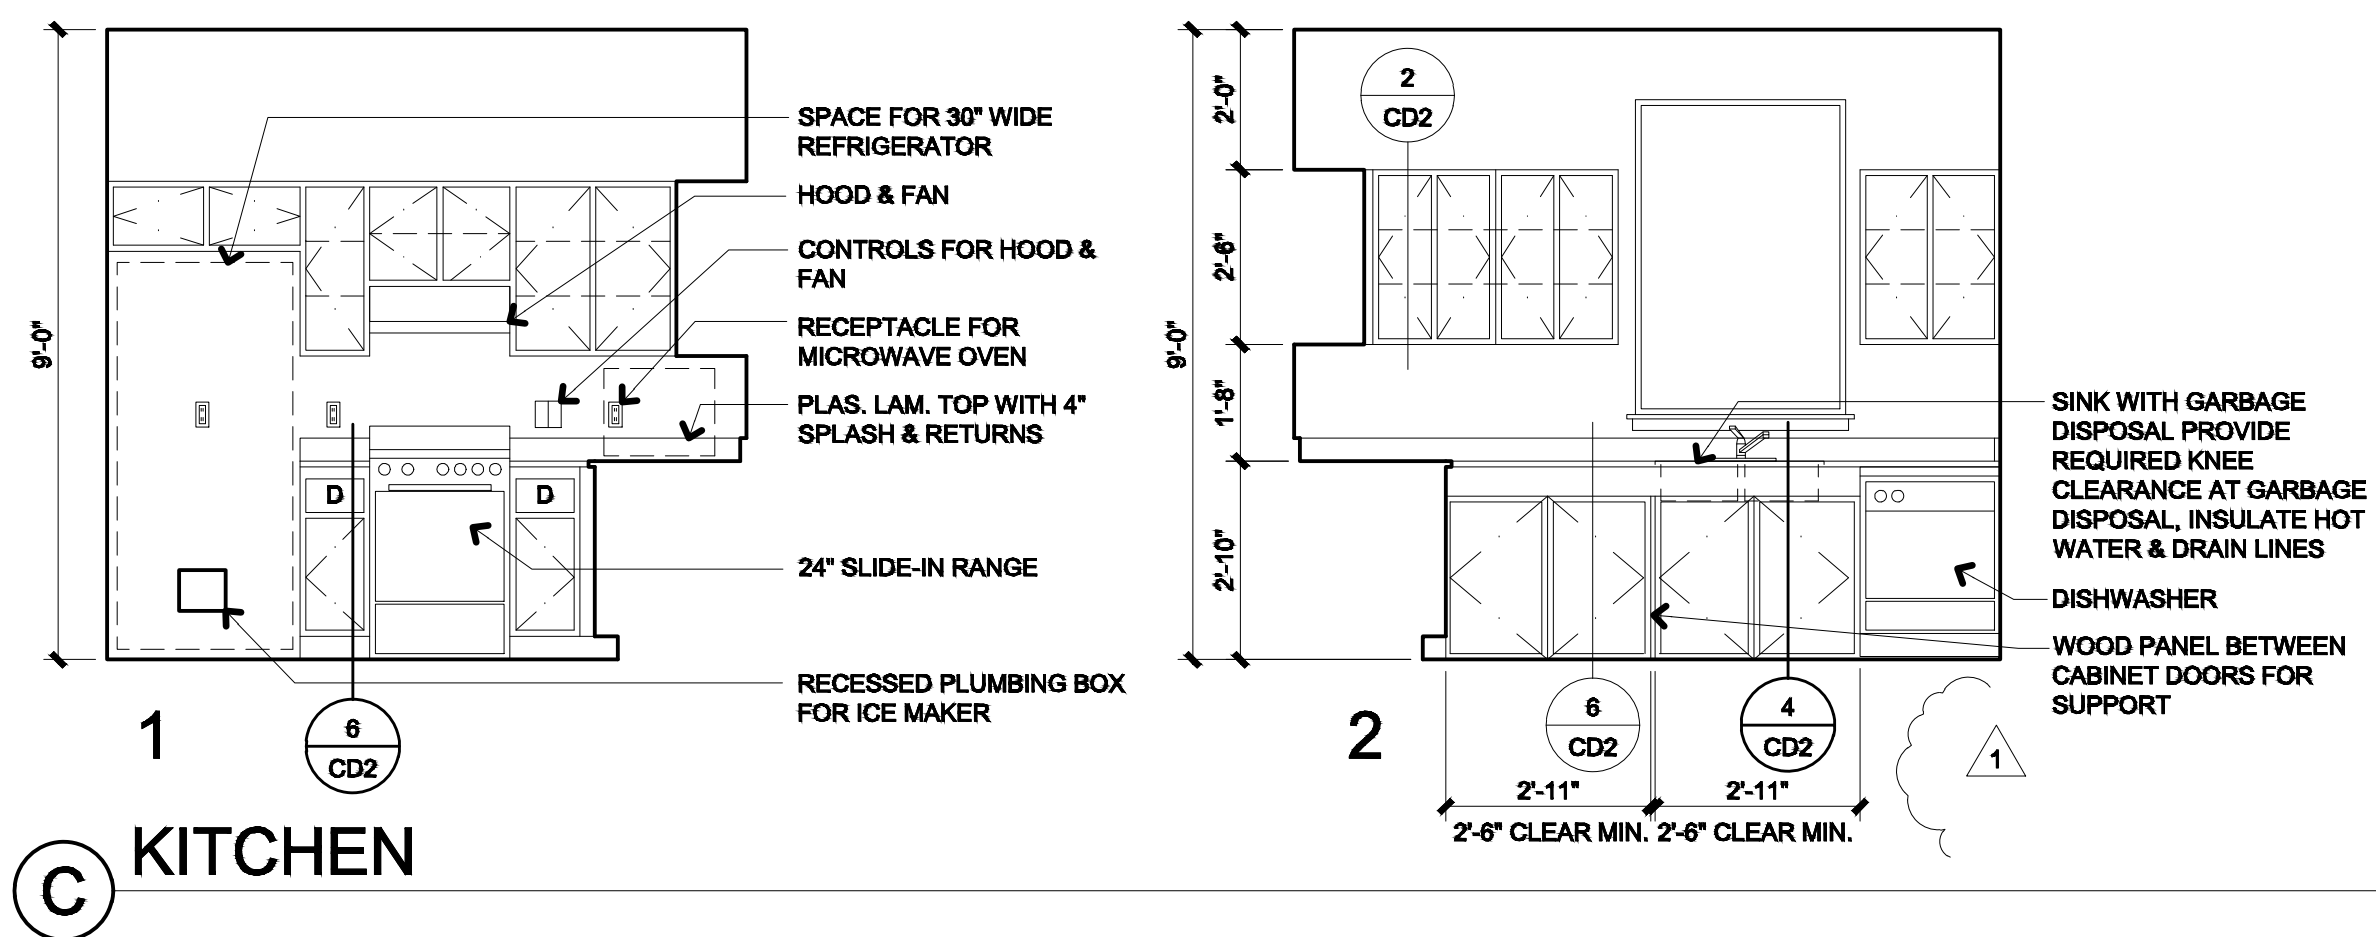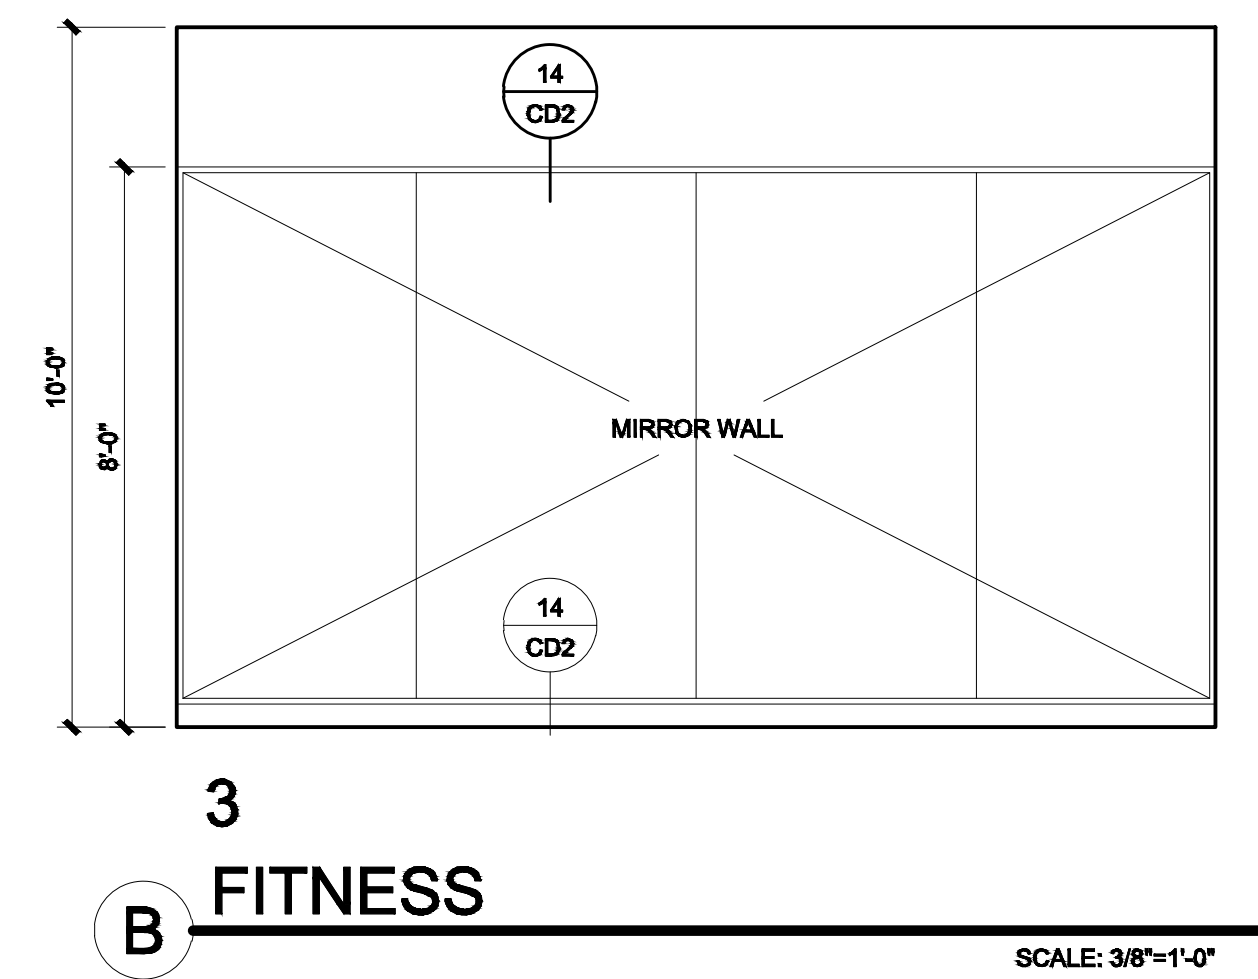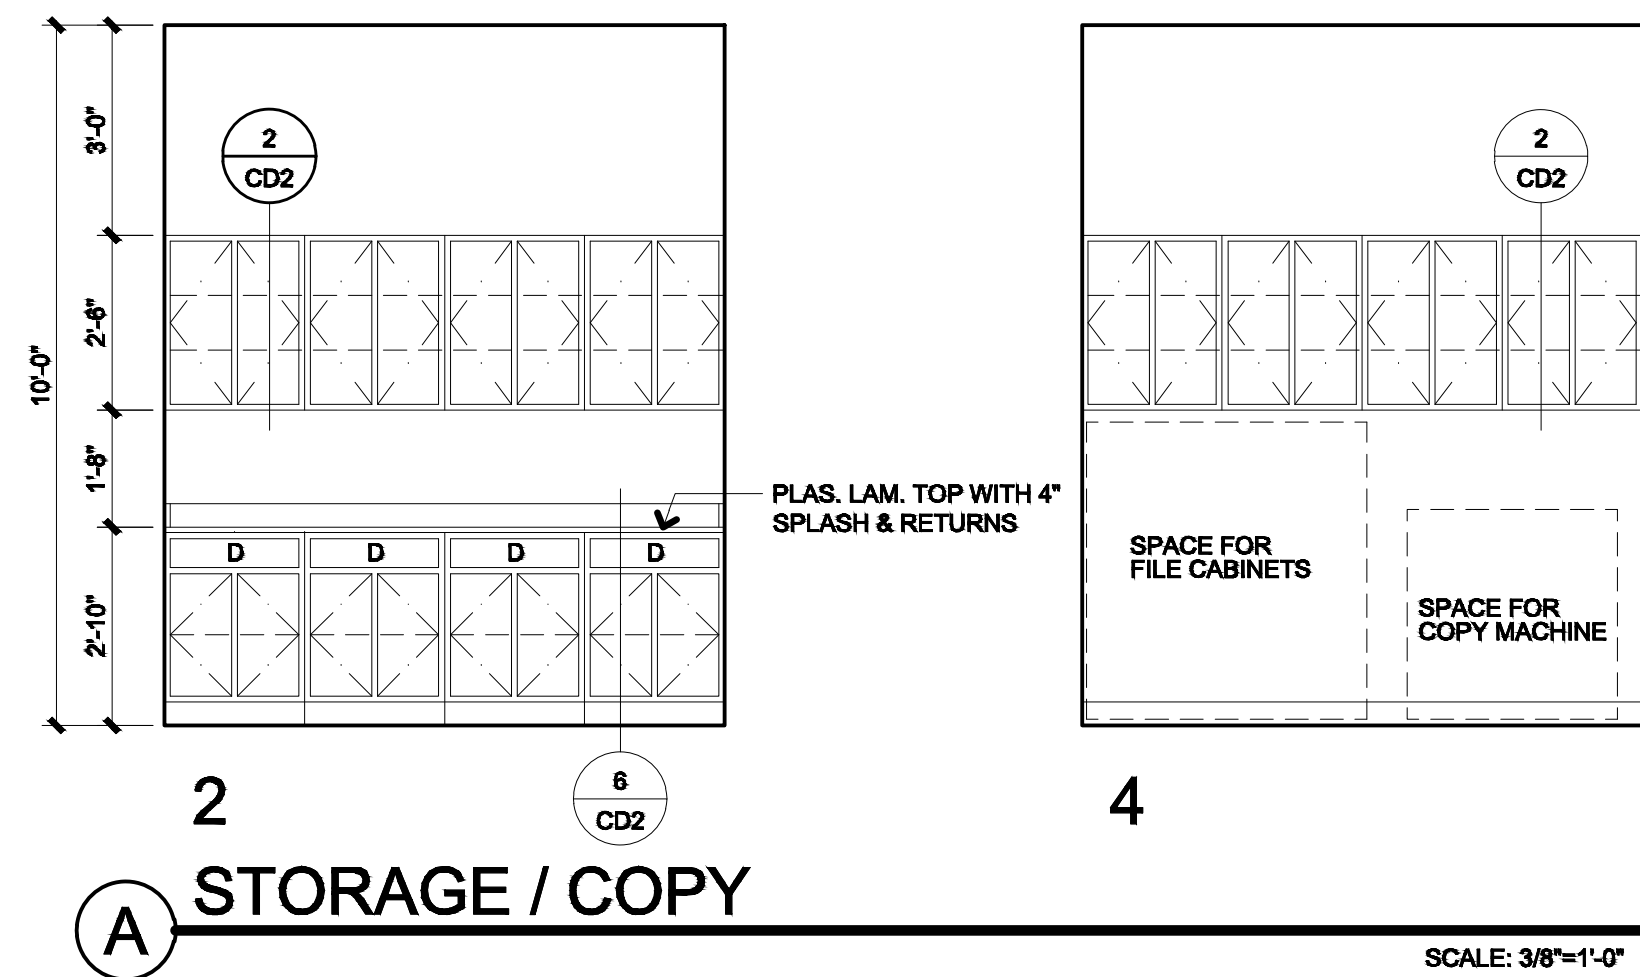

- |     |  |   |   |
|-----|--|---|---|
| ①   | 36" GRAB BAR AT +33" A.F.F.  | ⑨ | B-270 SANITARY NAPKIN DISPOSAL                  |
| ②   | 42" GRAB BAR AT +33" A.F.F.  | ⑩ | SINK  |
| ③   | B-2210 DIAPER CHANGING STATION,<br>PER MFR SPECS, BOTTOM AT 26 1/2" A.F.F. | ⑪ | B-2112 SURFACE MOUNTED SOAP DISPENSER           |
| ④   | WATER CLOSET   | ⑫ | TILE WAINSCOT                                   |
| ⑤   | 60" TURNING RADIUS   | ⑬ | B-2888 TOILET TISSUE DISPENSER                  |
| ⑥   | 30" x 48" CLEAR SPACE AT SINK  | ⑭ | B-3944 PAPER TOWEL DISPENSER & TRASH RECEPTACLE |
| ⑥.1 | 36" x 48" CLEAR SPACE AT URINAL  | ⑮ | MIRROR - MOUNT BOTTOM AT 40" A.F.F.             |
| ⑦   | URINAL (HC) MOUNTED AT 17" TO RIM OF URINAL                                |   |   |
| ⑧   | B-4221 TOILET SEAT COVER DISPENSER   |   |   |


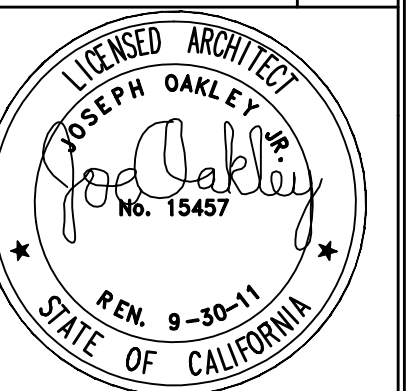
SEE SHEETS X1, X2 AND X3  
FOR SPECIFIC HANDICAPPED  
REQUIREMENTS

PROVIDE BLOCKING AS REQUIRED FOR ALL WALL MOUNTED  
FIXTURES, AND ALL HANDICAPPED RELATED ITEMS

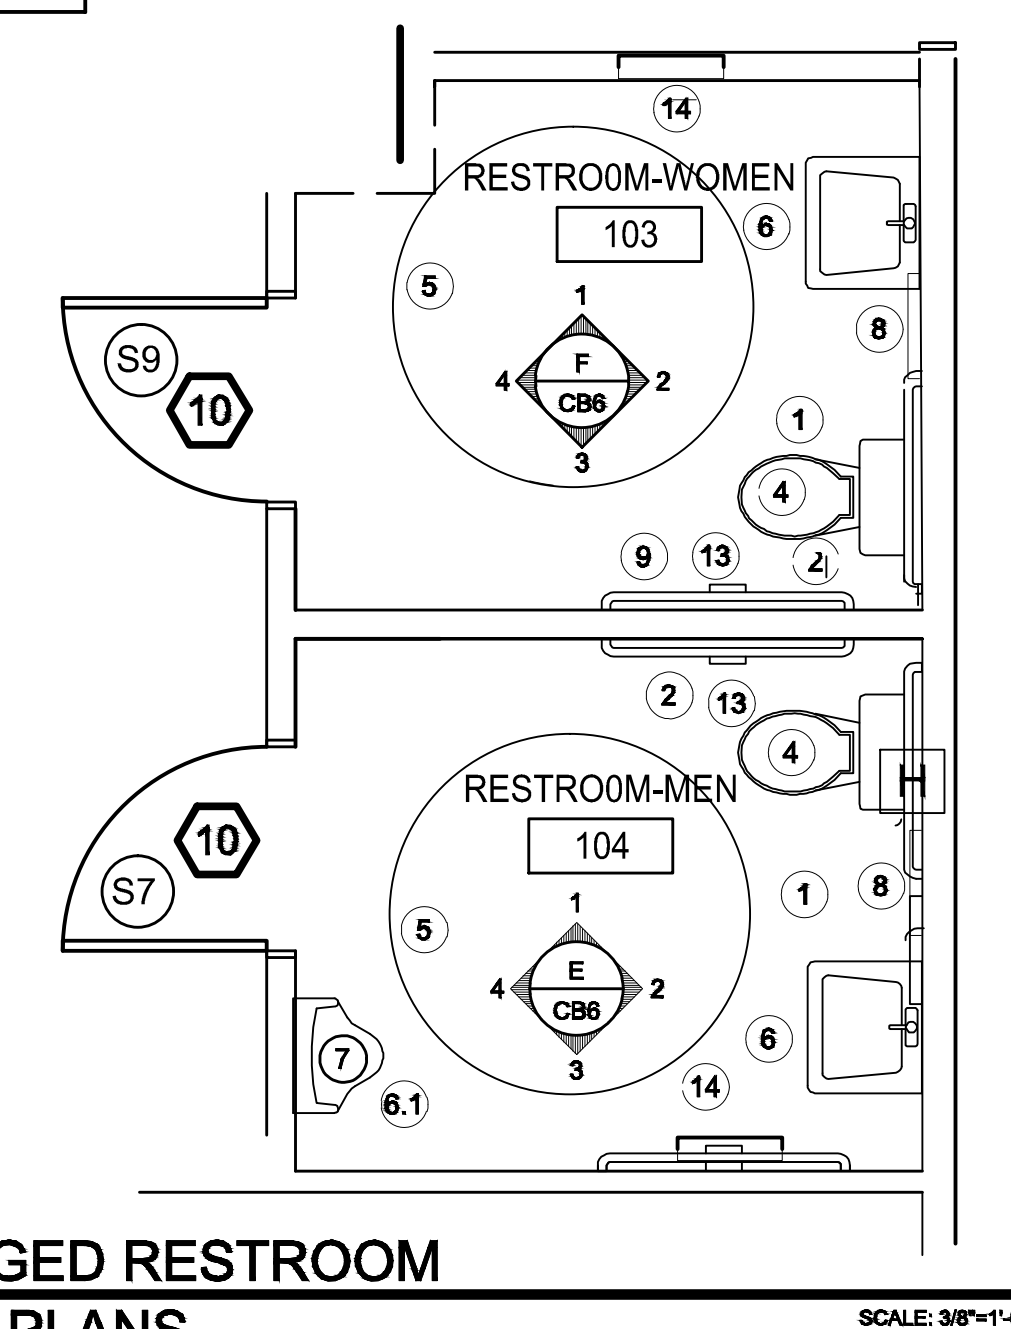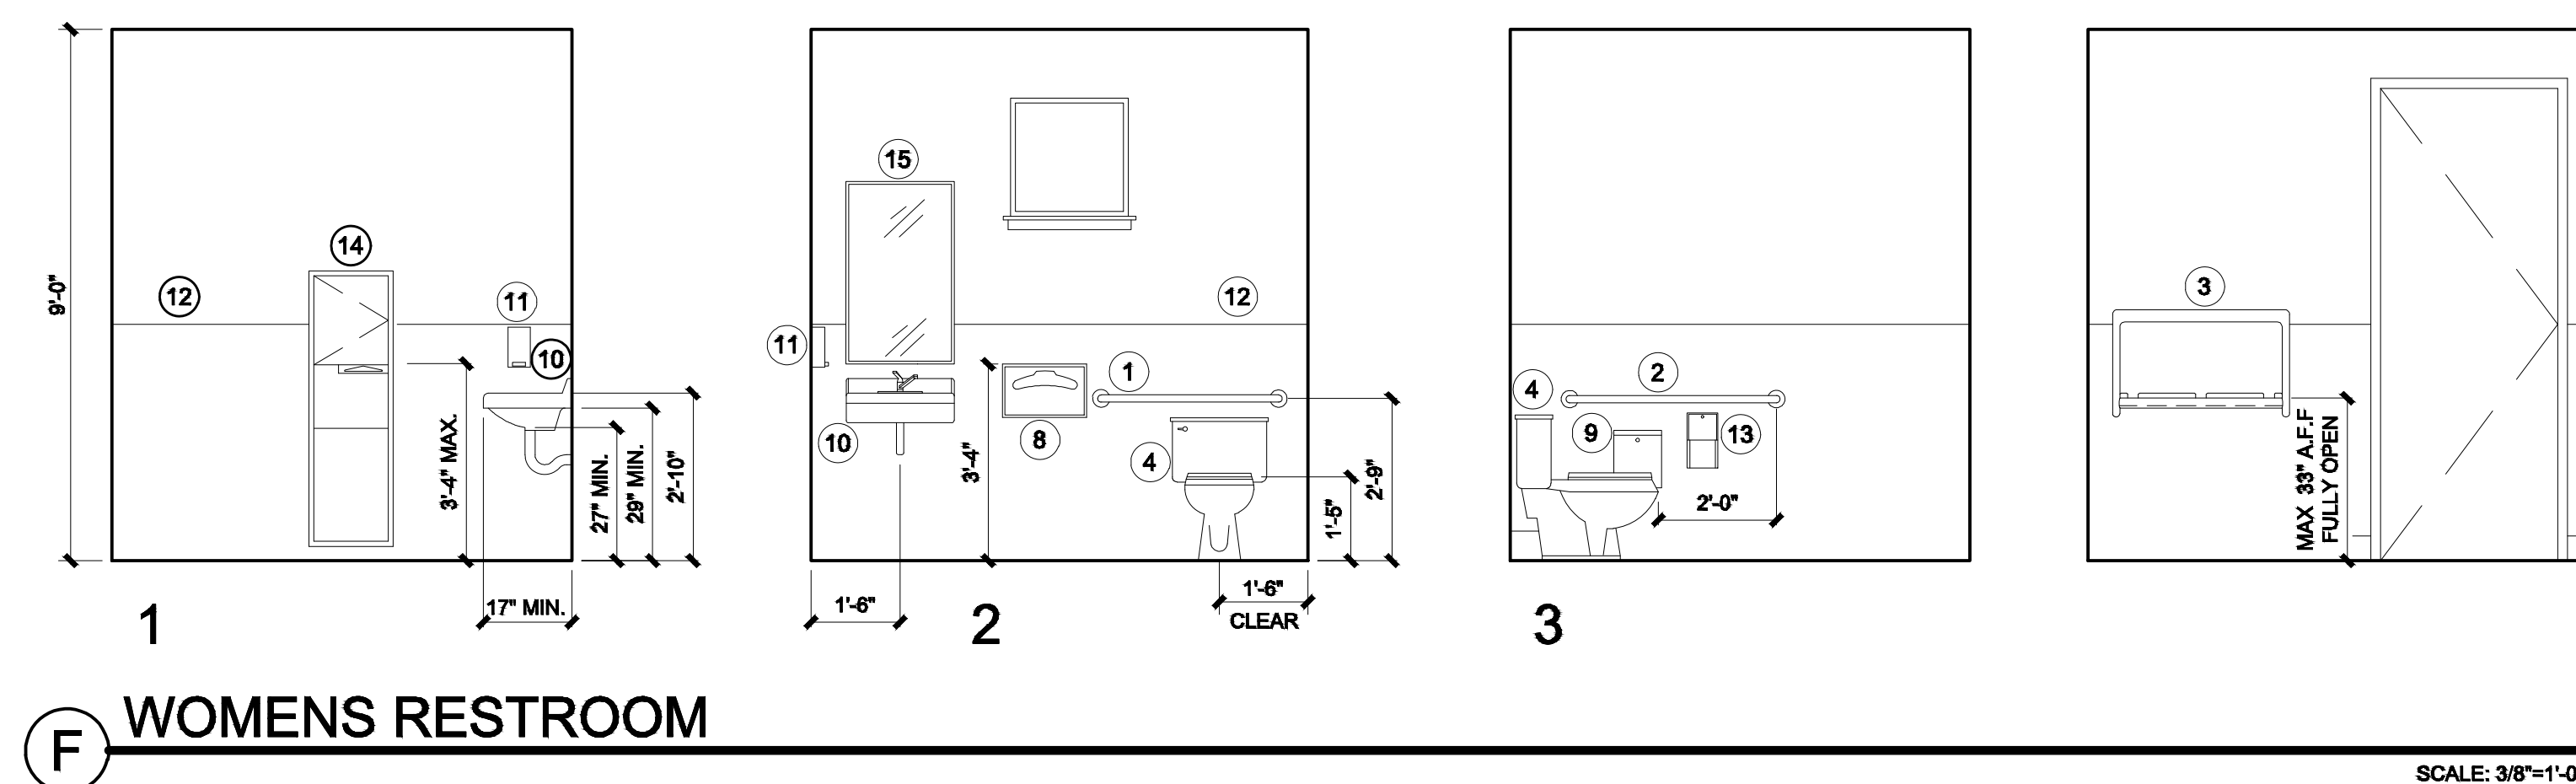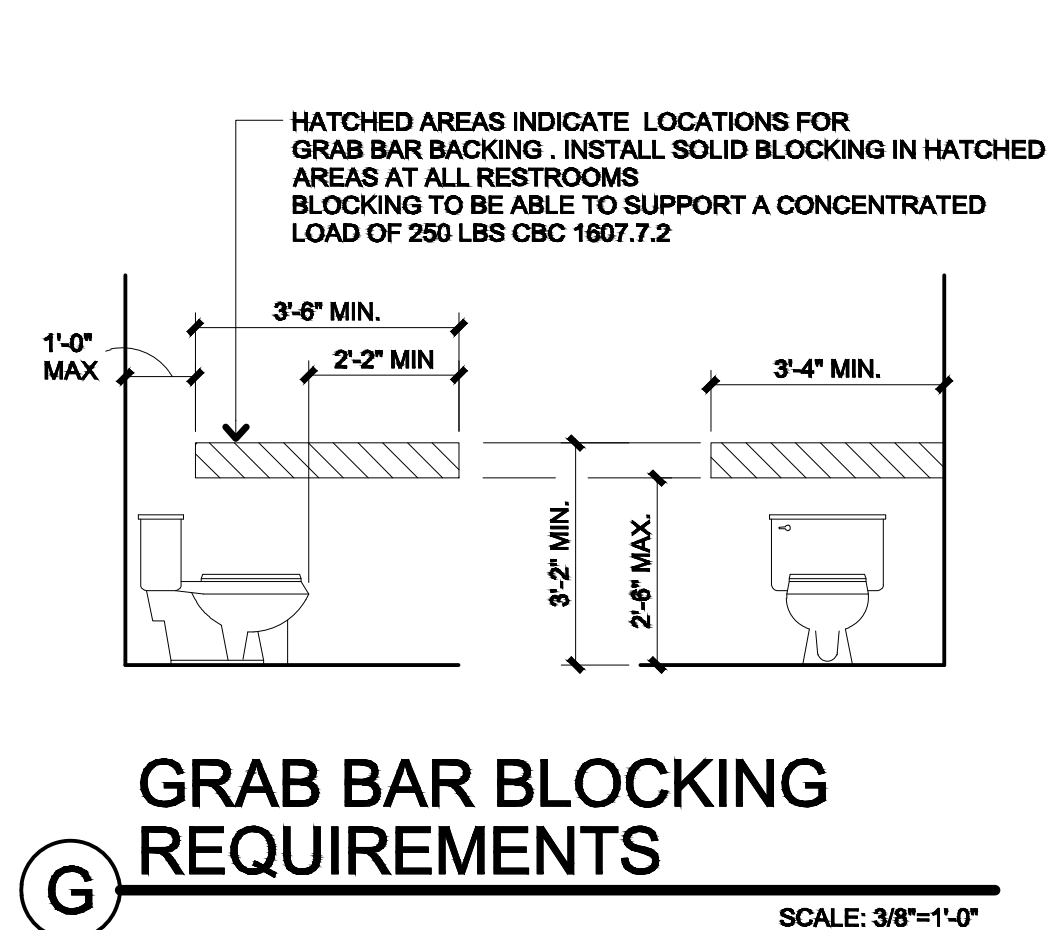

- ## 1 ENLARGED RESTROOM FLOOR PLANS

REVISIONS	BY
26/2011 - PLAN CHECK	G.O.



**OAKLEY & OAKLEY**  
 ARCHITECTS & STRUCTURAL ENGINEERS  
 10000 RIVINGTON DRIVE, SUITE 615  
 AKLAND, CALIF. 94021  
 415-562-6028  
 FAX 415-562-6043

COMMUNITY CENTER  
HARBOR PARK APARTMENTS  
969 PORTER STREET, VALLEJO, CA 94560

DRAWING TITLE:  
UNIT A FLOOR PLAN &  
INTERIOR ELEVATIONS





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File:	AS NOTED
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Sheet:

**A2.29**

f Sheets





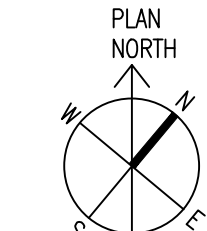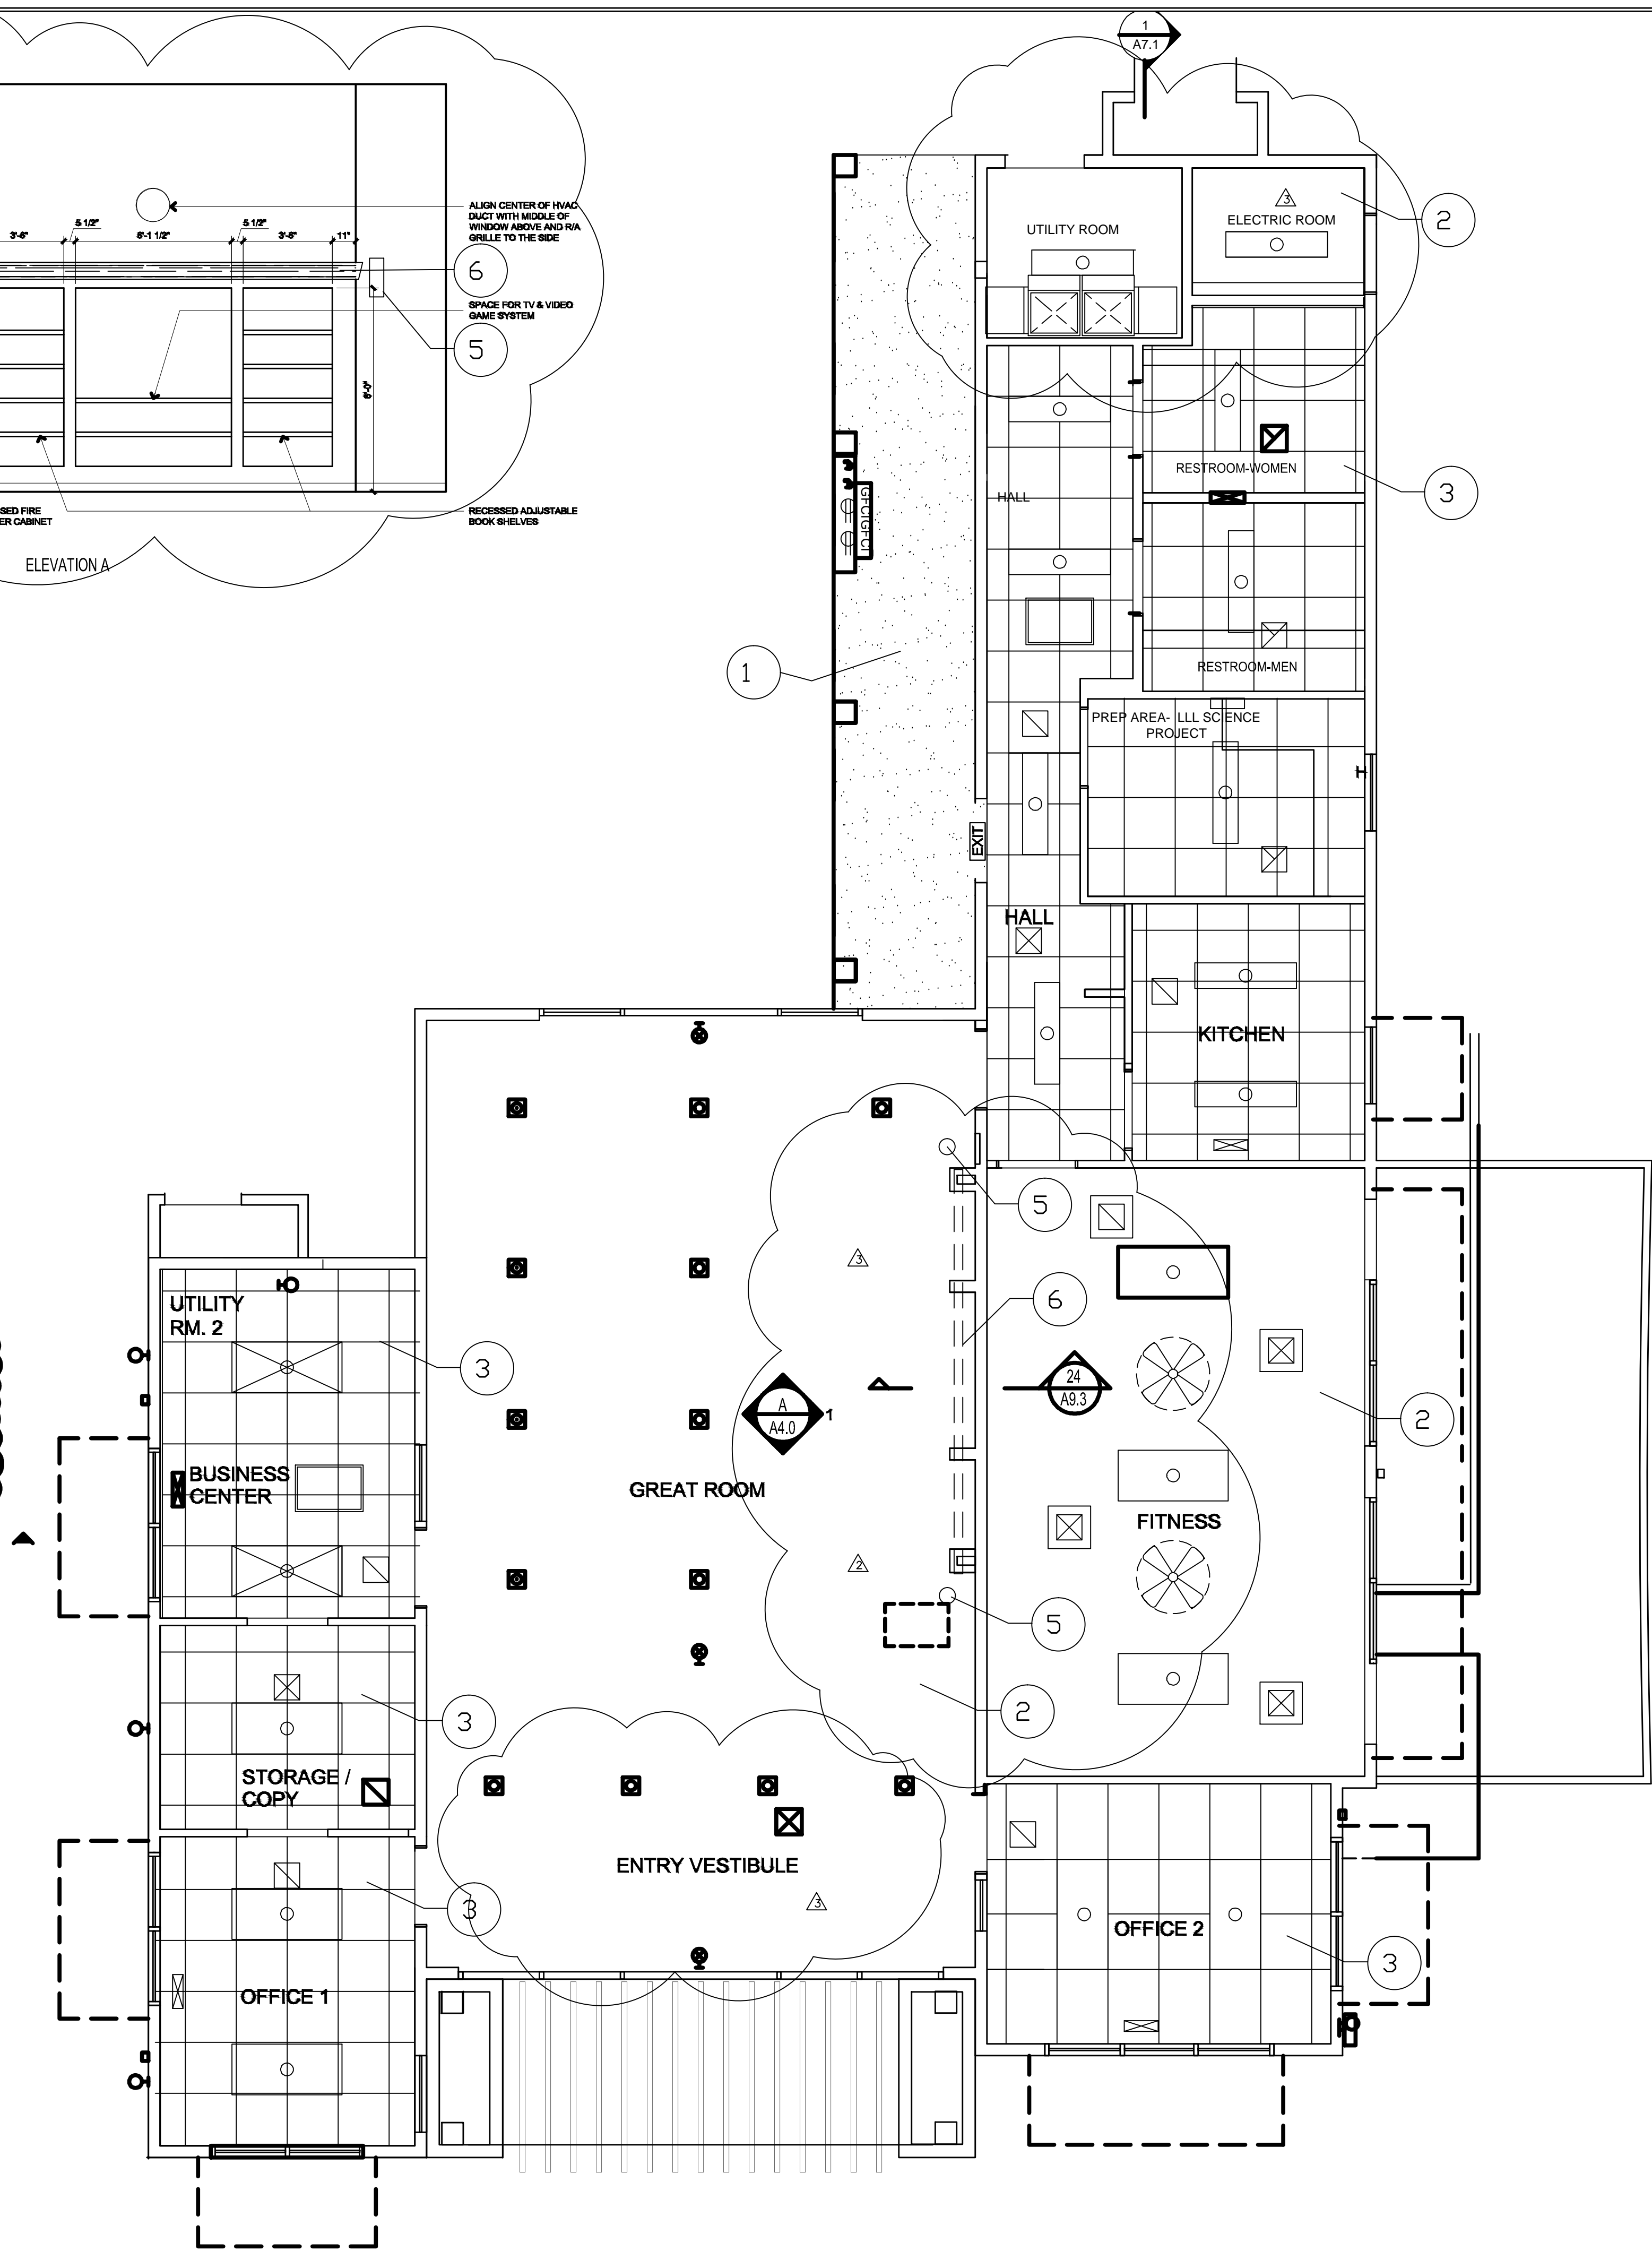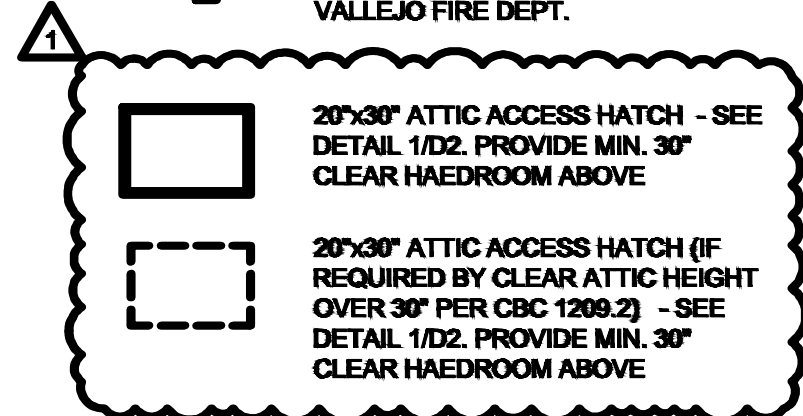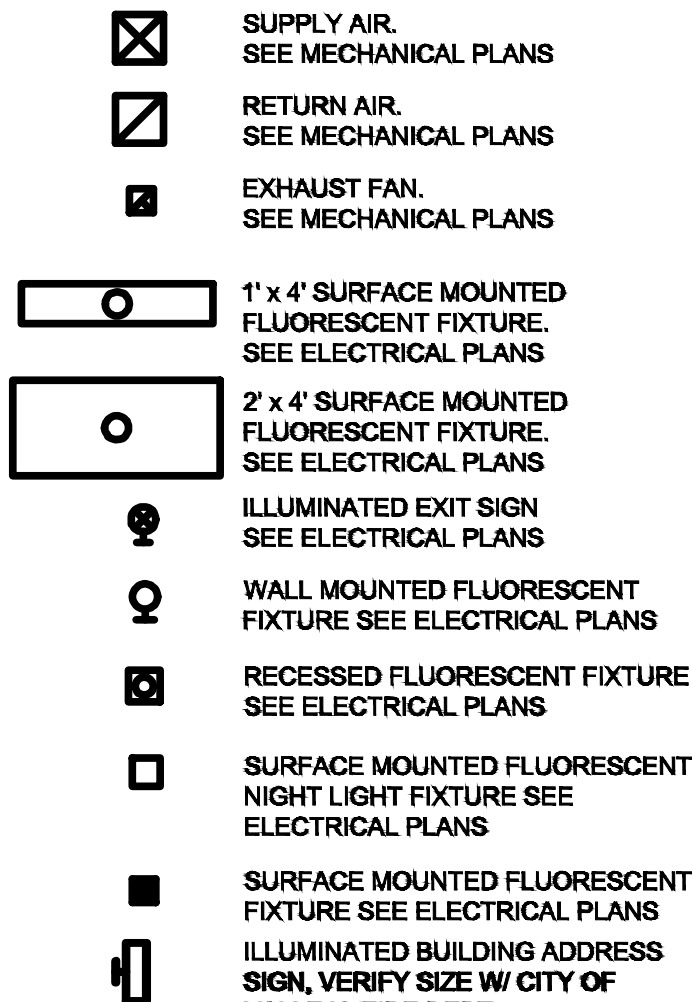



GENERAL NOTES
---------------

1. STUCCO SOFFIT
2. 1 HOUR RATED GYPSUM BOARD CEILING FINISH
3. NON RATED SUSPENDED CEILING
4. PROVIDE 1 HOUR FIRE DAMPERS AT OPENINGS AT 1 HOUR RATED CEILING
5. SCONCE LIGHTING FIXTURE
6. TROUGH LIGHTING-SINGLE LINE FLOURESCENT FIXTURE WITH 2X12 WOOD FACE, 2X8 TROUGH BOTTOM

- A. ALL DIMENSIONS ARE TO FACE OF STUD OR CENTERLINE OF PARTITION WALL, INTERIOR COLUMN/ WINDOW/ DOOR UNLESS OTHERWISE NOTED.
- B. DETAILS ARE KEPT AND NOTED "TYPICAL" ONLY ONCE ON THE PLANS WHEN THEY FIRST OCCUR, AND ARE REPRESENTATIVE OF SIMILAR CONDITIONS THROUGHOUT, UNLESS OTHERWISE NOTED.
- C. PROVIDE WATER-RESISTANT GYP. BOARD AT ALL WET WALL LOCATIONS.
- D. FOR DOOR AND WINDOW KEYS REFER TO DOOR AND WINDOW SCHEDULE. SEE A9.1
- E. REFER TO INTERIOR ELEVATION FOR CABINETS CALLOUTS. SEE SHEET A2.3, A2.4 & A2.5
- F. FOR ALL TOILETS ACCESSORIES & HEIGHTS REFER TO A2.3, A2.4 & A2.5
- G. FOR FINISH FLOOR REFER TO FINISH SCHEDULE A4.1.
- H. PROVIDE ACoustical SEALANT AT ALL WALLS AND CEILING CONDITION.
- I. PROVIDE 5/8" THK. GYP. BD. MOISTURE RESISTANT AT WET AREAS , BATHROOMS & KITCHEN SINK AREA.
- J. PROVIDE WD. BLOCKING BEHIND GYPSUM BD. PARTITION FOR ATTACHMENT FOR ALL FIXTURE, FITTINGS, ART WORK & ACCESSORIES.
- K. PROVIDE WD. BLOCKING AT CEILING FOR BLINDS AT WINDOW WHERE REQUIRED.
- L. GROUND AND FLOOR SURFACES AT ACCESSIBLE ROUTES TO BE SLIP RESISTANCE PER CBC, 1124.B
- M. SLOPE FLOOR DRAIN  $\frac{1}{4}"=1'-0"$  SEE PLUMBING DWGS.
- N. PROVIDE WD. BLOCKING IN WALL AT GRAB BAR, CABINETS, SHELVES, AND CEILINGS AS REQUIRED FOR WINDOW SHADING.
- O. PLYWOOD SHEAR WALL TO EXTEND FULL HEIGHT OF THE WALL. SSD.
- P. INTERIOR FINISHES CEILINGS & WALLS SHALL BE CLASSIFIED W/ASTME 84-TYPE "C" FLAMED SPREAD 76-200, SMOKE DEVELOPED AT 0-450. TESTED W/NFPA 886
- Q. INTERIOR TRIM SHALL HAVE A MIN. CLASS C FLAMED SPREAD & SMOKE DEVELOP INDEX WHEN TESTED W/ASTME-84 AND NOT TO EXCEED 10% OF AGGREGATE WALL OR CLG.
- R. REFER TO SHEET AX.0X FOR WALL TYPE LEGEND

## LEGEND

- |   |                                  |
|---|----------------------------------|
|  | ONE HOUR RATED WALL.             |
|  | INTERIOR FULL HT. PARTITION.     |
|  | INTERIOR BEARING PARTITION WALL. |
|  | FIRE EXTINGUISHER.               |

[illegible]

Jan 27, 2014 - 6:07pm \\SERVER\Server Drive D\Year 2011 Jobs\2011-09-3 - Community Bldg\REVISED DRAWINGS FOR NEGOTIATED CONTRACT WITH VE LYONS\ARCHITECT\UA4.11 Finish Plan And Finish Schedule.dwg

01 FINISH SCHEDULE-UNITS A, B ,C

SCALE: NO SCALE


NUMBER	NAME	FLOOR	CEILING	BASE	WALL				NOTES
					NORTH	SOUTH	EAST	WEST	
A201	LIVING ROOM	F1	C1	B4	W1, P1	W1, P1	W1, P1	W1, P1	
A202	DINING ROOM	F1	C1	B4	W1, P1	W1, P1	W1, P1	W1, P1	
A203	KITCHEN	F2	C1	B3	W1, P2	W1, P2	W1, P2	W1, P2	
A204	BEDROOM	F1	C1	B4	W1, P1	W1, P1	W1, P1	W1, P1	
A204A	CLOSET	F1	C1	B4	W1, P1	W1, P1	W1, P1	W1, P1	
A204AA	LAUNDRY	F2	C1	B3	W1, P2	W1, P2	W1, P2	W1, P2	
A205	BEDROOM	F1	C1	B4	W1, P1	W1, P1	W1, P1	W1, P1	
A205A	BATHROOM	F4	C1	B3	W1, P2	W1, P2	W1, P2	W1, P2	W2 AT TUBS/SHOWERS
A205B	CLOSET	F1	C1	B4	W1, P1	W1, P1	W1, P1	W1, P1	
A206	BEDROOM	F1	C1	B4	W1, P1	W1, P1	W1, P1	W1, P1	
A206A	BATHROOM	F4	C1	B3	W1, P2	W1, P2	W1, P2	W1, P2	W2 AT TUBS/SHOWERS
A206B	CLOSET	F1	C1	B4	W1, P1	W1, P1	W1, P1	W1, P1	
A207	DECK	F5	C1	---	---	---	---	---	
A207A	BATHROOM	F4	C1	B3	W1, P2	W1, P2	W1, P2	W1, P2	W2 AT TUBS/SHOWERS
A207B	CLOSET	F1	C1	B4	W1, P1	W1, P1	W1, P1	W1, P1	
A208	DECK	F5	---	---	---	---	---	---	DEXOTEX FINISH UNDER TILE
B201	LIVING ROOM	F1	C1	B4	W1, P1	W1, P1	W1, P1	W1, P1	
B202	DINING ROOM	F1	C1	B4	W1, P1	W1, P1	W1, P1	W1, P1	
B203	KITCHEN	F4	C1	B3	W1, P2	W1, P2	W1, P2	W1, P2	
B204	BATHROOM	F4	C1	B3	W1, P2	W1, P2	W1, P2	W1, P2	W2 AT TUBS/SHOWERS
B205	BEDROOM	F1	C1	B4	W1, P1	W1, P1	W1, P1	W1, P1	
B205A	CLOSET	F1	C1	B4	W1, P1	W1, P1	W1, P1	W1, P1	
B206	BATHROOM	F4	C1	B3	W1, P2	W1, P2	W1, P2	W1, P2	W2 AT TUBS/SHOWERS
B207B	CLOSET	F1	C1	B4	W1, P1	W1, P1	W1, P1	W1, P1	
B207C	CLOSET	F1	C1	B4	W1, P1	W1, P1	W1, P1	W1, P1	
B205A	CLOSET	F1	C1	B4	W1, P1	W1, P1	W1, P1	W1, P1	
B209	CLOSET	F1	C1	B4	W1, P1	W1, P1	W1, P1	W1, P1	
B209A	CLOSET	F1	C1	B4	W1, P1	W1, P1	W1, P1	W1, P1	
B206	DECK	F5	---	---	---	---	---	---	DEXOTEX FINISH UNDER TILE
C201	LIVING ROOM	F1	C1	B4	W1, P1	W1, P1	W1, P1	W1, P1	
C202	DINING ROOM	F1	C1	B4	W1, P1	W1, P1	W1, P1	W1, P1	
C203	KITCHEN	F2	C1	B3	W1, P2	W1, P2	W1, P2	W1, P2	
C204	CLOSET	F1	C1	B4	W1, P1	W1, P1	W1, P1	W1, P1	
C204A	CLOSET	F1	C1	B4	W1, P1	W1, P1	W1, P1	W1, P1	
C204B	CLOSET	F1	C1	B4	W1, P1	W1, P1	W1, P1	W1, P1	
C204C	BATHROOM	F2	C1	B4	W1, P2	W1, P2	W1, P2	W1, P2	W2 AT TUBS/SHOWERS
C205	BEDROOM	F1	C1	B4	W1, P1	W1, P1	W1, P1	W1, P1	
C206	BEDROOM	F1	C1	B4	W1, P1	W1, P1	W1, P1	W1, P1	
C206A	CLOSET	F1	C1	B4	W1, P1	W1, P1	W1, P1	W1, P1	
C206B	BEDROOM	F1	C1	B4	W1, P1	W1, P1	W1, P1	W1, P1	
C208	CLOSET	F1	C1	B4	W1, P1	W1, P1	W1, P1	W1, P1	
C208A	BATHROOM	F4	C1	B3	W1, P2	W1, P2	W1, P2	W1, P2	W2 AT TUBS/SHOWERS
C208B	CLOSET	F1	C1	B4	W1, P1	W1, P1	W1, P1	W1, P1	
C209	DECK	F5	---	---	---	---	---	---	DEXOTEX FINISH UNDER TILE

FINISH LEGENDS

FLOORS	BASE	WALLS	CEILINGS	PAINT
F1 CARPET	B1 4" MDF BASE	W1 GYPSUM BOARD, SPRAY TEXTURED	C1 GYPSUM BOARD, SPRAY TEXTURED	P1 PAINT FLAT LATEX
F2 SHEET VINYL		W2 PREFABRICATED TUB, SHOWER AND WALL FINIISH		P2 PAINT SEMI GLOSS
F3 CONCRETE SMOOTH FINISH SEALED				
F4	B3 4" RUBBER BASE			
F5 RUBBER TILE BY OWNER	B4 2" WOOD BASE			

GENERAL FINISH NOTES

- PAINT HVAC REGISTERS TO MATCH THE COLOR OF THE WALL ON WHICH THEY OCCUR
- NOT USED
- SQUARE ALL OUTSIDE CORNERS AT WALL, CEILINGS HEADERS, ARCHES SOFFITS, NICHES, DOORS, WINDOWS, ETC.

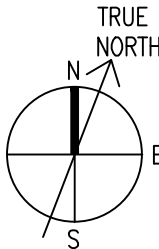

KEYNOTES

GENERAL NOTES

CONTRACTOR SHALL BE RESPONSIBLE FOR VERIFICATION OF DIMENSION AND CLEARANCE REQUIREMENTS OF ALL EQUIPMENT. WHERE DIMENSIONS OR CLEARANCES CAUSE CONFLICT WITH OTHER INFORMATION CONTAINED WITHIN THE CONTRACT DOCUMENTS, CONTRACTOR SHALL VERIFY WITH ARCHITECT PRIOR TO PROCEEDING WITH WORK.

MAXIMUM FLAME SPREAD FOR INTERIOR FINISHES SHALL BE: CLASS X FOR EXIT WAYS; AND CLASS XI FOR ROOMS OR AREAS.

C. DO NOT COVER ANY SPRINKLER PIPING OR HARDWARE DURING CONSTRUCTION UNTIL SUCH PIPING AND HARDWARE HAS BEEN INSPECTED AND APPROVED.

SEE SHEET A9.1 FOR WINDOW AND DOOR SCHEDULES,

ABBREVIATIONS

BASE:  
RBT RUBBER TOPSET 4" HIGH.

ECB EPOXY COATING, COVED.  
RBC RUBBER BASE, COVED.

FLOOR:  
VCT VINYL COMPOSITE TILE.  
LIN LINOLEUM, SHEET.  
TZF TERRAZZO W / INTERGAL BASE.  
ECF EPOXY COATING W / INTERGAL BASE.  
SEC SEALED EXPOSED CONCRETE.

WALLS:  
PT PAINT.

FRP FIBER REINFORCED PANEL.

CEILING:  
PT GYPSUM BOARD PAINT FINISH.  
ACT SUSPEND ACOUSTICAL TILE CEILING.

LEGEND

	LINOLEUM
	EXPOSED CONCRETE
	EPOXY COATING W / INTEGRAL BASE
	VINYL COMPOSITE TILE

REVISIONS	BY
9/26/2011 - PLAN CHECK	G.O.
1/18/2011 - BIDDING	LR


	OAKLEY & OAKLEY ARCHITECTURAL & STRUCTURAL ENGINEERS 1000 CALIFORNIA DRIVE, STE. 615 OAKLAND, CA 94612 510.562.6028 FAX 510.562.6043
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PROJECT TITLE: COMMUNITY CENTER HARBOR PARK APARTMENTS 969 PORTER STREET, VALLEJO, CA 94560 DRAWING TITLE: FINISH SCHEDULE
--

Date:	04/17/2012
Scale:	AS NOTED
Drawn:	STAFF
Checked:	RY
Job No.:	2011-09
Sheet:	A4.11 of 11 Sheets

Hinges  
Full Mortise 4.5x4.5 Standard Weight Brushed Chrome 26D McKinney TA2314  
Door Stops  
Ives 407 1/2 Brushed Chrome  
Flush Bolts  
Concealed


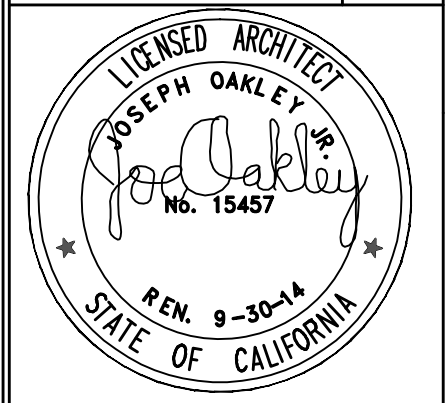
Designation		Door										Frame										Hardware				Weather Stripping		Notes
Door #	Room	Location	Size	Handling	Material	Rating	Glazing	Wall Size	Material	Type	Sillfin	Lockset	Door	Stop	Threshold	Hinges												
1	109	Interior	3'-0" x 6'-1/4"	Right	SC Wood	PG	NR	Full Lite wood frame	7'-1/4"	AL White	Raco	none	AL70P0		Wall		2 Pair		Door is aluminum Raco door with Full Glass Light Clear									
2	111	Interior	3'-0" x 6'-1/4"	Left	SC Wood	PG	NR	Full Lite wood frame	7'-1/4"	AL White	Raco	3'-0" x 0"	AL70P0		Wall		2 Pair		Clear Glazing, Full Door Light, Full Sidelight									
3	107	Interior	3'-0" x 6'-1/4"	Left	SC Wood	PG	NR	Full Lite wood frame	7'-1/4"	AL White	Raco	2'-0" x 0"	AL70P0		Wall		2 Pair		Door is aluminum Raco door with Full Glass Light Clear									
4	110	Interior	3'-0" x 7'-1/4"	Right	SC Wood	PG	NR	Full Lite wood frame	4'-7/8"	AL White	Raco	AL70P0		Wall			1-1/2 Pair		Raco AL Frame									
5	110	Interior	3'-0" x 7'-1/4"	Right	SC Wood	PG	NR	Full Lite wood frame	4'-7/8"	AL White	Raco	AL70P0		Wall			1-1/2 Pair		Raco AL Frame									
6	112	Interior	3'-0" x 6'-1/4"	Right	AL	NR	NR	Full Lite wood frame	7'-1/4"	AL White	Raco	AL70P0		Wall			2 Pair		Clear Glazing, Full Door Light, Full Sidelight									
7	109	Interior	3'-0" x 6'-1/4"	Right	AL	NR	NR	Full Lite wood frame	7'-1/4"	AL White	Raco	AL70P0		Wall			2 Pair		Door is aluminum Raco door with Full Glass Light Clear									
8	105	Interior	3'-0" x 6'-1/4"	Right	AL	NR	NR	Full Lite wood frame	7'-1/4"	AL White	Raco	2'-0" x 0"	AL70P0		Wall		2 Pair		Door is aluminum Raco door with Full Glass Light Clear									
9	Phy Area	Interior	3'-0" x 6'-1/4"	Left	SC Wood	PG	NR	Full Lite wood frame	4'-7/8"	AL White	Raco	AL70P0		Wall			1-1/2 Pair		Raco AL Frame									
10	104	Interior	3'-0" x 7'-1/4"	Left	SC Wood	PG	NR	Full Lite wood frame	4'-7/8"	AL White	Raco	AL45	x	Wall			1-1/2 Pair		Raco AL Frame									
11	103	Interior	3'-0" x 7'-1/4"	Left	SC Wood	PG	NR	Full Lite wood frame	4'-7/8"	AL White	Raco	AL70P0	x	Wall			1-1/2 Pair		Raco AL Frame									
12	100	Exterior	3'-0" x 7'-1/4"	Left	HM	20 min		7'-1/4"	HM	Welded	ALBOPD						1-1/2 Pair											
13	102	Exterior	3'-0" x 7'-1/4"	Left	HM	20 min		7'-1/4"	HM	Welded	ALBOPD						1-1/2 Pair											
14	UH2	Exterior	Ph 2'-6 1/2" x 3'-1/4"		HM	20 min					ALBOPD						1-1/2 Pair											
15	112	Exterior	Ph 3'-0" x 6'-1/4"		Al Store Front White	NR		3'-0" x 0"	AL White	Store Front System	See Window Sch.	Exterior Full Interior Panel		Surface mount ADA	2 ea Ives FS444	By Glazing Contractor	By Glazing Contractor		3 point lock with Schlage 5 pin Rim Cylinder, Keying and Rekey YED									
16	112	Exterior	Ph 3'-0" x 6'-1/4"		Al Store Front White	NR		4'-3/4"	AL White	Store Front System	See Window Sch.	Exterior Full Interior Panel		Surface mount ADA	2 ea Ives FS444	By Glazing Contractor	By Glazing Contractor		3 point lock with Schlage 5 pin Rim Cylinder, Keying and Rekey YED									
17	111	Exterior	3'-0" x 6'-1/4"	Right	Al Store Front White	NR		4'-3/4"	AL White	Store Front System		Lever Exterior Lever Interior		Lever Exterior Lever Interior	Ives FS444	By Glazing Contractor	By Glazing Contractor		Lock store room function									
18	106	Exterior	3'-0" x 6'-1/4"	Left	Al Store Front White	NR		4'-3/4"	AL White	Store Front System		Lever Exterior Lever Interior		Lever Exterior Lever Interior	Ives FS444	By Glazing Contractor	By Glazing Contractor		Lock store room function									
19	106	Exterior	3'-0" x 6'-1/4"	Right	Al Store Front White	NR		4'-3/4"	AL White	Store Front System		Lever Exterior Lever Interior		Lever Exterior Lever Interior	Ives FS444	By Glazing Contractor	By Glazing Contractor		Lock store room function									

Part A			Designation		Door			Frame					Hardware					Weather Stripping		Notes
Door #	Item	Location	Size	Handing	Type (6 panel)	Finish	Material	Jamb	Material	Trim ext	Casing	Lockset	Door Stop	Baseboard	Threshold	Hinges	Brushed Chrome	Ingrain to Door Frame		
A1	A201	ENTRY	3'-0 1/8"-8'-3 1/4"	RH	6 Panel	NC	N/A	Fiberglass	6-6/16	Wood	Stucco Mold	2-1/4"	2-1/4"	N/A	Door Board Spring	Ingrain to Frame AL	Brushed Chrome	Ingrain to Door Frame		
A2	A206	Deck	6'-0 1/8"-8'-3 1/4"	RH	3 Full Lite with 3-0 Full Side Lite	N/A	Fiberglass	6-6/16	Wood	Stucco Mold	2-1/4"	2-1/4"	Schlage S500 NEP 626	N/A	Base board Spring	Ingrain to Frame AL	Brushed Chrome	Ingrain to Door Frame	Glazing Every Star Low E Clear Glass No Grids. Fixed Lite on Left From Exterior	
A3	A308	Bath	2'-10 1/8"-3'-8"	RH	6 Panel HC	NA	Composite	4-6/16	Wood	2-1/4"	2-1/4"	Schlage S450 NEP 626	N/A	Base board Spring	N/A	Brushed Chrome	N/A			
A4	A304-A	Closet	2'-10 1/8"-3'-8"	RH	6 Panel HC	NA	Composite	4-6/16	Wood	2-1/4"	2-1/4"	Schlage S450 NEP 626	N/A	Base board Spring	N/A	Brushed Chrome	N/A			
A5	A305	Bedroom	2'-10 1/8"-3'-8"	RH	6 Panel HC	NA	Composite	7-1/16	Wood	2-1/4"	2-1/4"	Schlage S450 NEP 626	N/A	Base board Spring	N/A	Brushed Chrome	N/A			
A6	A205	Bedroom	2'-10 1/8"-3'-8"	RH	6 Panel HC	NA	Composite	4-6/16	Wood	2-1/4"	2-1/4"	Schlage S450 NEP 626	N/A	Base board Spring	N/A	Brushed Chrome	N/A			
A-7	A205B	Closet	2'-10 1/8"-3'-8"	RH	6 Panel HC	NA	Composite	4-6/16	Wood	2-1/4"	2-1/4"	Schlage S500 NEP 626	N/A	Base board Spring	N/A	Brushed Chrome	N/A			
A-8	A205A	Bath	2'-10 1/8"-3'-8"	RH	6 Panel HC	NA	Composite	4-6/16	Wood	2-1/4"	2-1/4"	Privacy Pocket Door Litch S50 Schage S500	N/A	N/A	N/A	N/A	N/A			
A-9	A206A	Deck	3'-10 1/8"-3'-8"	LH	6 Panel HC	NA	Composite	7-1/8	Wood	2-1/4"	2-1/4"	Schlage S500 NEP 626	N/A	Base board Spring	N/A	Brushed Chrome	N/A			
A-10	A207	Bedroom	2'-10 1/8"-3'-8"	LH	6 Panel HC	NA	Composite	4-6/16	Wood	2-1/4"	2-1/4"	Schlage S450 NEP 626	N/A	Base board Spring	N/A	Brushed Chrome	N/A			
A-11	A207A	Closet	2'-6 1/8"-3'-8"	RH	6 Panel HC	NA	Composite	4-6/16	Wood	2-1/4"	2-1/4"	Schlage S500 NEP 626	N/A	Base board Spring	N/A	Brushed Chrome	N/A			
A-12	A207B	Closet	2'-6 1/8"-3'-8"	RH	6 Panel HC	NA	Composite	4-6/16	Wood	2-1/4"	2-1/4"	Schlage S500 NEP 626	N/A	Base board Spring	N/A	Brushed Chrome	N/A			
A-13	A207A-A	Bath	2'-6 1/8"-3'-8"	RH	6 Panel HC	NA	Composite	4-6/16	Wood	2-1/4"	2-1/4"	Schlage S450 NEP 626	N/A	Base board Spring	N/A	Brushed Chrome	N/A			
A14	A208	Deck	2'-8 1/8"-3'-4"	LH	Full Lite	N/A	Fiberglass	6-6/16	Wood	Stucco Mold	2-1/4"	2-1/4"	Schlage S500 NEP 626	N/A	Base board Spring	Ingrain to Frame AL	Brushed Chrome	Ingrain to Door Frame	Glazing Every Star Low E Clear Glass No Grids	

Door #	Rm	Location	Size	Handing	Type	Rating	Material	Jamb	Material	Trim ext	Casing	Lockset	Closer	Door Stop	Threshold	Hinges	Weather Stripping	Notes
B1	B202	ENTRY	3'-0x6'-8x1-3/4	LH	6 Panel Smooth Panel Grade	N/A	Fiberglass	6-6/16	Wood	Stucco Mold	2-1/4"	Lockset 5-200 NFP 625 Interlocked	N/A	Base Board Spring	Integral to Frame	Brushed Chrome	Integral to Door Frame	
B2	B206	Deck	6'-0x8'-0 x1-3/4	LH	3-0 Full Side with 3-0 Full Side Lite	N/A	Fiberglass	6-5/16	Wood	Stucco Mold	2-1/4"	Lockset 5-200 NFP 625 Interlocked	N/A	Base Board Spring	Integral to Frame	Brushed Chrome	Integral to Door Frame	Blazing Entry Star Low E Clear Glass No Grids On Right From Exterior
B3	B206	Bedroom	2'-6x8'-0x1-3/8	RH	6 Panel HC	N/A	Composite	7-1/8	Wood	2-1/4"	2-1/4"	Lockset 5-200 NFP 626	N/A	Base Board Spring	N/A	N/A	N/A	
B4	B204	Bath	2'-6x8'-0x1-3/8	Pocket	6 Panel HC	N/A	Composite	6-5/16	Wood	2-1/4"	2-1/4"	Lockset 5-200 NFP 626	N/A	Base Board Spring	N/A	N/A	N/A	
B5	B205A	Closet	Plat 4'-6x8'-0x1-3/8	BI Pass	6 Panel HC	N/A	Composite	6-5/16	Wood	2-1/4"	2-1/4"	Cup Pulls Lockset 5-400 NFP 628	N/A	N/A	N/A	N/A	N/A	Provides BI Pass Hardware
B6	B207	Bedroom	2'-6x8'-0x1-3/8	RH	6 Panel HC	N/A	Composite	6-5/16	Wood	2-1/4"	2-1/4"	Lockset 5-200 NFP 628	N/A	Base Board Spring	N/A	N/A	N/A	
B7	B209	Bath	2'-6x8'-0x1-3/8	RH	6 Panel HC	N/A	Composite	6-5/16	Wood	2-1/4"	2-1/4"	Lockset 5-400 NFP 628	N/A	Base Board Spring	N/A	N/A	N/A	
B8	B209A	Closet	Plat 4'-6x8'-0x1-3/8	LH	6 Panel HC	N/A	Composite	6-5/16	Wood	2-1/4"	2-1/4"	Lockset 5-200 NFP 626	N/A	Base Board Spring	N/A	N/A	N/A	
B9	B207C	Closet	Plat 4'-6x8'-0x1-3/8	BI Pass	6 Panel HC	N/A	Composite	6-5/16	Wood	2-1/4"	2-1/4"	Cup Pulls Lockset 5-200 NFP 625	N/A	N/A	N/A	N/A	N/A	Provides BI Pass Hardware
B10	A208	Deck	2'-8x6'-8x1-3/4	RH Reverse	Full Lite	N/A	Fiberglass	6-6/16	Wood	Stucco Mold	2-1/4"	Lockset 5-200 NFP 625	N/A	Base Board Spring	Integral to Frame	Brushed Chrome	Integral to Door Frame	Blazing Entry Star Low E Clear Glass No Grids

Door #	Room	Location	Size	Handing	Type (Panel, Smokey Paint, Grade)	Rating	Material	Jamb	Material	Trim ext	Casing	Lockset (Privacy 5-200, NEF 626, Schlage 5400, NEF 626)	Closer	Door Stop	Threshold	Hinges	Weather Stripping	Notes	
C1	C201	ENTRY	3'-0 1/8 x 8'-1 3/4	LH	6 Panel N/A	NA	Fiberglass	6-6/16	Wood	Shoco Mold	2'-1/4"	2'-1/4"	N/A	Base board Spring	Integral to Frame AL	Brushed Chrome	Integral to door Frame		
C2	C202	Bedroom	2'-6 1/8 x 7'-3/8	RH	6 Panel HC	NA	Composite	7-9/16	Wood	2'-1/4"	2'-1/4"	N/A	N/A	Base board Spring	N/A	Brushed Chrome	N/A		
C3	C206A	Bath	2'-6 1/8 x 7'-3/8	Pocket	6 Panel HC	NA	Composite	6-6/16	Wood	2'-1/4"	2'-1/4"	Privacy Pocket Door Latch 626	N/A	N/A	N/A	N/A	N/A		
C4	C206B	Closet	Pair 2'-6 1/8 x 7'-3/8	BI Pass	6 Panel HC	NA	Composite		Wood	Cop Pulls	N/A	N/A	N/A	N/A	N/A	Brushed Chrome	Provide BI Pass Hardware		
C5	C207 under Entry	Closet	2'-6 1/8 x 7'-3/8	RH	6 Panel HC	NA	Composite	6-6/16	Wood	2'-1/4"	2'-1/4"	Schlage 5400 NEF 626	N/A	Base board Spring	N/A	Brushed Chrome			
C6	C208B	Closet	Pair 2'-6 1/8 x 7'-3/8	BI Pass	6 Panel HC	NA	Composite		Wood	Cop Pulls	N/A	N/A	N/A	N/A	N/A	Chrome	Provide BI Pass Hardware		
C7	C204C	Bedroom	2'-6 1/8 x 7'-3/8	RH	6 Panel HC	NA	Composite	6-6/16	Wood	2'-1/4"	2'-1/4"	Schlage 5400 NEF 626	N/A	Base board Spring	N/A	Brushed Chrome	N/A		
C8	C204C	Bath	2'-6 1/8 x 7'-3/8	LH	6 Panel HC	NA	Composite	6-6/16	Wood	2'-1/4"	2'-1/4"	Privacy Pocket Door Latch 626	N/A	N/A	N/A	Brushed Chrome			
C9	C204B	Closet	2'-6 1/8 x 7'-3/8	LH	6 Panel HC	NA	Composite	6-6/16	Wood	2'-1/4"	2'-1/4"	Schlage 5400 NEF 626	N/A	Base board Spring	N/A	Chrome			
C10	C208	Bedroom	2'-6 1/8 x 7'-3/8	LH	6 Panel HC	NA	Composite	6-6/16	Wood	2'-1/4"	2'-1/4"	Schlage 5400 NEF 626	N/A	Base board Spring	N/A	Brushed Chrome			
C11	C208A	Bath	2'-6 1/8 x 7'-3/8	RH	6 Panel HC	NA	Composite	6-6/16	Wood	2'-1/4"	2'-1/4"	Privacy Pocket Door Latch 626	N/A	N/A	N/A	N/A	N/A		
C12	C208B	Closet	Pair 4'-6 1/8 x 7'-3/8	BI Pass	6 Panel HC	NA	Composite		Wood	Cop Pulls	N/A	N/A	N/A	N/A	N/A	Brushed Chrome	Provide BI Pass Hardware		
C13	A306	Deck	6'-0 1/8 x 8'-1 3/4	LH	3-0 Full with 3-0 full size top	N/A	Fiberglass	6-6/16	Wood	Shoco Mold	2'-1/4"	2'-1/4"	Privacy 5-200 NEF 626	N/A	Base board Spring	Integral to Frame AL	Brushed Chrome	Integral to door Frame	(Clayco Energy Star Low E Clear Glass No Grids, Faxed Light

9/26/2011 - PLAN CHECK	G.O.
01/20/2014- BIDDING	LR
01/27/2014- BIDDING	JU



**OAKLEY & OAKLEY**  
 ENGINEERS  
 7700 EDGEWATER DRIVE, STE. 615  
 OAKLAND, CA 94621  
 P.F.A. 510.556.6043

PROJECT TITLE: COMMUNITY CENTER HARBOR PARK APARTMENTS 869 PORTER STREET, VALLEJO, CA 94560	DRAWING TITLE: DOOR, WINDOW & FINISH SCHEDULE
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Date:	08/30/2011
Scale:	AS NOTED
Drawn:	STAFF
Checked:	RY
Job No.:	2011-09

Sheet:

**A4.10**

## WINDOW SCHEDULE

WINDOW MARK	WINDOW TYPE	SIZE		FRAME TYPE	MATERIAL	GLAZING			DETAILS				RATING	REMARKS
		WIDTH	HEIGHT			SINGLE	DOUBLE	TEMP	LOW E	HEAD	JAMB	SILL	MULL	
A	1	18'-0"	18'-6"		ALUM	X	X	X	17/CD1	17/CD1	21,23/CD1			
B	2	+/-5'-0	+/-5'-0		WOOD	X			7/CD1	7/CD1	2/CD1	1/CD1		
C	3	12'-0"	8'-0"		ALUM	X	X	X	17/CD1	17/CD1	21,23/CD1			
D	4	8'-3"	8'-0"		ALUM	X	X	X	17/CD1	17/CD1	21,23/CD1			
E	5	6'-6"	8'-0"		ALUM	X	X	X	17/CD1	17/CD1	21,23/CD1			
F	6	9'-3"	8'-0"		ALUM	X	X	X	17/CD1	17/CD1	21,23/CD1			
G	7	6'-0"	5'-0"		VINYL	X		X	10/CD1	10/CD1	22/CD1			
H	14	2'-0"	2'-0"		VINYL	X		X	10/CD1	10/CD1	3/CD1			
I	8	2'-0"	2'-0"		VINYL	X		X	10/CD1	10/CD1	22/CD1			
J	9	2'-0"	8'-0"		WOOD	X		X	18/CD1	18/CD1	24/CD1	12/CD1		
K	9	3'-0"	8'-0"		WOOD	X		X	18/CD1	18/CD1	24/CD1	12/CD1		
L	10	3'-0"	4'-6"		VINYL	X	X	X	10/CD1	10/CD1	22/CD1			
M	11	9'-0"	5'-0"		VINYL	X	X	X	10/CD1	10/CD1	22/CD1			
N	12	3'-0"	5'-0"		VINYL	X	X	X	10/CD1	10/CD1	22/CD1			
O	7	6'-0"	5'-0"		VINYL	X	X	X	10/CD1	10/CD1	16/CD1			
P	7	3'-0"	8'-0"		ALUM	X		X	10/CD1	10/CD1	16/CD1			

### WINDOW NOTES:

INSTALL DEVICES WHICH ALLOW WINDOWSTO BE LOCKED FROM THE INTERIOR  
ALL WINDOWS SHALL BE DUAL GLAZED WITH WEATHER-STRIPPED OR LOW INFILTRATION FRAMES MEETING ANSI AIR INFILTRATION STANDARDS.

SAFETY GLAZING SHALL BE INSTALLED IN THE FOLLOWING LOCATIONS: PER (2010)CBC 2406.3)









- GLAZING IN SWINGING DOORS EXCEPT JALOUSIES
- GLAZING IN FIXED AND SLIDING PANELS OF SLIDING DOOR ASSEMBLIES AND PANELS IN SLIDING AND BI-FOLD CLOSET DOOR ASSEMBLIES
- GLAZING IN STORM DOORS
- GLAZING IN UNFRAMED SWINGING DOORS
- GLAZING IN DOORS AND ENCLOSURES FOR HOT TUBS, WHIRLPOOLS, SAUNAS, STEAM ROOMS, BATHTUBS AND SHOWERS. GLAZING IN ANY PORTION OF A BUILDING WALL ENCLONGING THESE COMPARTMENTS WHERE THE BOTTOM EXPOSED EDGE OF GLAZING IS LESS THAN 60" ABOVE A STANDING SURFACE.
- GLAZING IN INDIVIDUAL FIXED OR OPERABLE PANEL ADJACENT TO A DOOR WHERE THE NEAREST EXPOSED EDGE OF THE GLAZING IS WITHIN A 24" ARC OF EITHER VERTICAL EDGE OF THE DOOR IN A CLOSED POSITION AND WHERE THE BOTTOM EXPOSED EDGE OF GLAZING IS LESS THAN 60" ABOVE THE WALKING SURFACE.

EXCEPTION:

AN INTERVENING WALL BETWEEN DOOR & GLAZING

WINDOW / ENERGY INFORMATION:  
(SEE T-24 FOR INFORMATION)  
GLAZING U-FACTOR = 0.29  
SOLAR HEAT GAIN COEFFICIENT = 0.26

## WINDOW TYPES

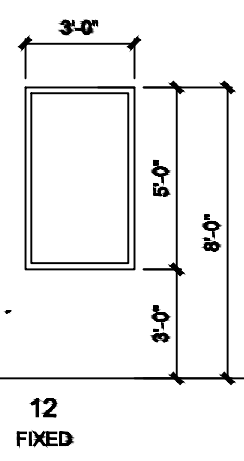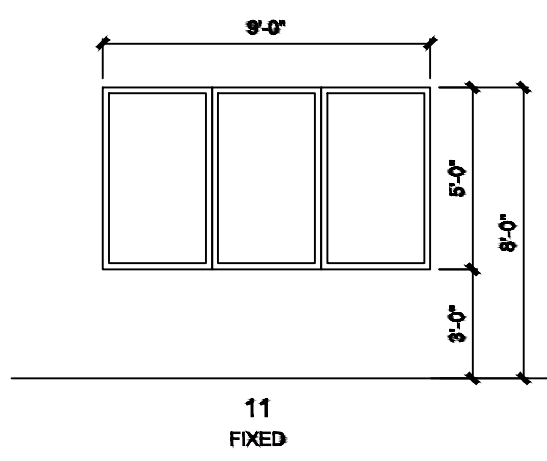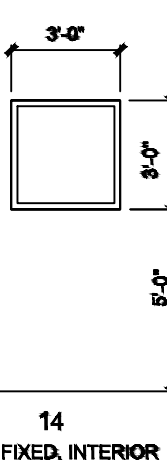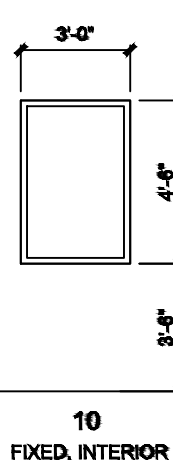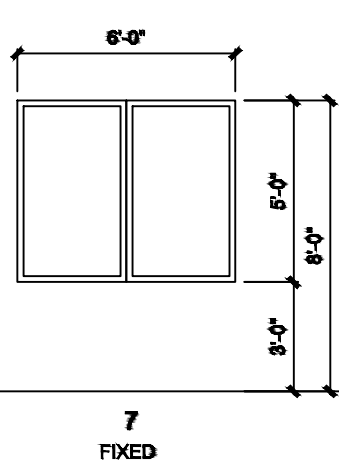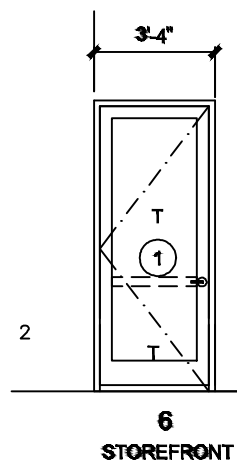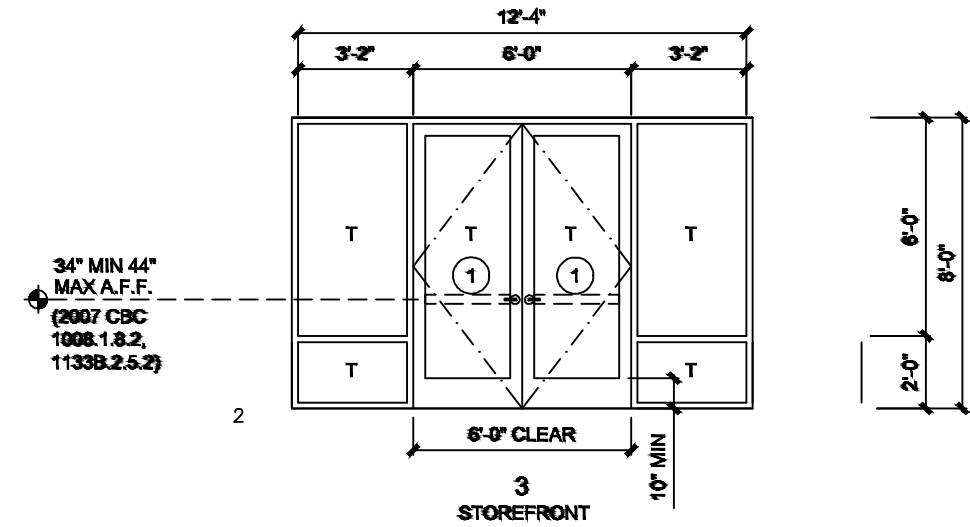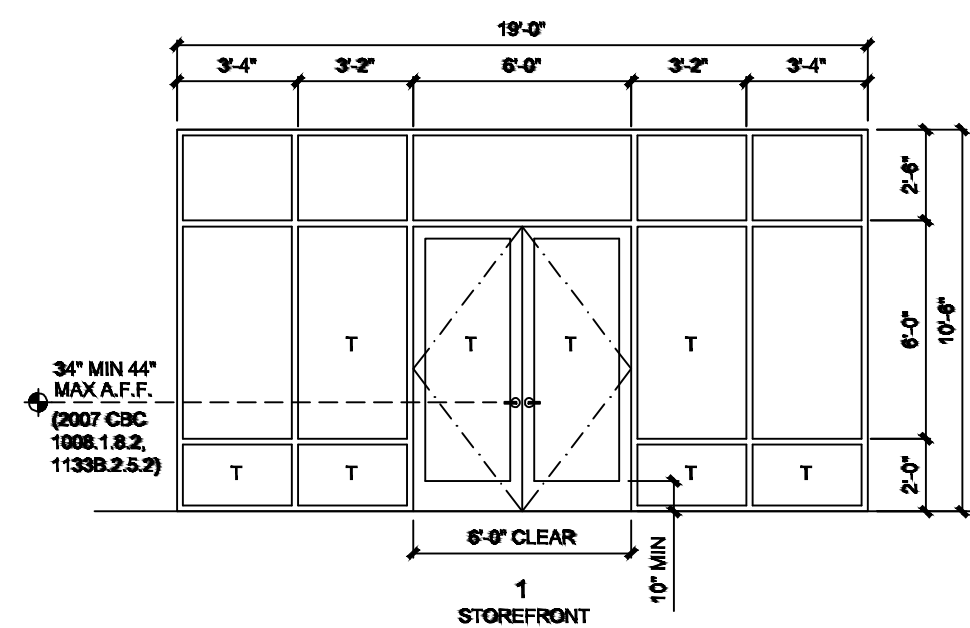

"T" INDICATES TEMPERED GLASS

SEE WINDOW SCHEDULE FOR ACTUAL SIZE. VERIFY ROUGH OPENING WITH WINDOW MANUFACTURER

- PROVIDE PANIC HARDWARE ON INTERIOR SIDE OF DOOR, SHOWN DASHED LINES. PANIC HARDWARE TO BE CONCEALED IN DOOR FRAMES

## FINISH SCHEDULE

ROOM NUMBER		FLOOR	BASE	WALLS				WALL NO.		CEILING		CEILING HEIGHT	REMARKS
				1	2	3	4						
	ENTRY VESTIBULE	F4	B1	W1	W1	W1	W1			C1	P1	11'-0"	SHAW GROUP VIVID BLOOM 56041/04701
	OFFICE 1	F1	B1	W1	W1	W1	W1			C2		9'-0"	
	OFFICE 2	F1	B1	W1	W1	W1	W1			C2		9'-0"	
	COPY / STORAGE	F1	B1	W1	W1	W1	W1			C2		9'-0"	
	BUSINESS CENTER	F1	B1	W1	W1	W1	W1			C2		9'-0"	
	GREAT ROOM	F4	B1	W1	W1	W1	W1			C1	P1	11'-0"	SHAW GROUP VIVID BLOOM 56041/04701
	UTILITY ROOM 1	F3	B3	W3	W3	W3	W3			C3		9'-0"	
	UTILITY ROOM 2	F3	B3	W3	W3	W3	W3			C3		9'-0"	
	STORAGE	F2	B3	W1	W1	W1	W1			C2		9'-0"	
	MEN	F2	B3	W2	W2	W2	W2			C2		9'-0"	
	WOMEN	F2	B3	W2	W2	W2	W2			C2		9'-0"	
	KITCHEN	F2	B1	W1	W1	W1	W1			C2		9'-0"	
	HALL	F2	B1	W1	W1	W1	W1			C2		9'-0"	
	FITNESS	F4	B1	W1	W1	W1	W1			C1	P2	11'-0"	SHAW GROUP VIVID BLOOM 56041/04701

### FINISH LEGENDS

FLOORS  
F1 CARPET  
F2 SHEET VINYL  
F3 CONCRETE SMOOTH FINISH SEALED  
F4 CARPET TILE

BASE  
B1 4" MDF BASE  
B2 NOT USED  
B3 6" RUBBER BASE

WALLS  
W1 GYPSUM BOARD, LEVEL, S SMOOTH FINISH  
W2 COLORED FRP PANELS TO 4' ABOVE F.F.  
W3 GYPSUM BOARD TAPED & TOPPED JOINTS

CEILING  
C1 GYPSUM BOARD SPRAYED ON FINISH  
C2 SUSPENDED TILE CEILING  
C3 GYPSUM BOARD TAPED & TOPPED JOINTS

PAINT  
P1 PAINT FLAT LATEX  
P2 PAINT SEMI GLOSS


### GENERAL FINISH NOTES

- PAINT HVAC REGISTERS TO MATCH THE COLOR OF THE WALL ON WHICH THEY OCCUR
- PAINT SECURITY CAMERA HOUSING TO MATCH COLOR OF SURFACE ON WHICH CAMERA OCCURS
- SQUARE ALL OUTSIDE CORNERS AT WALL, CEILING HEADERS, ARCHES SOFFITS, NICHES, DOORS, WINDOWS, ETC.


## DOOR SCHEDULE

DOOR MARK	DOOR TYPE	SIZE		FRAME TYPE	MATERIAL	GLAZING			DETAILS		HDWR	REMARKS
		WIDTH	HEIGHT			SINGLE	DOUBLE	TEMPERED	LOW E	HEAD	JAMB	
1	1	3'-0"	8'-0"	1 3/4"	WD	X	X	X	8/CD1	8/CD1		
2	1	3'-0"	8'-0"	1 3/4"	WD	X	X	X	8/CD1	8/CD1		
3	3	3'-0"	8'-0"	1 3/4"	WD	X	X	X	4/CD1	4/CD1		
4	3	3'-0"	8'-0"	1 3/4"	WD	X	X	X	8/CD1	11/CD1	21/CD1	
5	1	3'-0"	8'-0"	1 3/4"	WD	X	X	X	8/CD1	8/CD1		
6	1	3'-0"	8'-0"	1 3/4"	METAL	X	X	X	8/CD1	11/CD1	21/CD1	
7	1	3'-0"	8'-0"	1 3/4"	WD	X	X	X	8/CD1	8/CD1		
8	1	3'-0"	8'-0"	1 3/4"	WD	X	X	X	8/CD1	8/CD1		
9	1	3'-0"	8'-0"	1 3/4"	WD	X	X	X	8/CD1	8/CD1		
10	4	3'-0"	8'-0"	1 3/4"	WD	X	X	X	8/CD1	8/CD1		
11	4	3'-0"	8'-0"	1 3/4"	WD	X	X	X	8/CD1	8/CD1		
12	2	3'-0"	8'-0"	1 3/4"	WD	X	X	X	8/CD1	8/CD1		
13	5	3'-0"	8'-0"	1 3/4"	METAL	X	X	X	8/CD1	11/CD1	21/CD1	

## DOOR TYPES

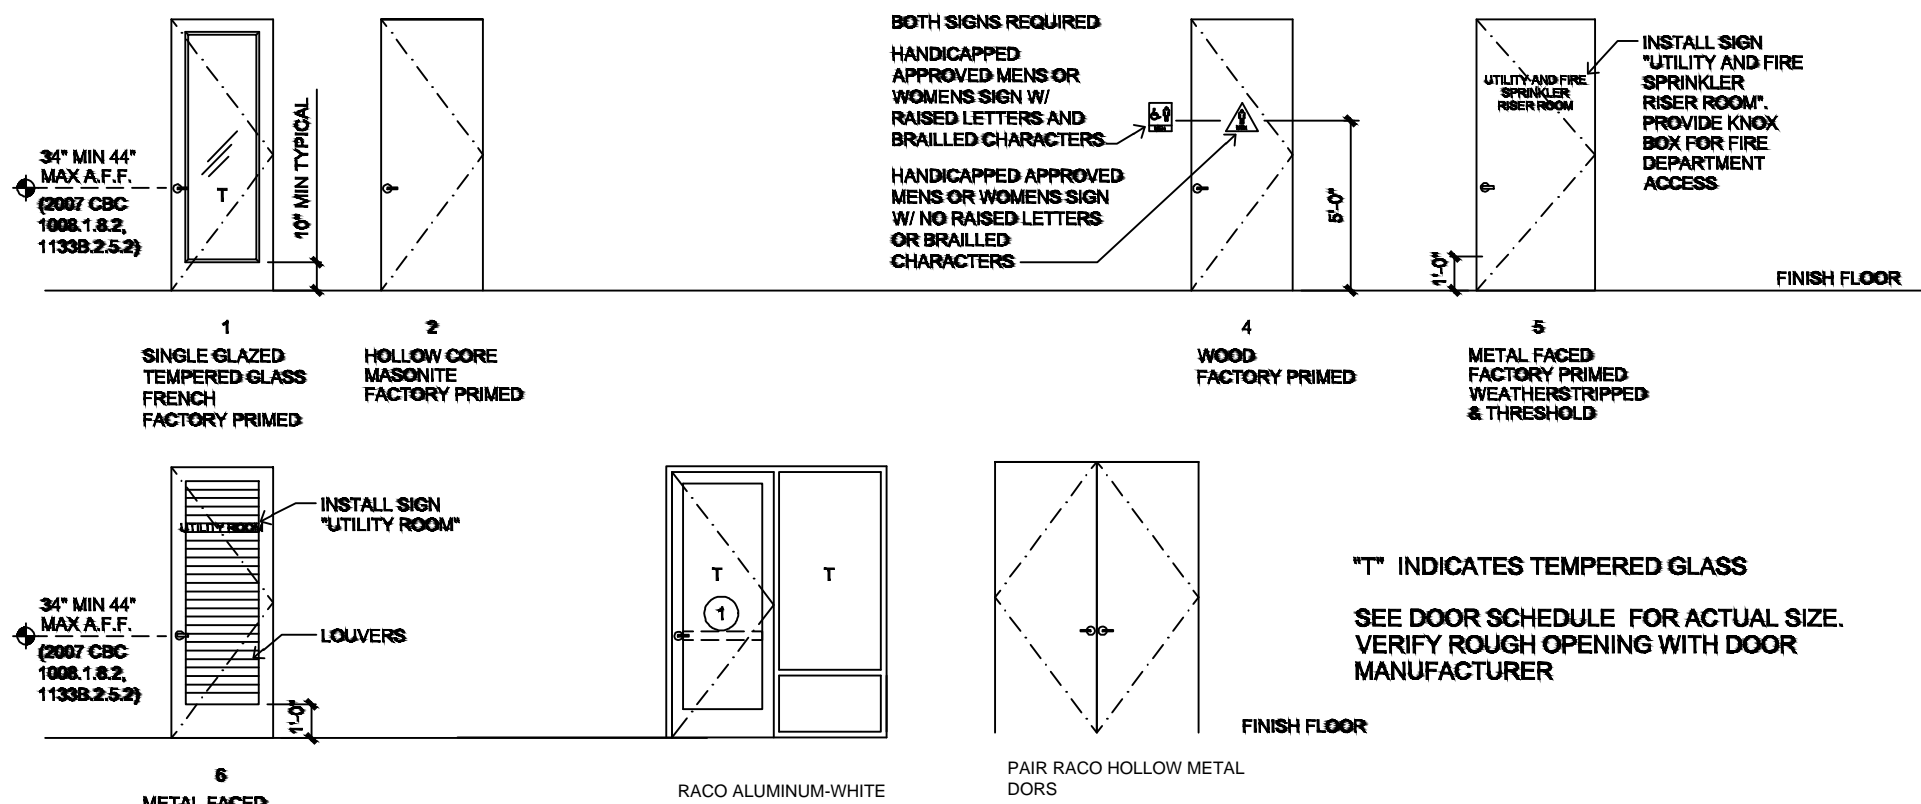

Jan 27, 2014 - 6:48pm \\SERVER\Server Drive D\Year 2011 Jobs\2011-093 - Community Bldg\REVISED DRAWINGS FOR NEGOTIATED CONTRACT WITH WE LYDINS\ARCHITECT\UA71 - Bldg Section.dwg

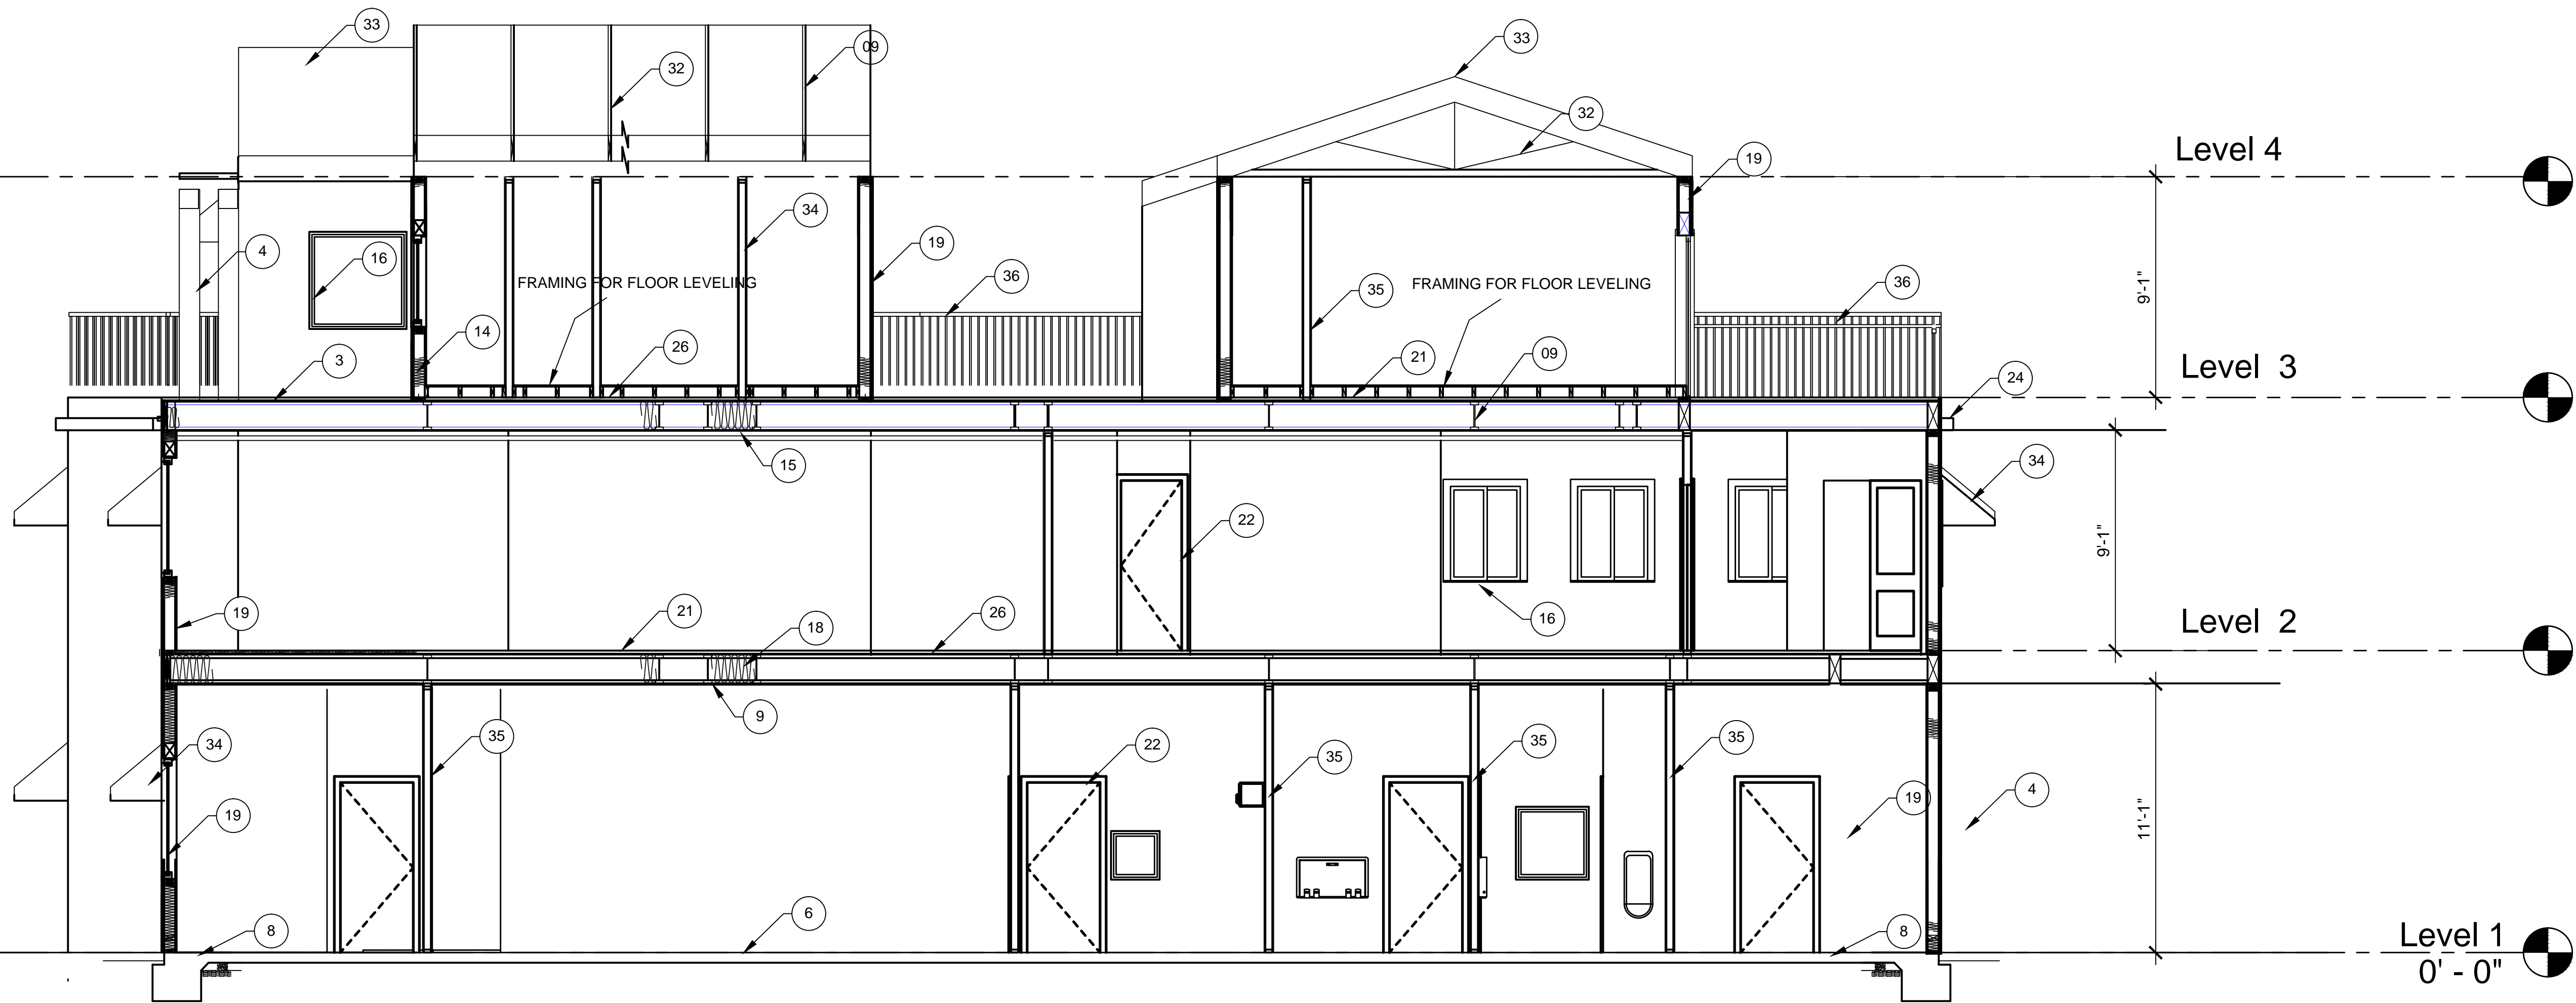

## GENERAL NOTES



- A. ALL DIMENSIONS ARE TO FACE OF STUD OR CENTERLINE OF PARTITION WALL, INTERIOR COLUMN/ WINDOW/ DOOR UNLESS OTHERWISE NOTED.
- B. DETAILS ARE KEYED AND NOTED "TYPICAL" ONLY ONCE ON THE PLANS WHEN THEY FIRST OCCUR, AND ARE REPRESENTATIVE OF SIMILAR CONDITIONS THROUGHOUT, UNLESS OTHERWISE NOTED.

## KEYNOTES

- 01 CEMENT PLASTER 0/2 LAYERS GRADE D BLDG. PAPER/O 1/2" PLYWD.
- 2 ALUMINUM STOREFRONT SYSTEM. SEE DET. SHEET A8.1
- 3 BUILT UP ROOFING
- 4 WD. TRELLIS.
- 5 ROOF CRICKET.
- 6 CONCRETE SLAB-ON-GRADE. SSD
- 7 STEEL BEAM. SSD
- 8 CONCRETE FOOTING. SSD
- 9 T.J.I. JOISTS @ 16 & 24" O.C. MAX. SSD.
- 10 5/8 THK. PLYWOOD SHEATHING. SSD.
- 11 ALUMINUM WINDOW SYSTEM.
- 12 5/8" THK. PLYWD. SHEATHING.
- 13 WD. HEADER. SEE STRUCTURAL DWGS.

## LEGEND

REVISIONS	BY
9/26/2011 - PLAN CHECK	G.O.

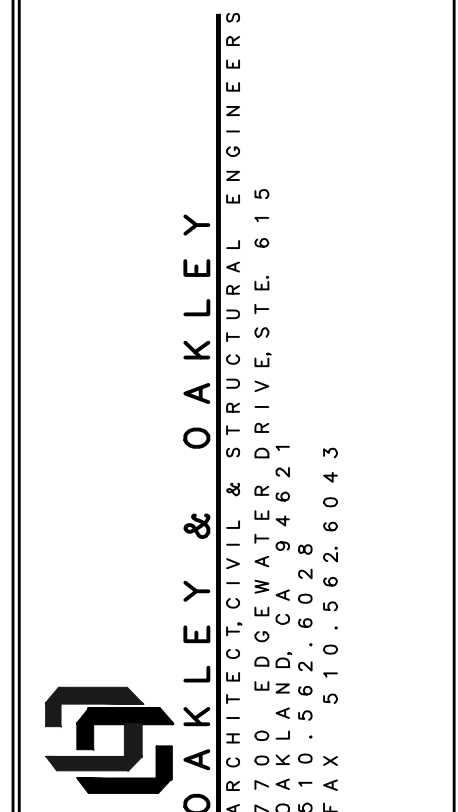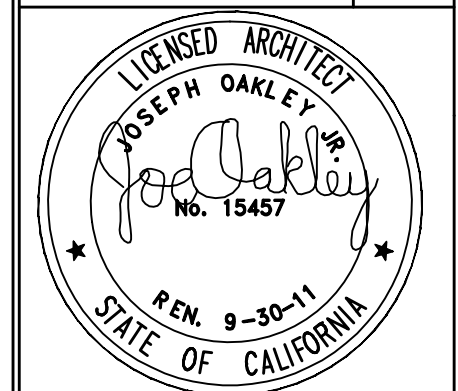

PROJECT TITLE:  
**COMMUNITY CENTER**  
HARBOR PARK APARTMENTS  
969 PORTER STREET, VALLEJO, CA 94560

DRAWING TITLE:  
**BUILDING SECTIONS**

Date:	04/17/2012
Scale:	AS NOTED
Drawn:	STAFF
Checked:	RY
Job No.:	2011-09
Sheet:	<b>A7.1</b>
Of	Sheets

Jun 27, 2014 - 6:51pm \\SERVER\Server Drive D\Year 2011 Jobs\2011-09-3 - Community Bldg\REVISED DRAWINGS FOR NEGOTIATED CONTRACT WITH VE LYONS\ARCHITECTUA72 - Bldg Section.dwg

2

REVISIONS		BY
9/26/2011 - PLAN CHECK	G.O.	
01/18/2014 - BIDDING	LR.	
<div><div><div><div><div><span></span></div><div>JOSEPH OAKLEY</div></div><div><div><span></span></div><div>No. 15457</div></div></div><div><div>STATE OF CALIFORNIA</div><div>EXPI. 9-30-11</div></div></div></div>		

<div><div><div>JO</div><div>OAKLEY &amp; OAKLEY</div></div><div>ARCHITECTS &amp; STRUCTURAL ENGINEERS 1000 CALIFORNIA STREET, SUITE 615 OAKLAND, CA 94612 P.O. BOX 94621 P.A.Y. 510.592.6043</div></div>	
--	--

PROJECT TITLE: <b>COMMUNITY CENTER</b> HARBOR PARK APARTMENTS 969 PORTER STREET, VALLEJO, CA 94560	DRAWING TITLE: <b>BUILDING SECTION</b>
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Date:	04/17/2012
Scale:	AS NOTED
Drawn:	STAFF
Checked:	RY
Job No.:	2011-09
Sheet:	<b>A7.2</b>
Of	Sheets



**01 BUILDING SECTION**  
SCALE: 1/4" = 1'-0"

## GENERAL NOTES


- A. ALL DIMENSIONS ARE TO FACE OF STUD OR CENTERLINE OF PARTITION WALL, INTERIOR COLUMN/ WINDOW/ DOOR UNLESS OTHERWISE NOTED.
- B. DETAILS ARE KEYED AND NOTED "TYPICAL" ONLY ONCE ON THE PLANS WHEN THEY FIRST OCCUR, AND ARE REPRESENTATIVE OF SIMILAR CONDITIONS THROUGHOUT, UNLESS OTHERWISE NOTED.

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- 6 CONCRETE SLAB-ON-GRADE. SSD
- 7 STEEL BEAM. SSD
- 8 CONCRETE FOOTING, SSD
- 9 T.J.I. JOISTS @ 16 & 24" O.C. MAX. SSD.
- 10 3/4 THK. PLYWOOD SHEATING. SSD.
- 11 ALUMINUM WINDOW SYSTEM.
- 12 3/4" THK. PLYWD. SHEATING.
- 13 WD. HEADER. SEE STRUCTURAL DWGS.
- 14 STEEL COLUMN. SSD.
- 15 5/8" THK. TYPE " X" GYPSUM BD.
- 16 VINYL WINDOW.
- 17 5/8" THK. GYPSUM BD.
- 18 ROOF INSULATION PER TITLE 24
- 19 2X6 WD. STUD FRAMING. SSD.
- 20 BATT INSULATION PER TITLE 24
- 21 FINISH FLOOR. SEE FINISH SCHEDULE A4.1
- 22 WOOD DOOR. SEE SHEET A9.1
- 23 ROOF DRAIN AND OVERFLOW.
- 24 EPS TRIM.
- 25 2" ALUMINUM REVEAL.
- 26 1-1/2" GYP.CRETE. SEE STRUCTURAL DWGS.
- 27 PLASTER WEEP SCREED.

- 28 WD. BEAM. SEE SSD
- 29 MTL. GA. DOWNSPOUT
- 30 SHEET METAL CAP FLASHING /O TPO ROOFING O/ 1 LAYER OF BITUTHENE
- 31 SLOPE ROOF DRAIN 1/2"=1'-0"
- 32 PREFABRICATED ROOF TRUSSES @ 24" O.C.
- 33 ASPHLT SHINGLES OVER 5/8" PLYWOOD (32/16) OVER 15 LB. FELT.
- 34 WINDOW AWNINGS
- 35 2X4 WOOD STUDS WITH 5/8" TYPE X GYP. BD. EACH SIDE.
- 36 METAL RAILING
- 37 FLOOR FURRING FOR ROOF SLOPE AND FLOOR LEVELING
- 38 RIPPED 2X @ 16" O.C.
- 39 2X4 SLEEPERS @ 24" O.C.
- 40 5/8" PLYWOOD WITH 10D @ 6" O.C. AT PANEL EDGES
- 41 3-10D TOES @ EACH SLEEPER
- 42 2X SOLID LEDGER WITH 6-16D EA STUD
- 43 2-16D EACH JOIST BELOW
- ROOF SHEATHING


## LEGEND

[illegible]

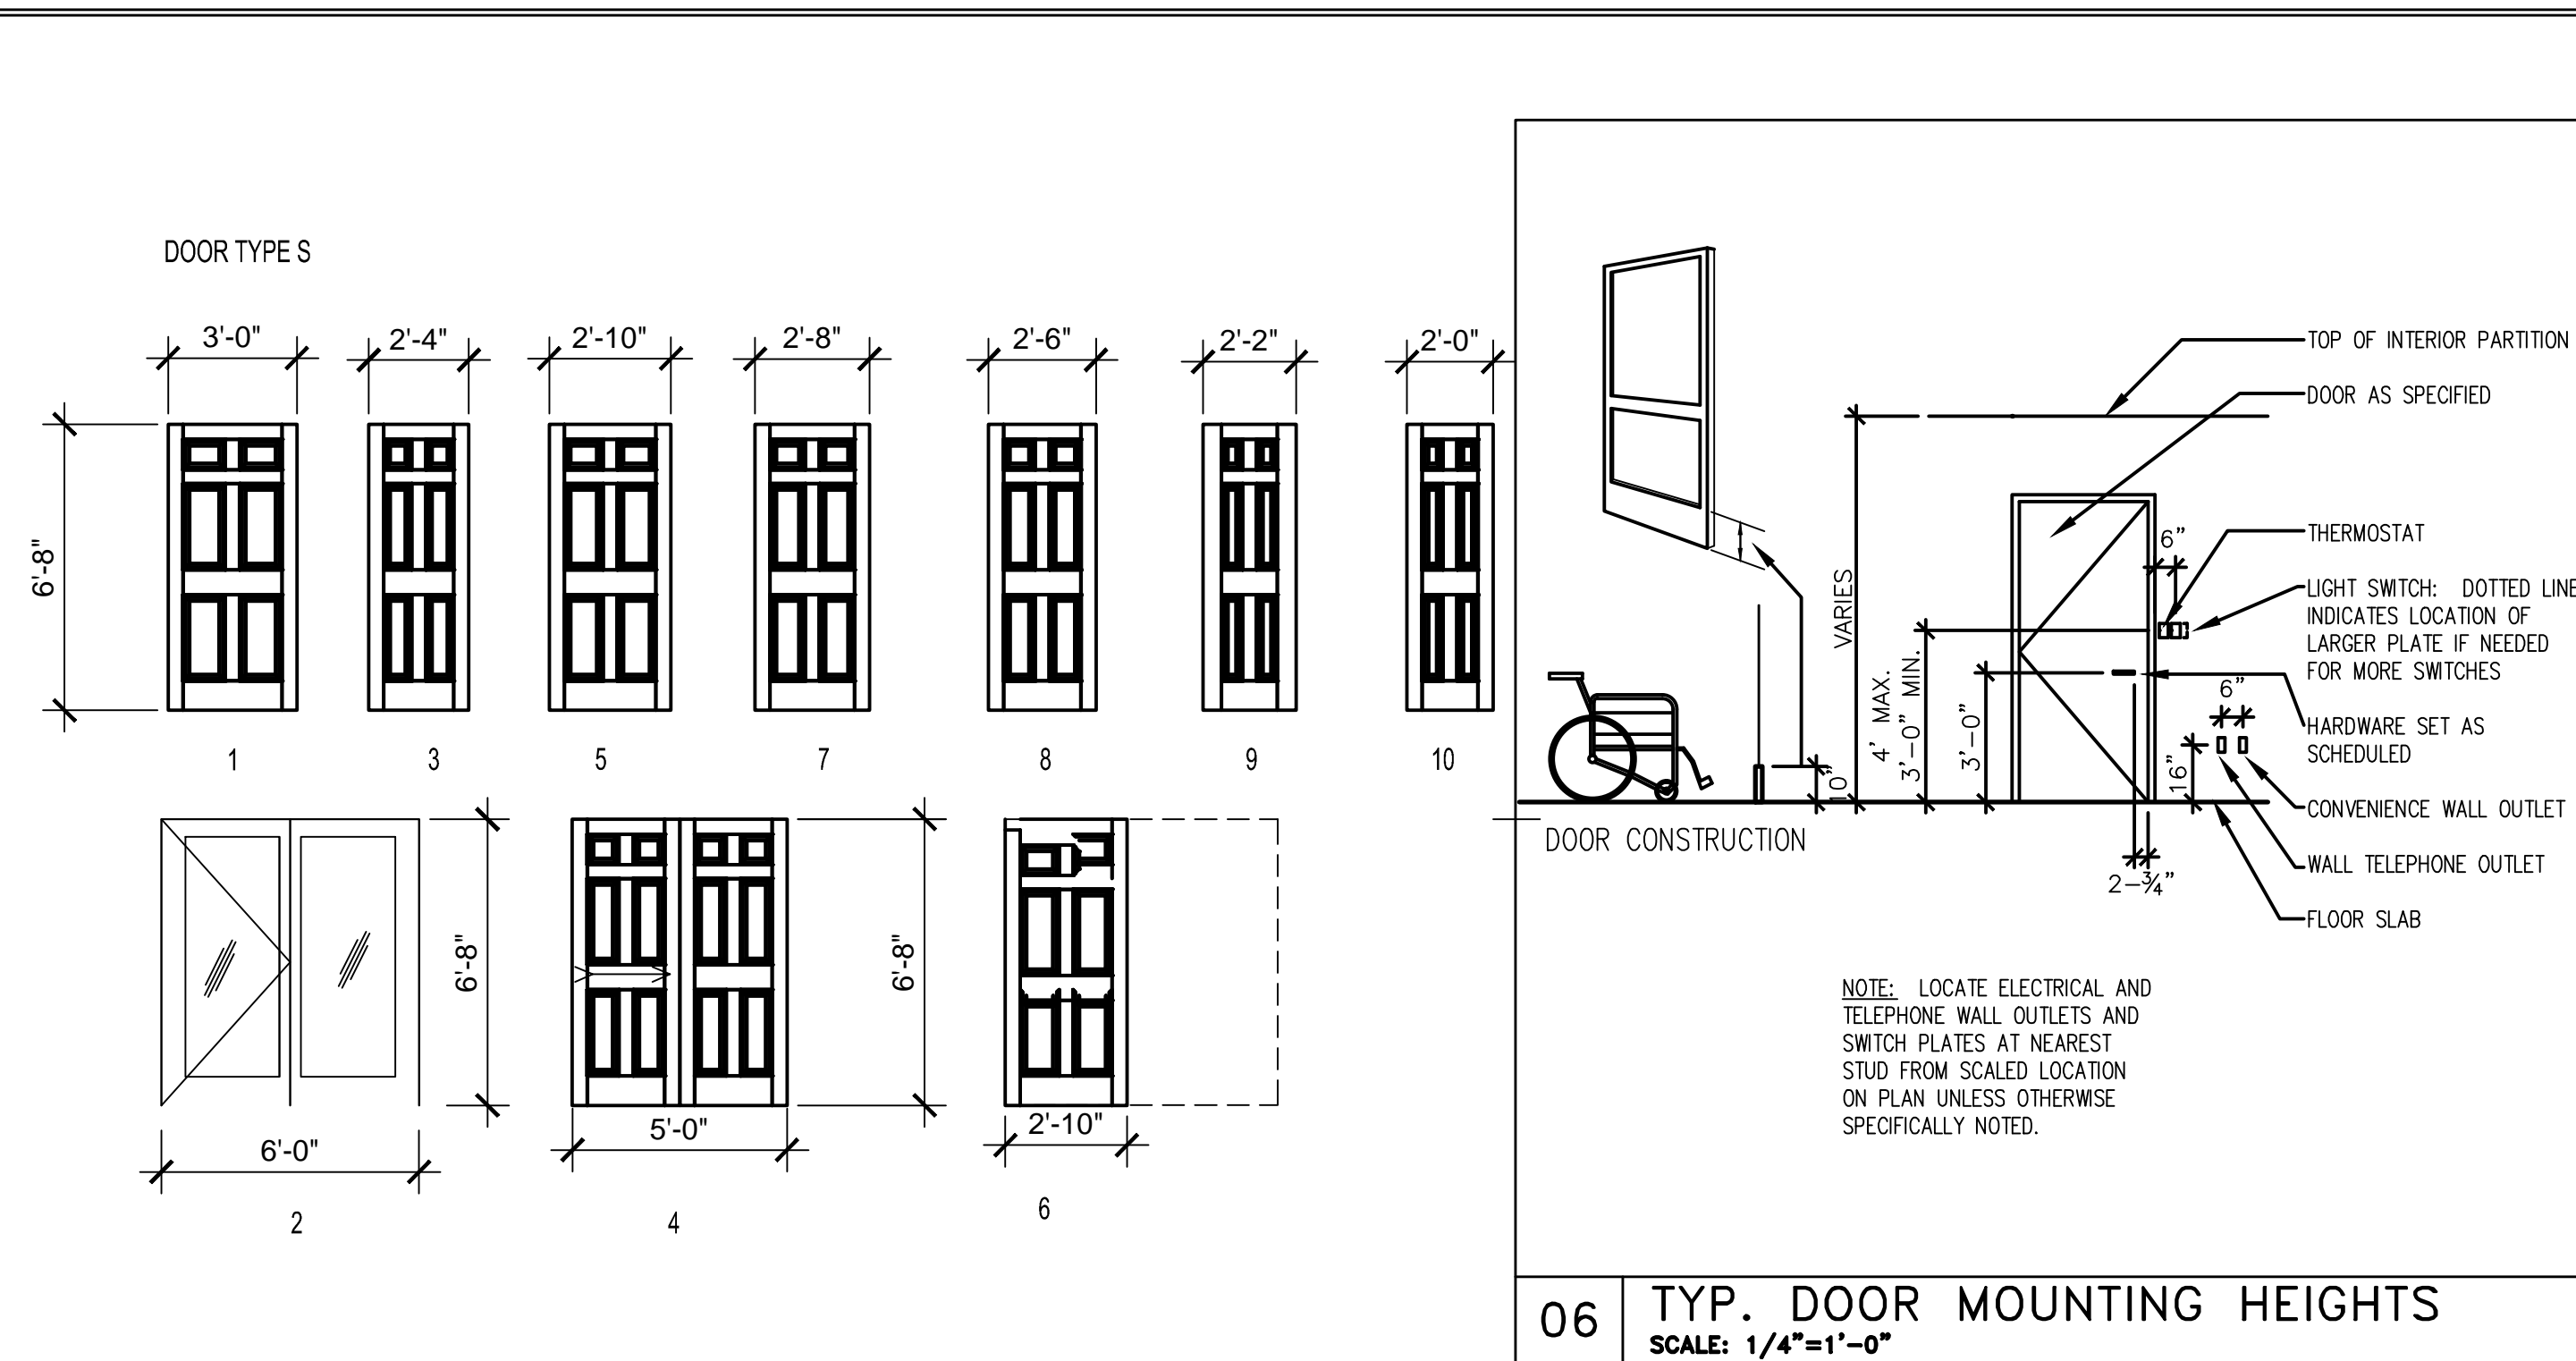02	FRAME AND DOOR TYPES	ABBREVIATIONS
----	----------------------	---------------

- |   |  |   |  |       |                           |
|---|--|---|--|-------|---------------------------|
| A | THRESHOLD HEIGHT SHALL NOT EXCEED 1/2" MAX. (ABOVE FLOOR AND LANDING ON BOTH SIDES) AT BUILDING ENTRANCE AND ALL DOORS, SEE DET. 21/A9.2   | I | IF THERE ARE OMISSIONS IN HARDWARE GROUPS, THEY SHALL BE CALLED TO THE ATTENTION OF THE ARCHITECT/ENGINEER FOR INSTRUCTIONS. | WD    | WOOD                      |
| B | FOR DOOR FINISHES REFER TO SPECIFICATION.  | J | ALL DOORS SWINGING OVER CARPETED AREAS SHALL BE UNDERCUT TO CLEAR FINISHED FLOOR.  | MTL   | METAL                     |
| C | SEE 6/A9.1 FOR TYP. MOUNTING HEIGHTS FOR DOOR HARDWARE.  | K | PROVIDE INTERNATIONAL SYMBOL OF ACCESSIBILITY AT THE MAIN ENTRANCE. (MOUNT @ 60" A.F.F.) PER 2007 CBC 1117B.5.               | DH    | DOOR HEIGHT, SEE SCHEDULE |
| D | ALL HARDWARE AT ACCESSIBLE DOORS SHALL COMPLY W/ CBC, CHAPTER 10 AND TITLE 24 (1.2).   | P | POINT  | PT    | PAINT                     |
| E | ALL DOOR FRAMES SHALL BE INSTALLED WITH 3 DOOR SILENCERS U.O.N.  | L | X  | LG    | LAMINATED GLASS           |
| F | EXIT DOORS SHALL BE OPERABLE FROM THE INSIDE WITHOUT THE USE OF KEY OR SPECIAL EFFORT PER LOCAL CODE. LEVER TYPE HARDWARE SHALL BE USED THROUGHOUT - SCHLAGE RHODES LEVER, U.N.O. AND WHICH WILL COMPLY WITH CBC 1003.3.1.8  | M | HARDWARE GROUP: REFER TO SPECIFICATION FOR DESCRIPTION OF HARDWARE CONTAINED WITHIN GROUPING.                                | HM    | HOLLOW METAL DOOR         |
| G | MAXIMUM EFFORT TO OPERATE DOORS SHALL NOT EXCEED 5 POUNDS FOR EXTERIOR DOORS AND 5 POUNDS FOR INTERIOR DOORS. WHEN FIRE DOORS ARE REQUIRED, THE MAXIMUM EFFORT TO OPERATE DOOR MAY BE INCREASED NOT TO EXCEED 15 POUNDS.   | N | CONTRACTOR TO VERIFY ALL ROUGH OPENING DIMENSIONS AS REQUIRED TO MATCH DOOR SIZE SHOWN.                                      | ANOD  | ANODIZED                  |
| H | WHILE THE HARDWARE SCHEDULE IS INTENDED TO COVER ALL DOORS OF THE BUILDING, AND TO ESTABLISH A TYPE AND STANDARD OF QUALITY, IT SHALL BE THE SPECIFIC DUTY AND RESPONSIBILITY OF THE FINISH HARDWARE SUPPLIER TO EXAMINE THE PLANS AND SPECIFICATIONS, AND FURNISH PROPER HARDWARE FOR ALL OPENINGS WHETHER LISTED OR NOT. | P | FOR DOOR AND FRAME DETAILS REFER TO SHEET AX.1   | PF    | PREFINISHED               |
|   |  | Q | ROOM NUMBERS AND BUILDING SIGNAGE TO BE VANDAL RESISTANT.  | FB    | FIBERGLASS                |
|   |  | R | ALL INTERIOR DOORS TO BE STAVE CORE HOOD DOORS.  | MDF   | MOLDED WOOD COPOSITE      |
|   |  | S | PROVIDE WEATHER STRIPPING AT ALL EXTERIOR DOORS.   | PF    | PREFINISHED               |
|   |  |   |  | SC    | SOLID CORE                |
|   |  |   |  | HC/SS | HOLLOW CORE,SOLID STILE   |

<b>01</b>	<b>DOOR SCHEDULE</b>	<b>03</b>	<b>GENERAL NOTES</b>	<b>DOOR SCHED. SYMBOL</b>
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[illegible]
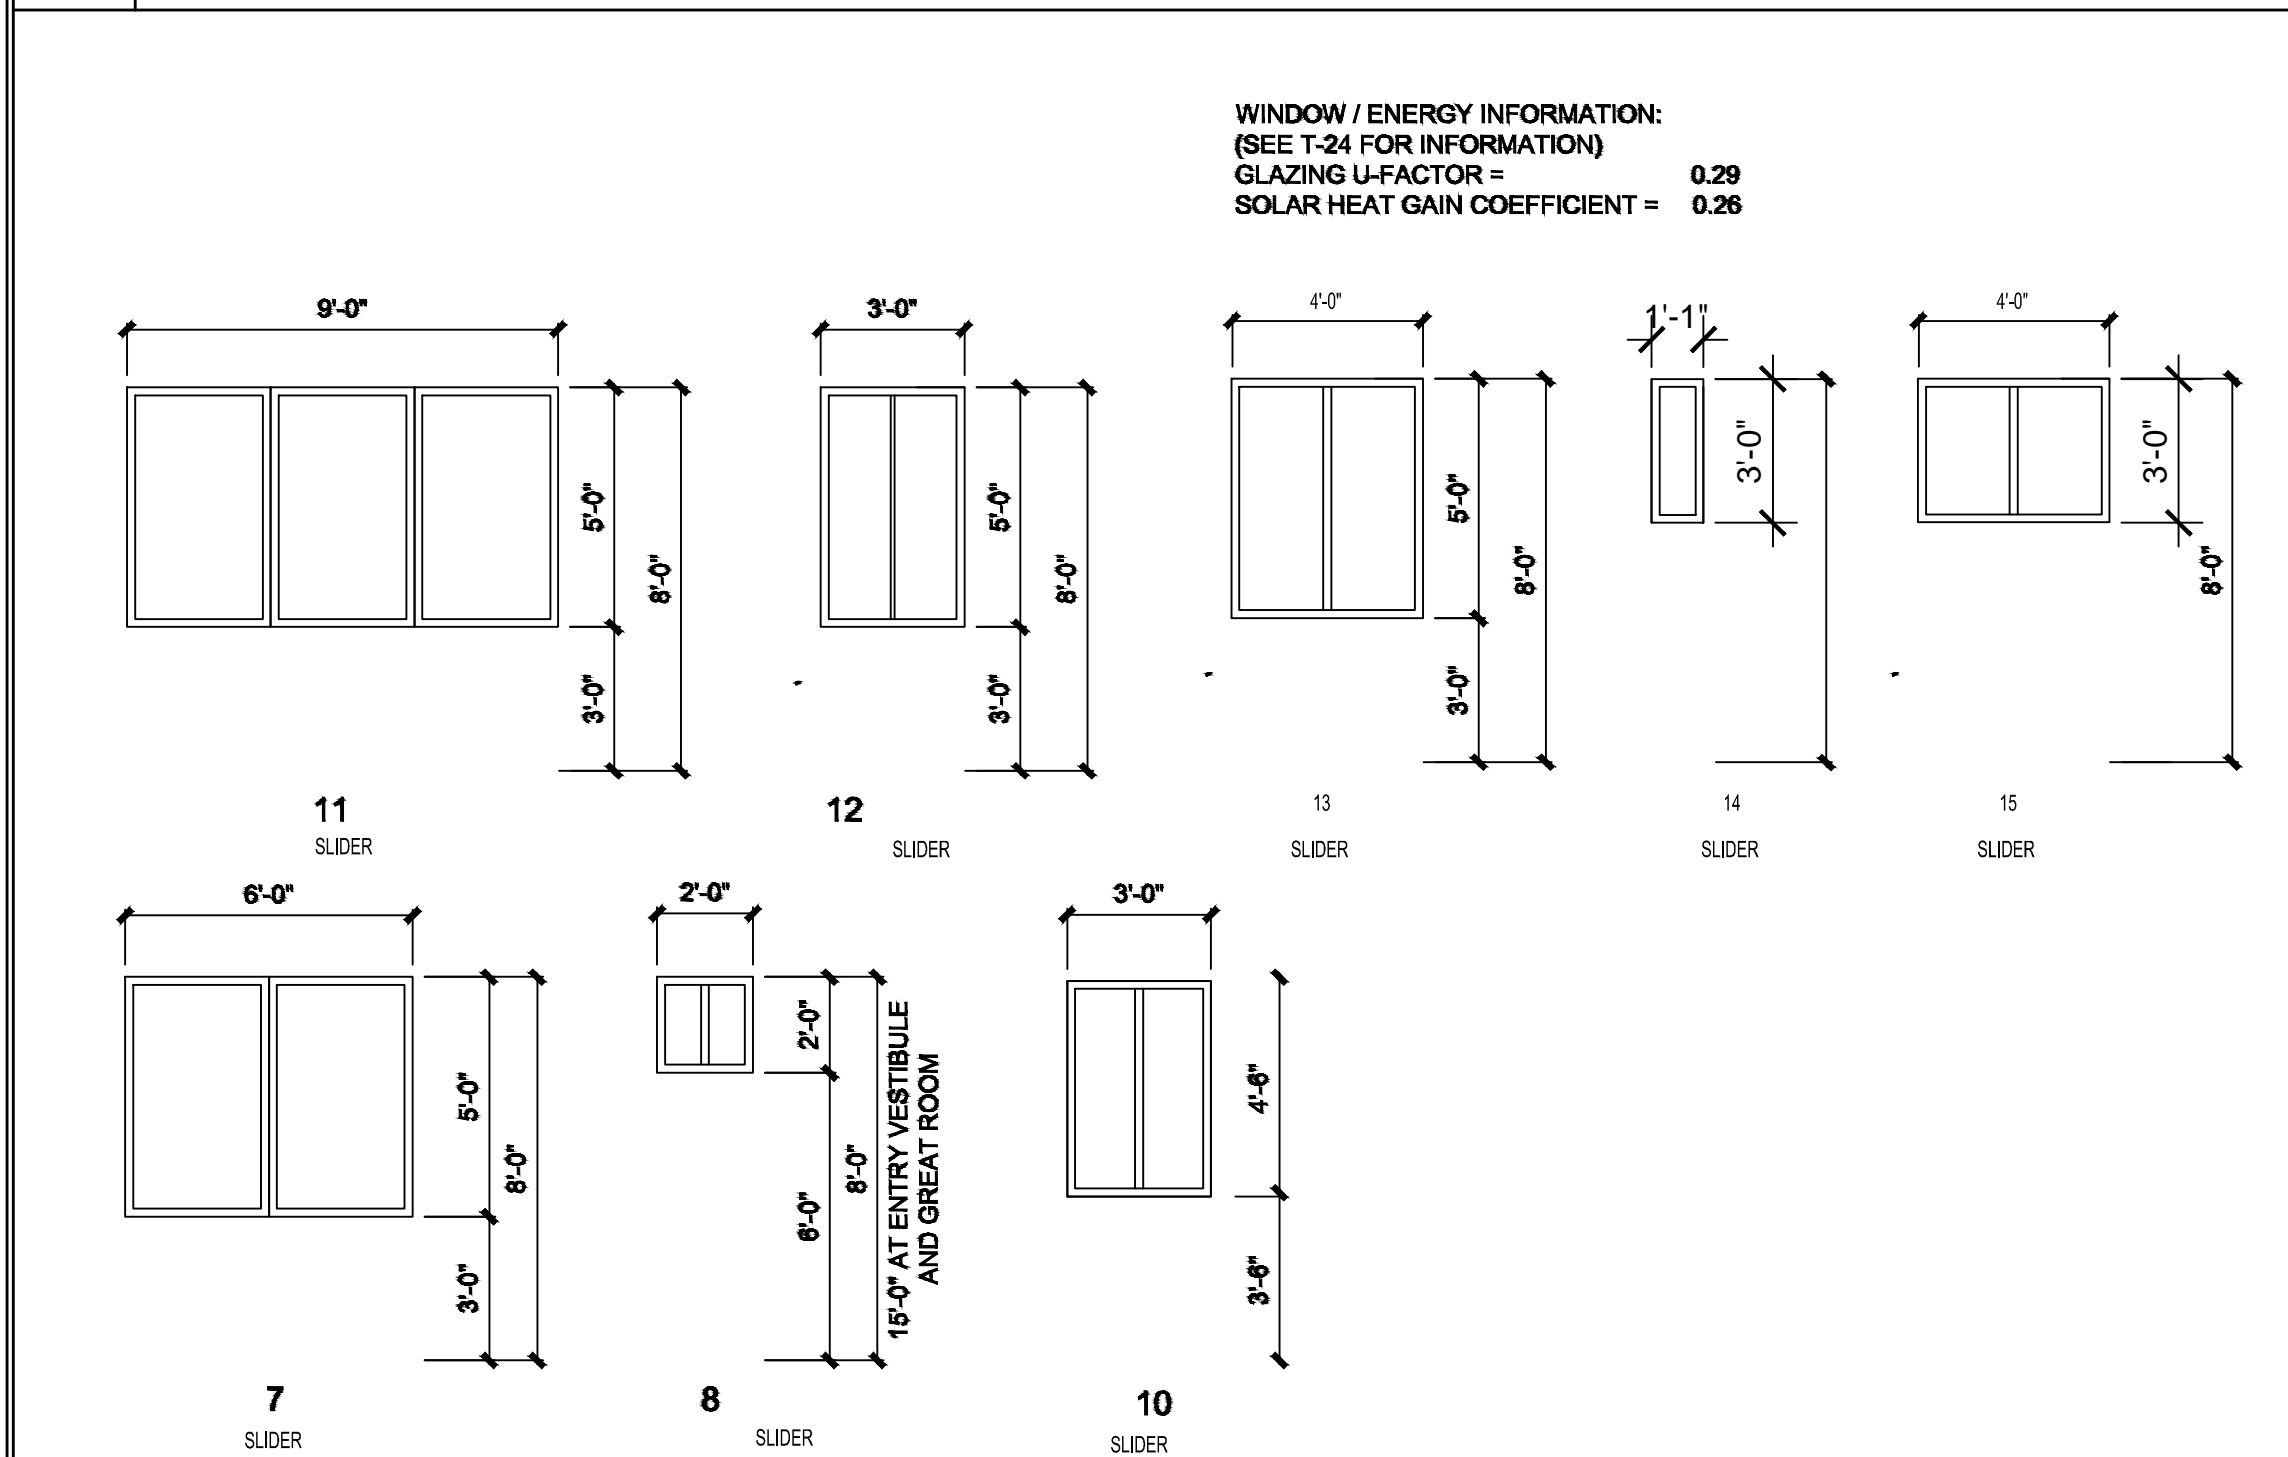
## WINDOW NOTES:

INSTALL DEVICES WHICH ALLOW WINDOWSTO BE LOCKED FROMINTERIOR

ALL WINDOWS SHALL BE DUAL GLAZED WITH WEATHER-STRIPPEDDOOR INFILTRATION FRAMES MEETING ANSI AIR INFILTRATION STANDARDS.

SAFETY GLAZING SHALL BE INSTALLED IN THE FOLLOWING LOCATIONS: PER (2010)CBC 2406.3)

1. GLAZING IN SWINGING DOORS EXCEPT JALOUSIES
2. GLAZING IN SLIDING AND SLIDING PANELS OF SLIDING DOOR ASSEMBLIES AND PANELS IN SLIDING AND BI-FOLD CLOSET DOOR ASSEMBLIES
3. GLAZING IN STORM DOORS
4. GLAZING IN UNFRAMED SWINGING DOORS
5. GLAZING IN DOORS AND ENCLOSURES FOR HOT TUBS, WHIRLPOOLS, SAUNAS, STEAM ROOMS, BATH-TUBS AND SHOWERS. GLAZING IN ANY PORTION OF A BUILDING WALL ENCLOSING THESE COMPARTMENTS WHERE THE BOTTOM EXPOSED EDGE OF GLAZING IS LESS THAN 60" ABOVE A STANDING SURFACE.
6. GLAZING IN INDIVIDUAL FIXED OR OPERABLE PANEL ADJACENT TO A DOOR WHERE THE NEAREST EXPOSED EDGE OF THE GLAZING IS WITHIN A 24" ARC OF EITHER VERTICAL EDGE OF THE DOOR IN A CLOSED POSITION AND WHERE THE TOP EDGE OF GLAZING IS LESS THAN 60" ABOVE THE WALKING SURFACE.


EXCEPTION:

AN INTERVENING WALL BETWEEN DOOR & GLAZING

04	WINDOW TYPE	05	WINDOW SCHED. SYMBOL
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<b>REVISIONS</b>	<b>BY</b>
9/26/2011 - PLAN CHECK	G.O.




 **OAKLEY & OAKLEY**  
ARCHITECTURAL & STRUCTURAL ENGINEERS  
1000 W. 10TH AVE., SUITE 615  
DENVER, CO 80202  
TEL. 557-5660 FAX 557-5660

PROJECT TITLE COMMUNITY CENTER HARBOR PARK APARTMENTS 369 PORTER STREET, VALLEJO, CA 94560	DRAWING TITLE DOOR & WINDOW SCHEDULE
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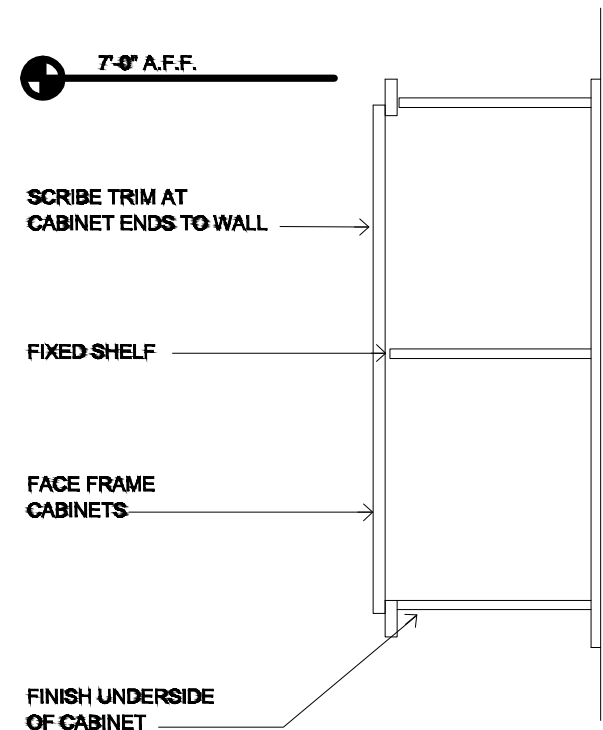
Date:	04/17/2012
Scale:	AS NOTED
Drawn:	STAFF
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Job No.:	2011-09
Sheet:	<b>A9.1</b>
Of	Sheets




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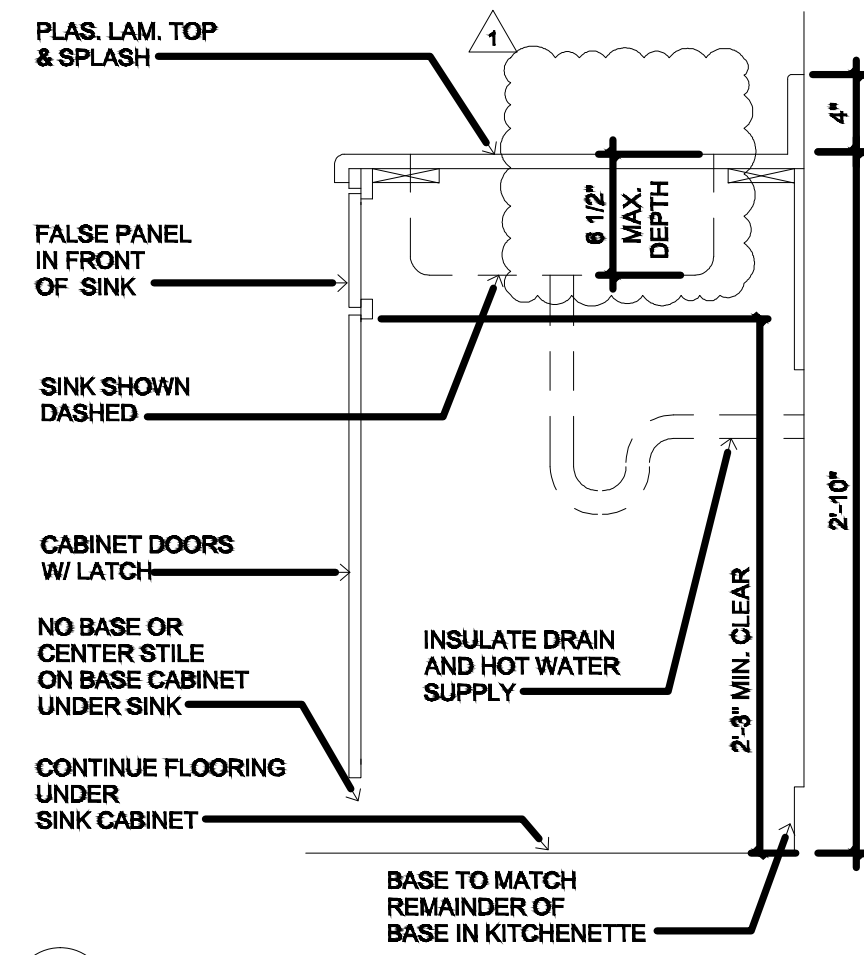
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SCALE 3\"/>

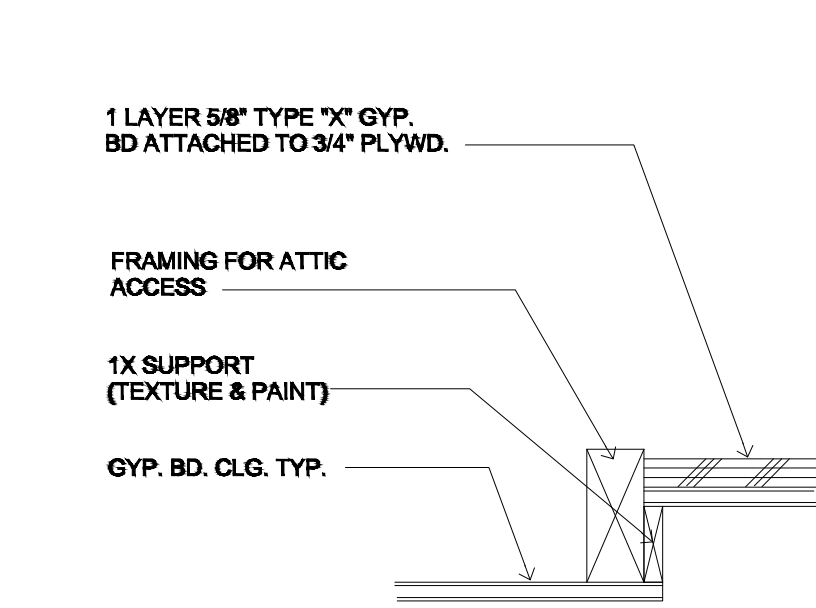


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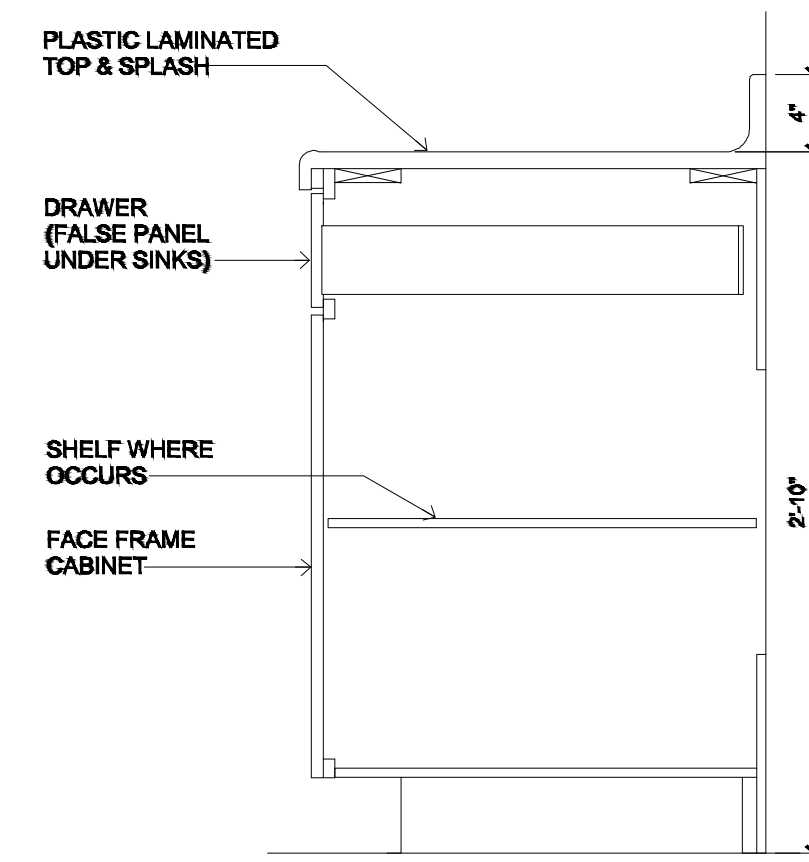
3 CABINET AT WALL  
FULL SCALE




4 BASE CABINET  
WHEEL CHAIR ACCESSIBLE  
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5 BASE CABINET  
SCALE 1 1/2\"/>

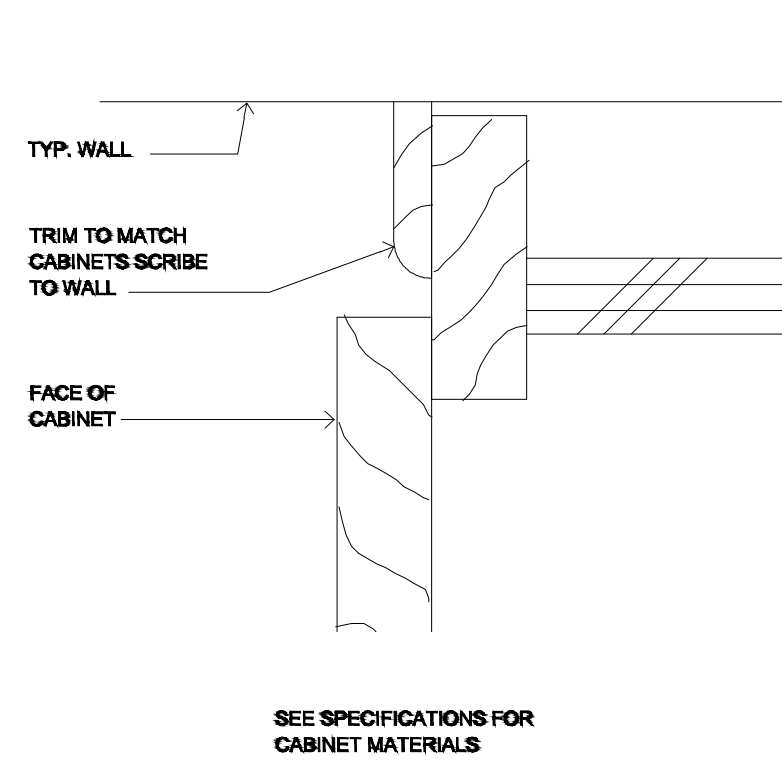


6 BASE CABINET  
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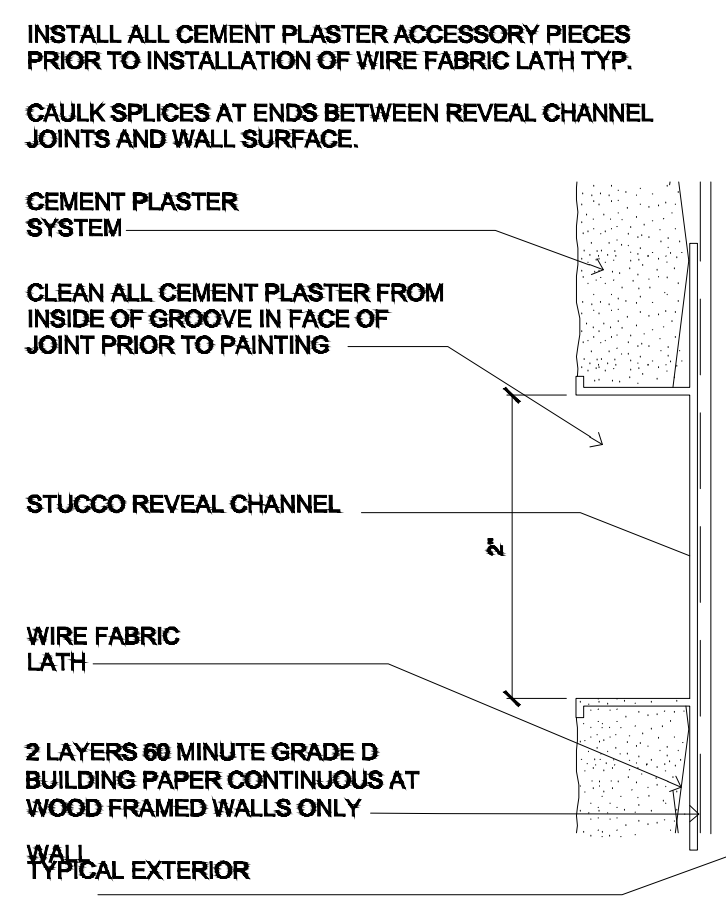


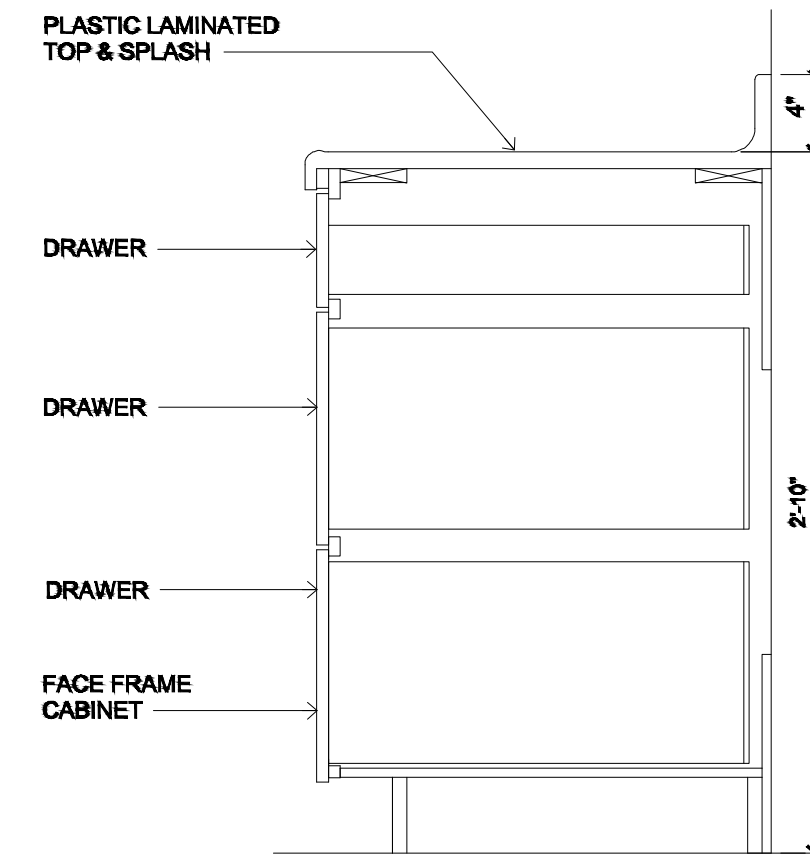CANOPY SCHEDULE	
TYPE	LENGTH
A1	4'-0"
A2	7'-0"
A3	10'-0"
A4	10'-0"


7 CANOPY  
SCALE 1\"/>

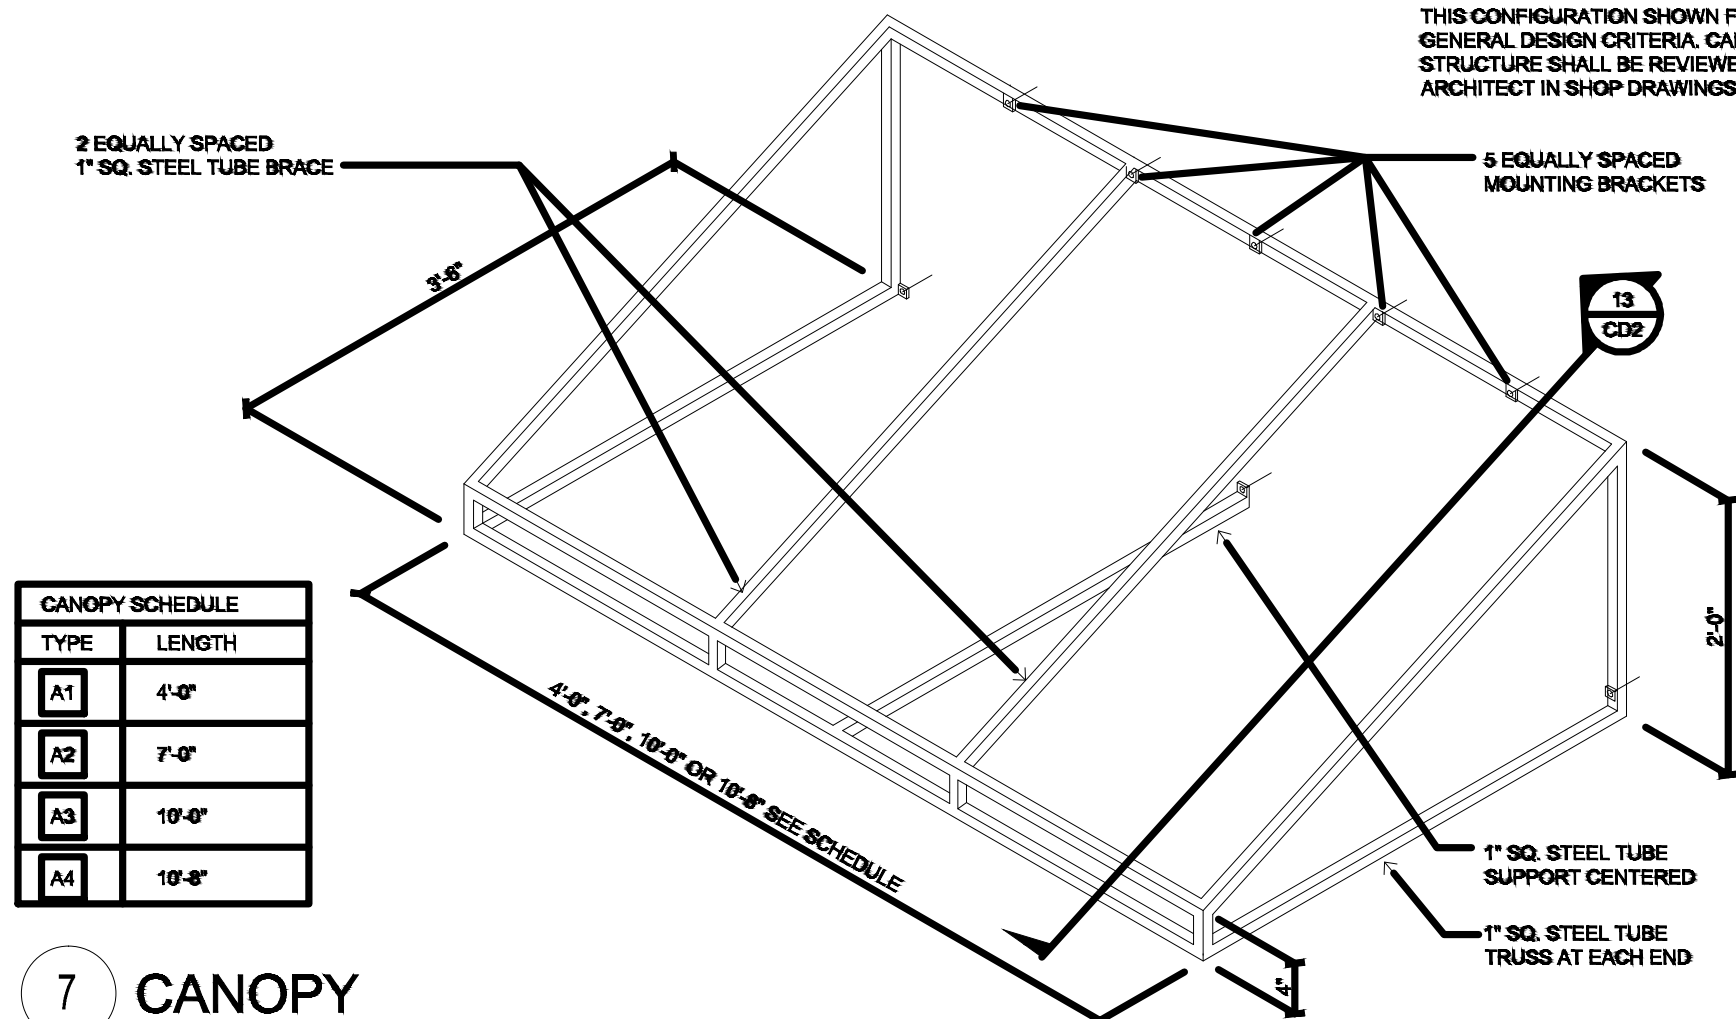

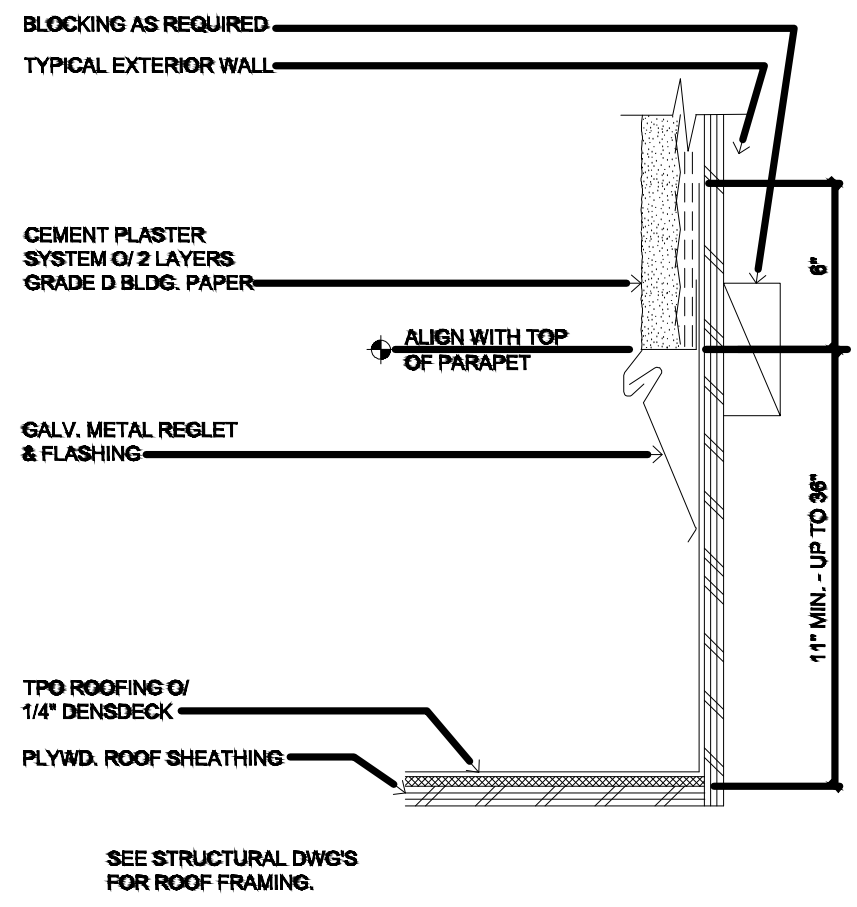
9 ROOF @ WALL  
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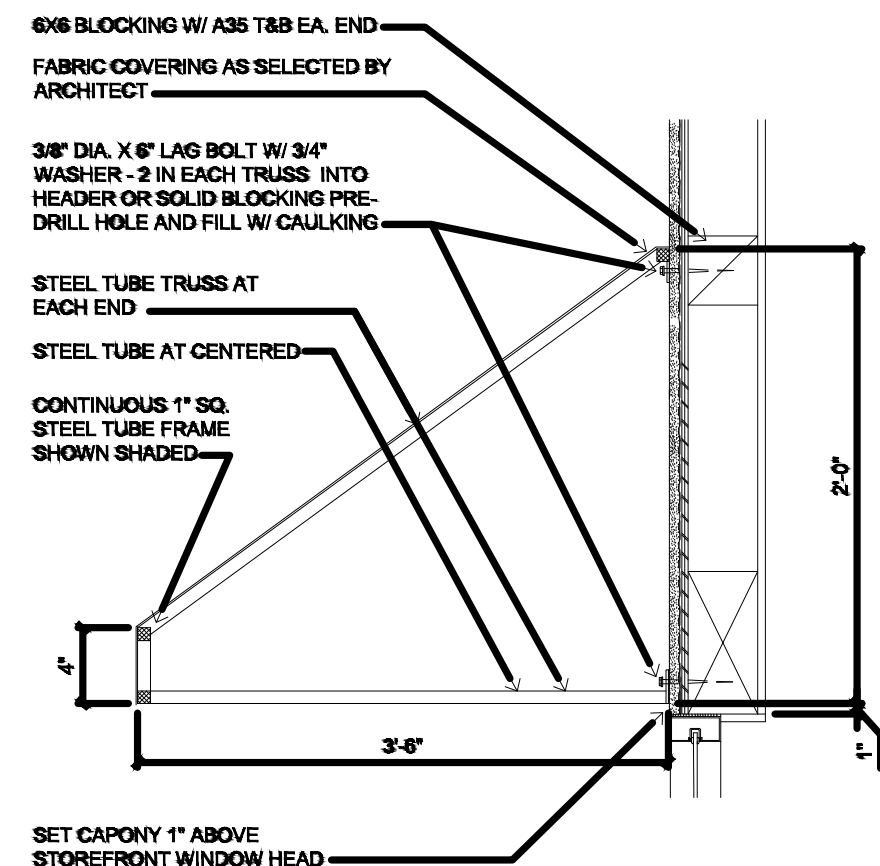
10 REVEAL  
FULL SCALE




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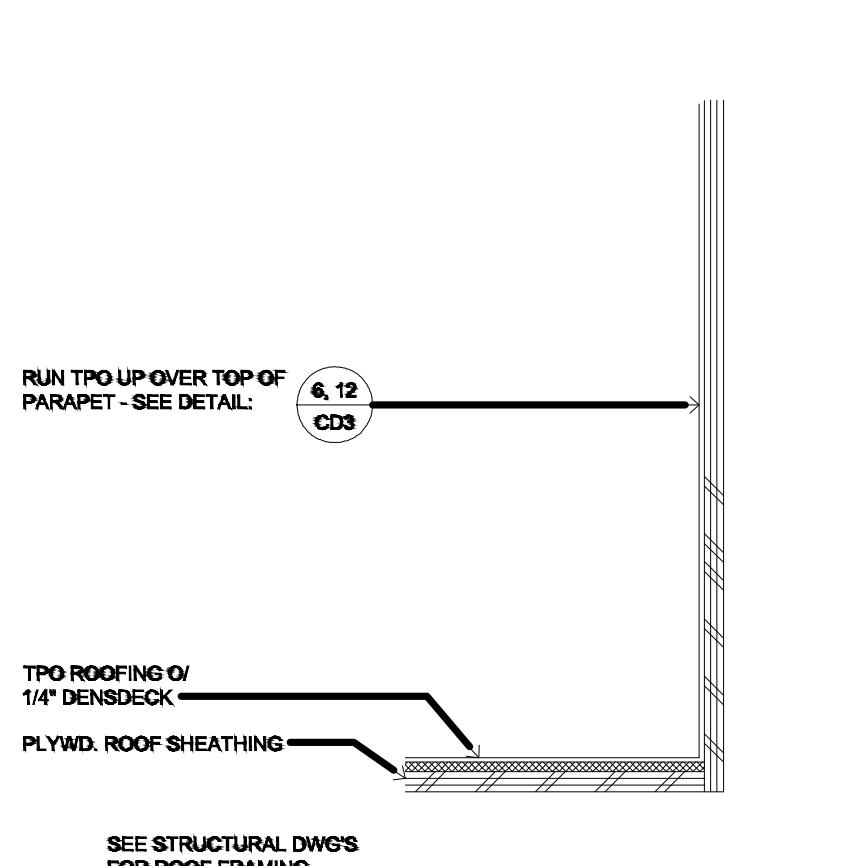
12 FIRE EXTINGUISHER CABINET  
SCALE 3\"/>

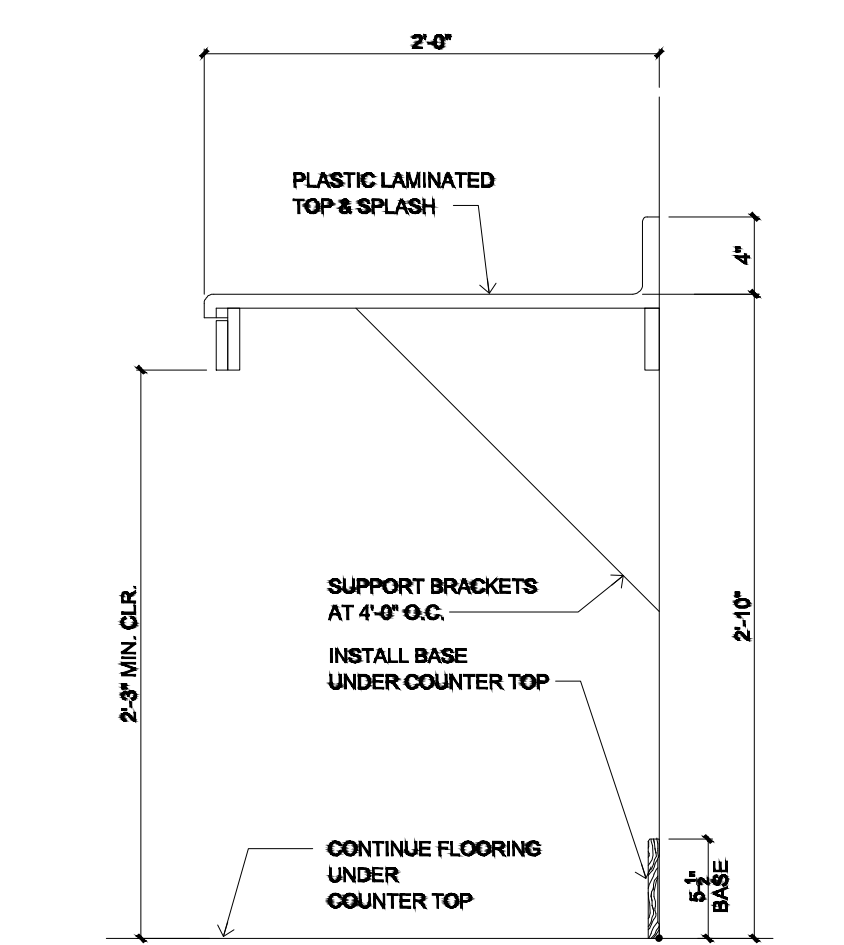


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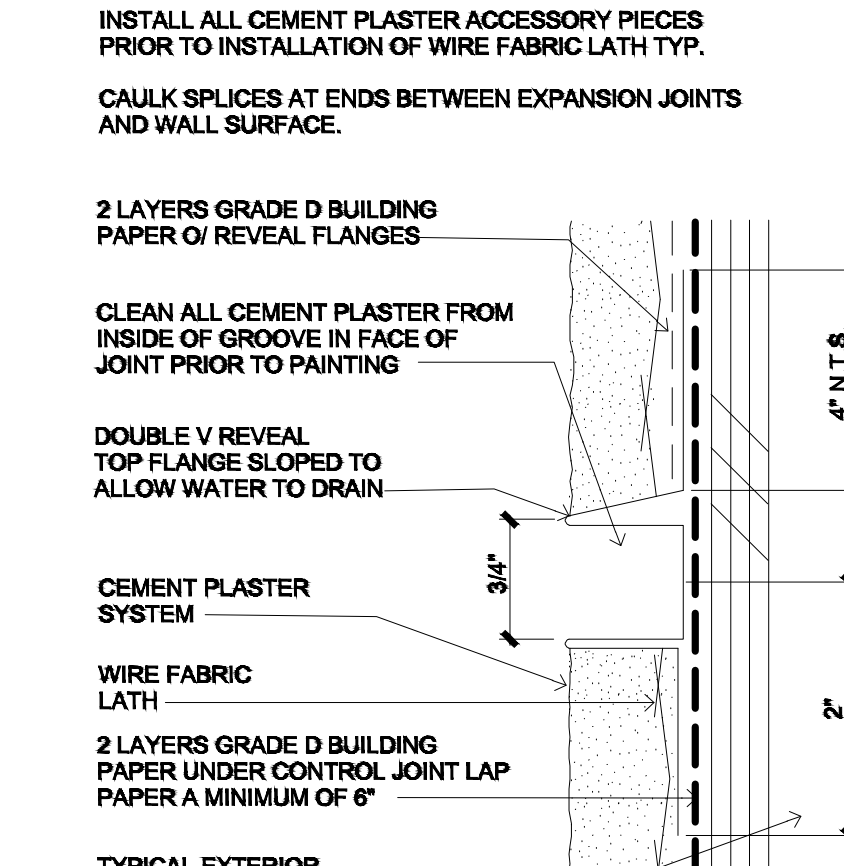
14 EXERCISE MIRROR  
FULL SCALE

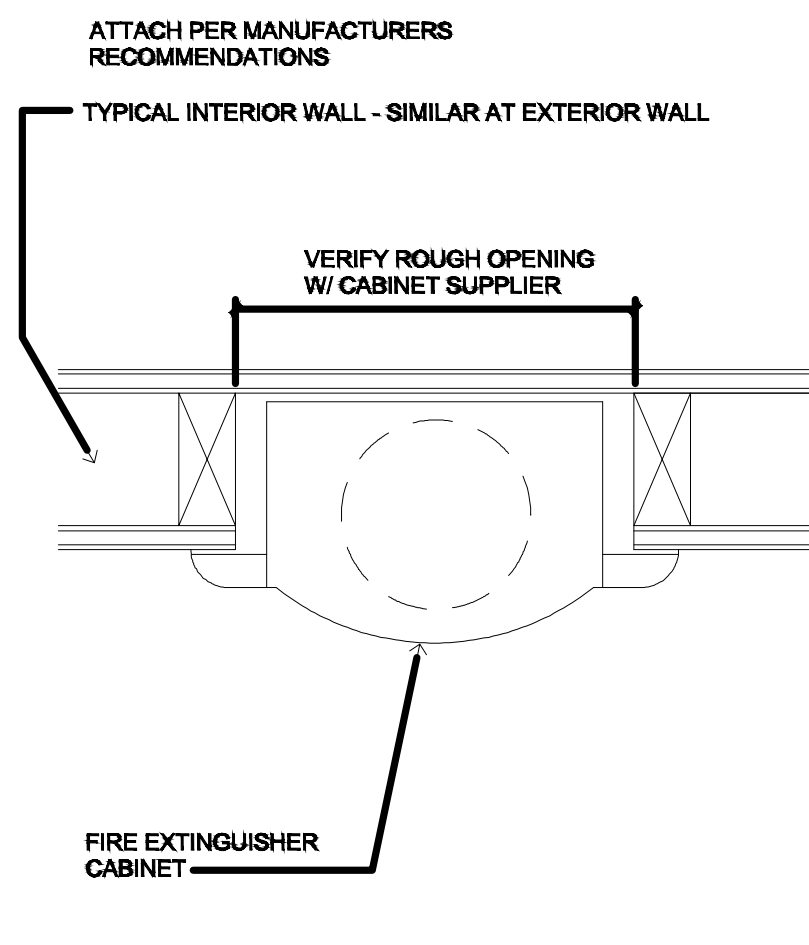


15 ROOF @ PARAPET  
SCALE 3\"/>

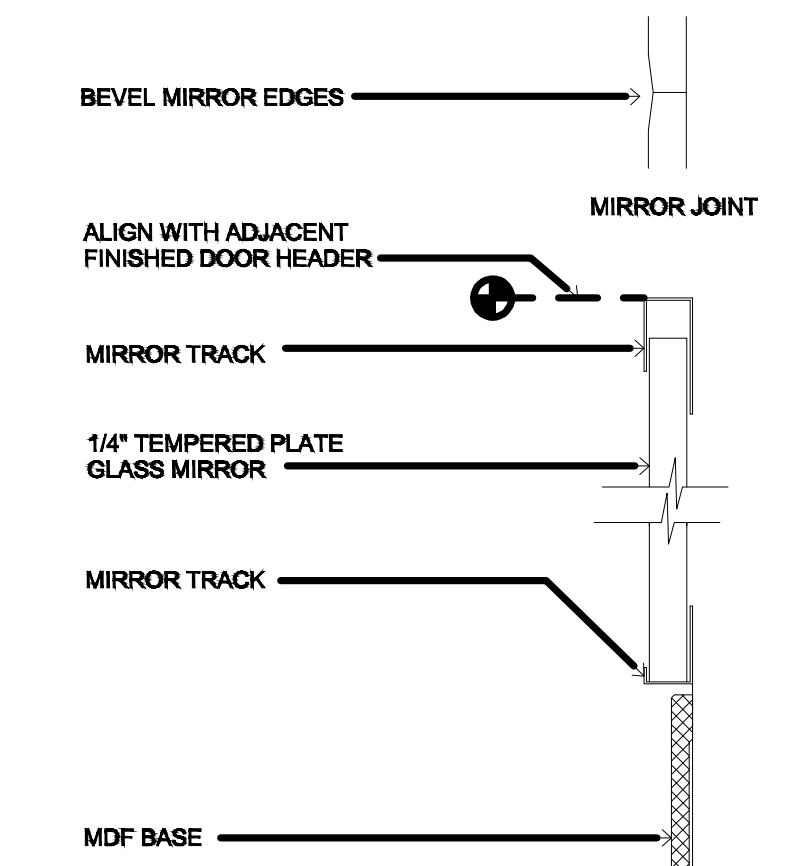


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FULL SCALE

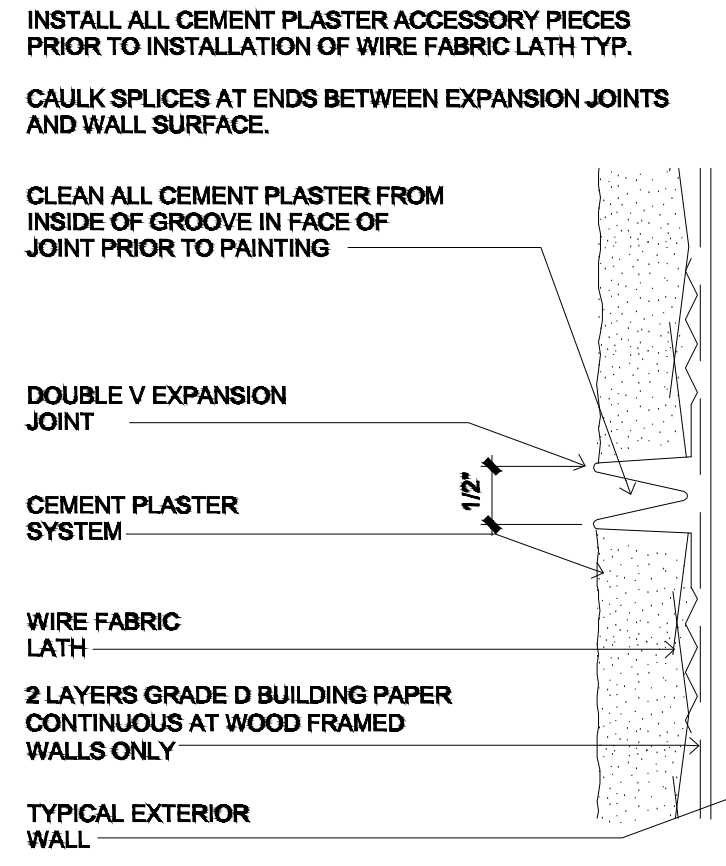


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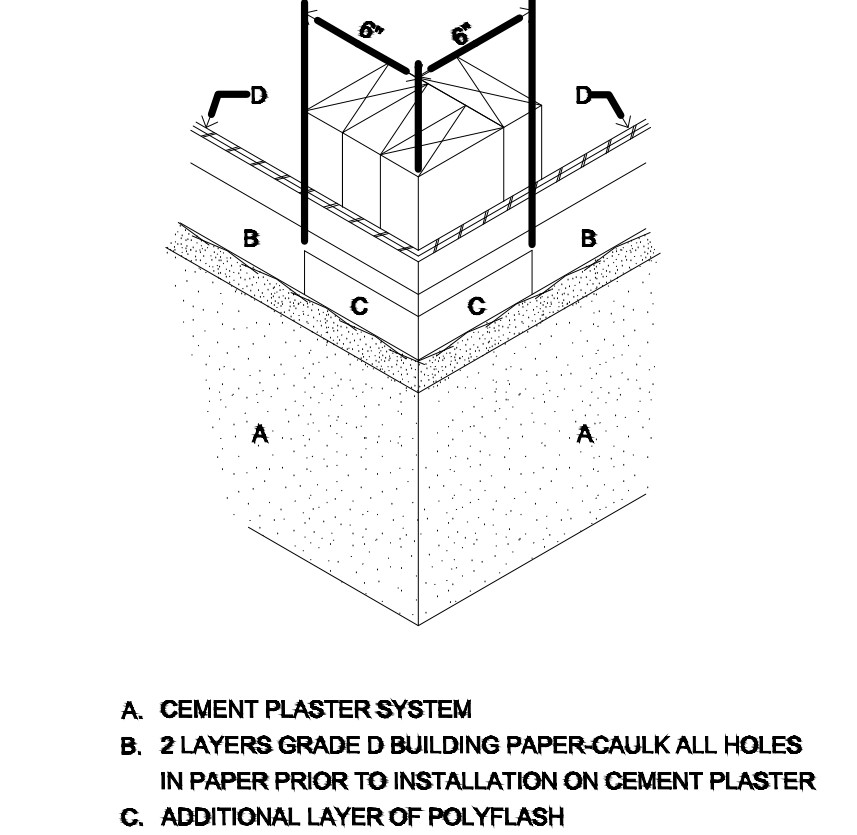
18 BASEBOARD  
FULL SCALE

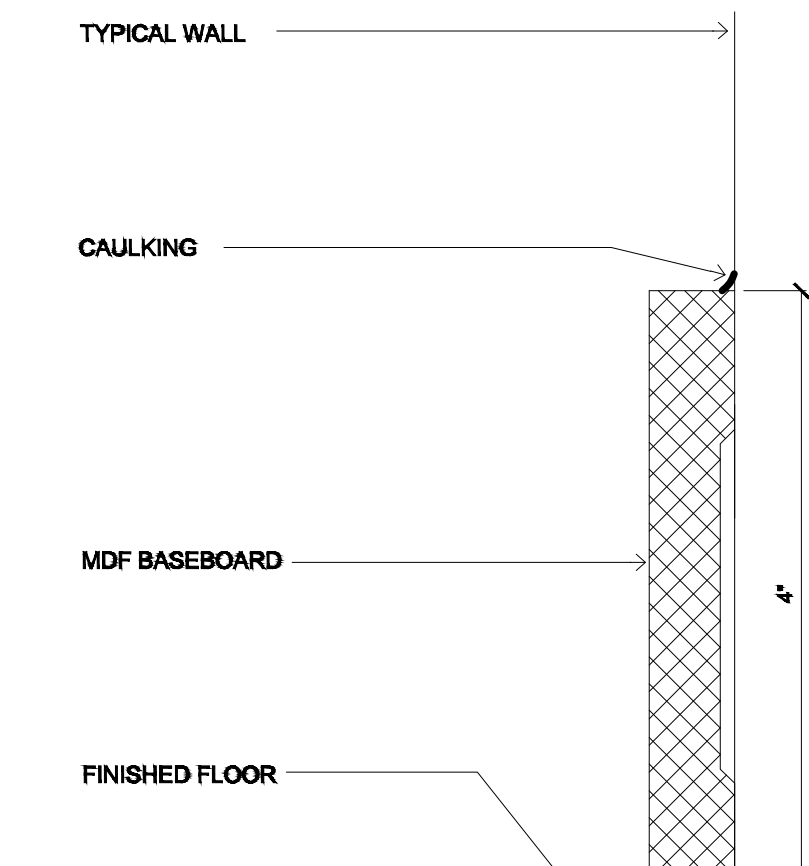


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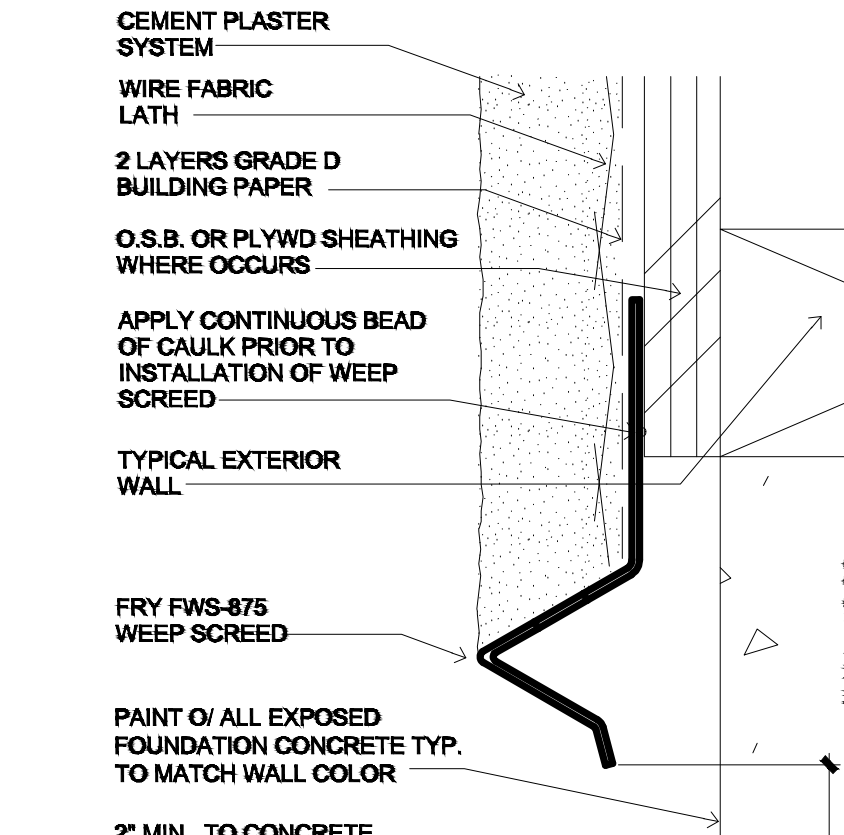
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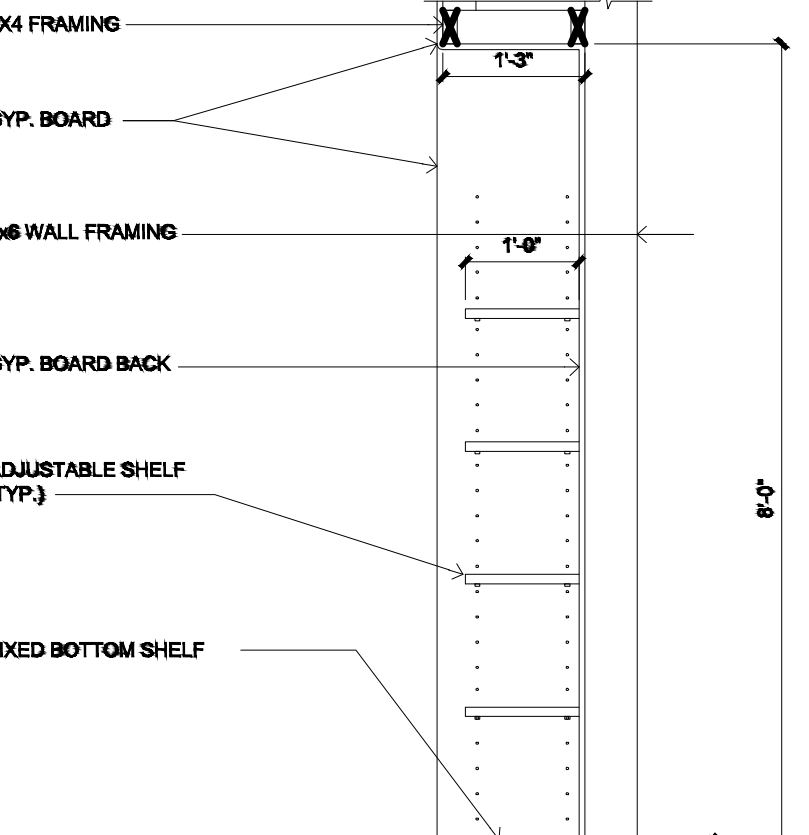
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22 PATIO / WALK TO WALL  
SCALE 6\"/>

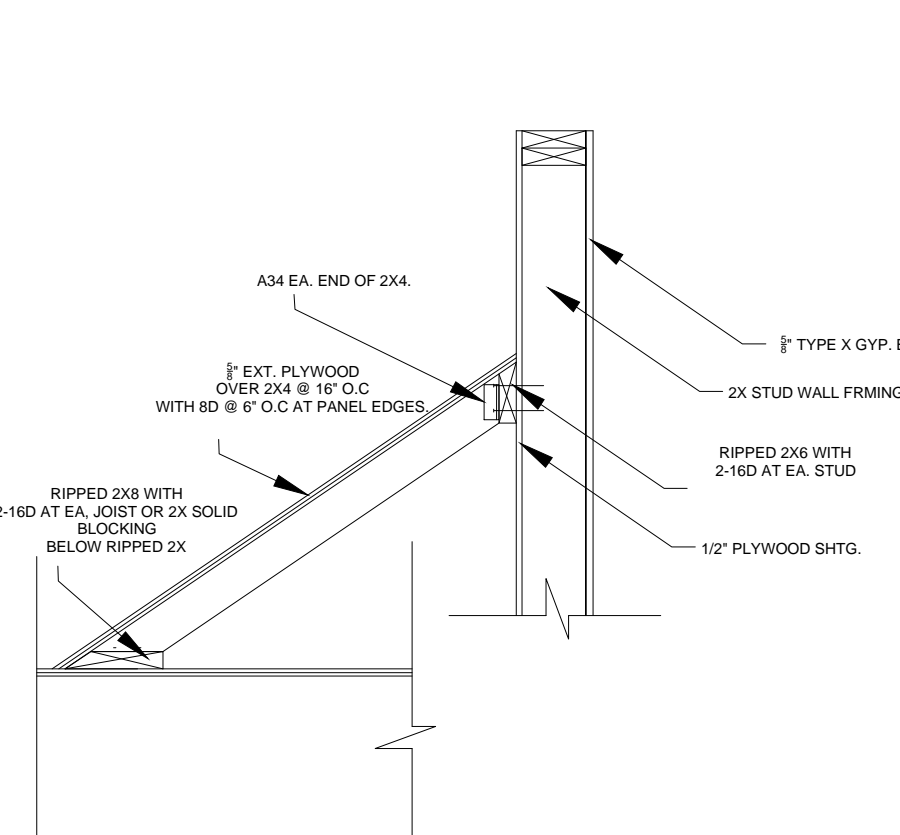


23 DRIP SCREED  
FULL SCALE

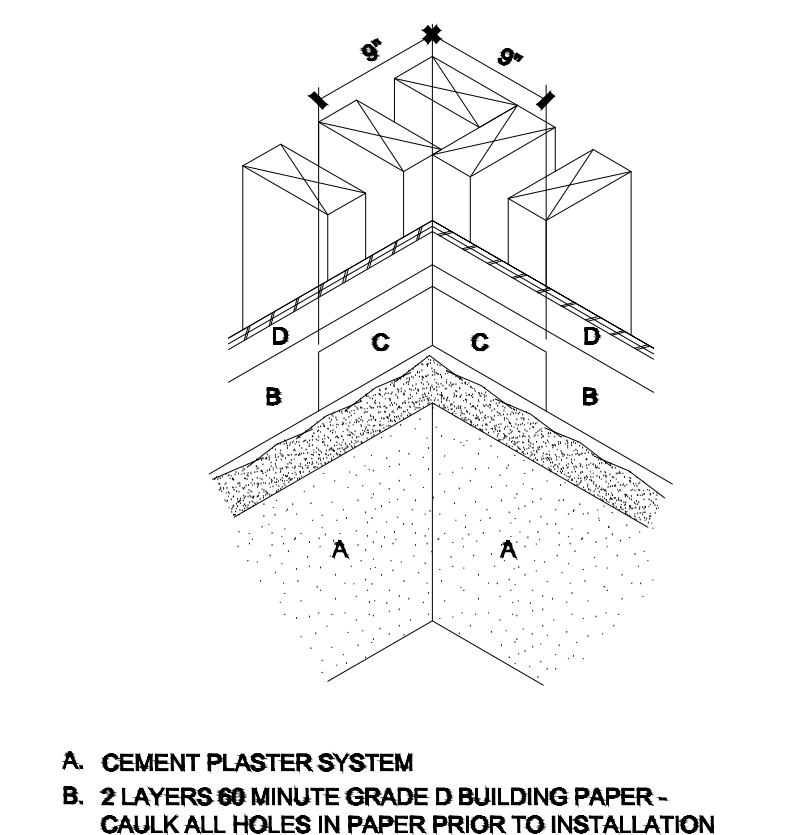

24 BUILT-IN SHELVING  
SCALE 3/4\"/>

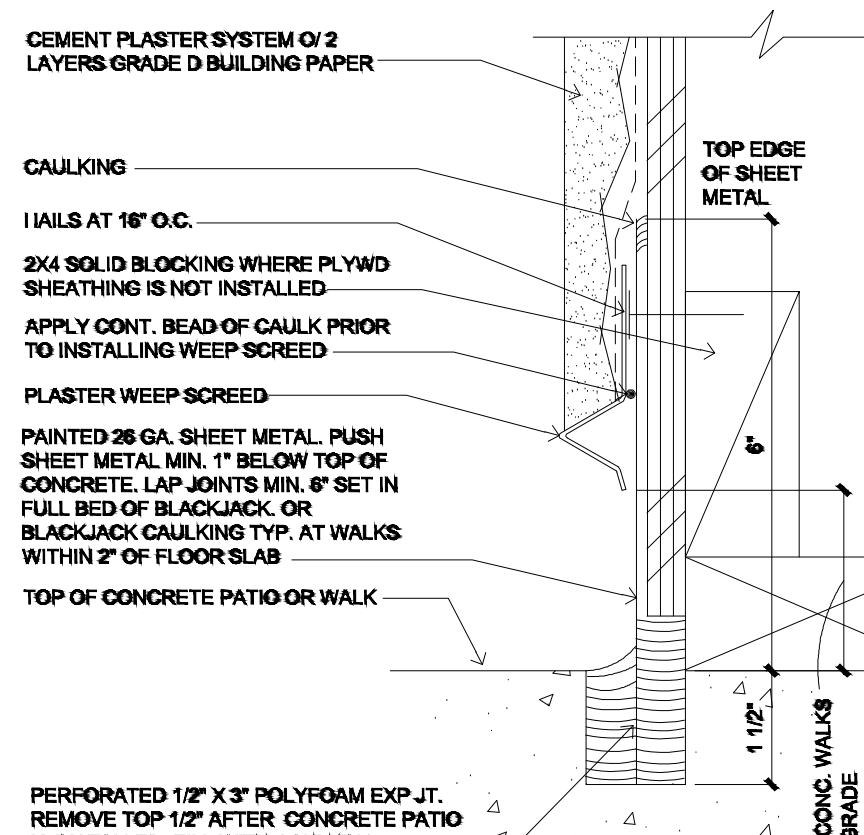REVISIONS	BY
9/26/2011 - PLAN CHECK	G.O.

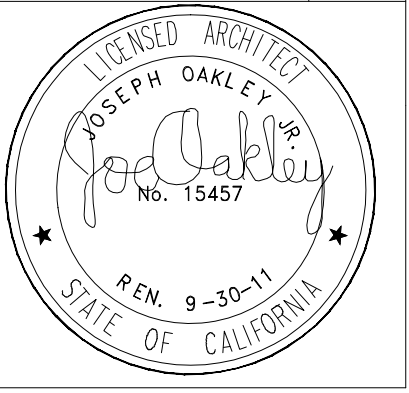


ARCHITECTURAL & STRUCTURAL ENGINEERS  
OAKLEY & OAKLEY  
7700 EDGEMONT DRIVE, SUITE 615  
DUBLIN, CA 94568  
TEL: 916.562.6028  
FAX: 916.562.6043

PROJECT TITLE:  
COMMUNITY CENTER  
HARBOR PARK APARTMENTS  
969 PORTER STREET, VALLEJO, CA 94560  
DRAWING TITLE:  
ARCHITECTURAL DETAILS

Date:	04/17/2012
Scale:	AS NOTED
Drawn:	STAFF
Checked:	RY
Job No.:	2011-09
Sheet:	

**A9.3**  
Of      Sheets

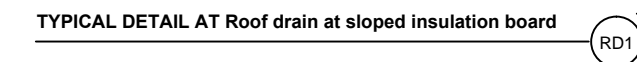

A circular professional seal for a Licensed Architect in the State of California. The outer ring contains the text "LICENSED ARCHITECT" at the top and "STATE OF CALIFORNIA" at the bottom, separated by two stars. Inside the ring, the name "JOSEPH OAKLEY" is written in a serif font, with "P.E." to the right. Below the name is the handwritten signature "Joe Oakley" and the license number "No. 15457". At the bottom of the seal, the text "REN. 9-30-11" is printed.


**OAKLEY & OAKLEY**  
ARCHITECT, CIVIL & STRUCTURAL ENGINEERS  
7700 EDGEWATER DRIVE, STE. 615  
OAKLAND, CA 94621  
510.562.6028  
FAX 510.562.6043

PROJECT TITLE: COMMUNITY CENTER  
HARBOR PARK APARTMENTS  
369 PORTER STREET, VALLEJO, CA 94560


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Drawn:	STAFF
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Job No.:	2011-09
Sheet:	<b>A9.41</b>
Of	Sheets


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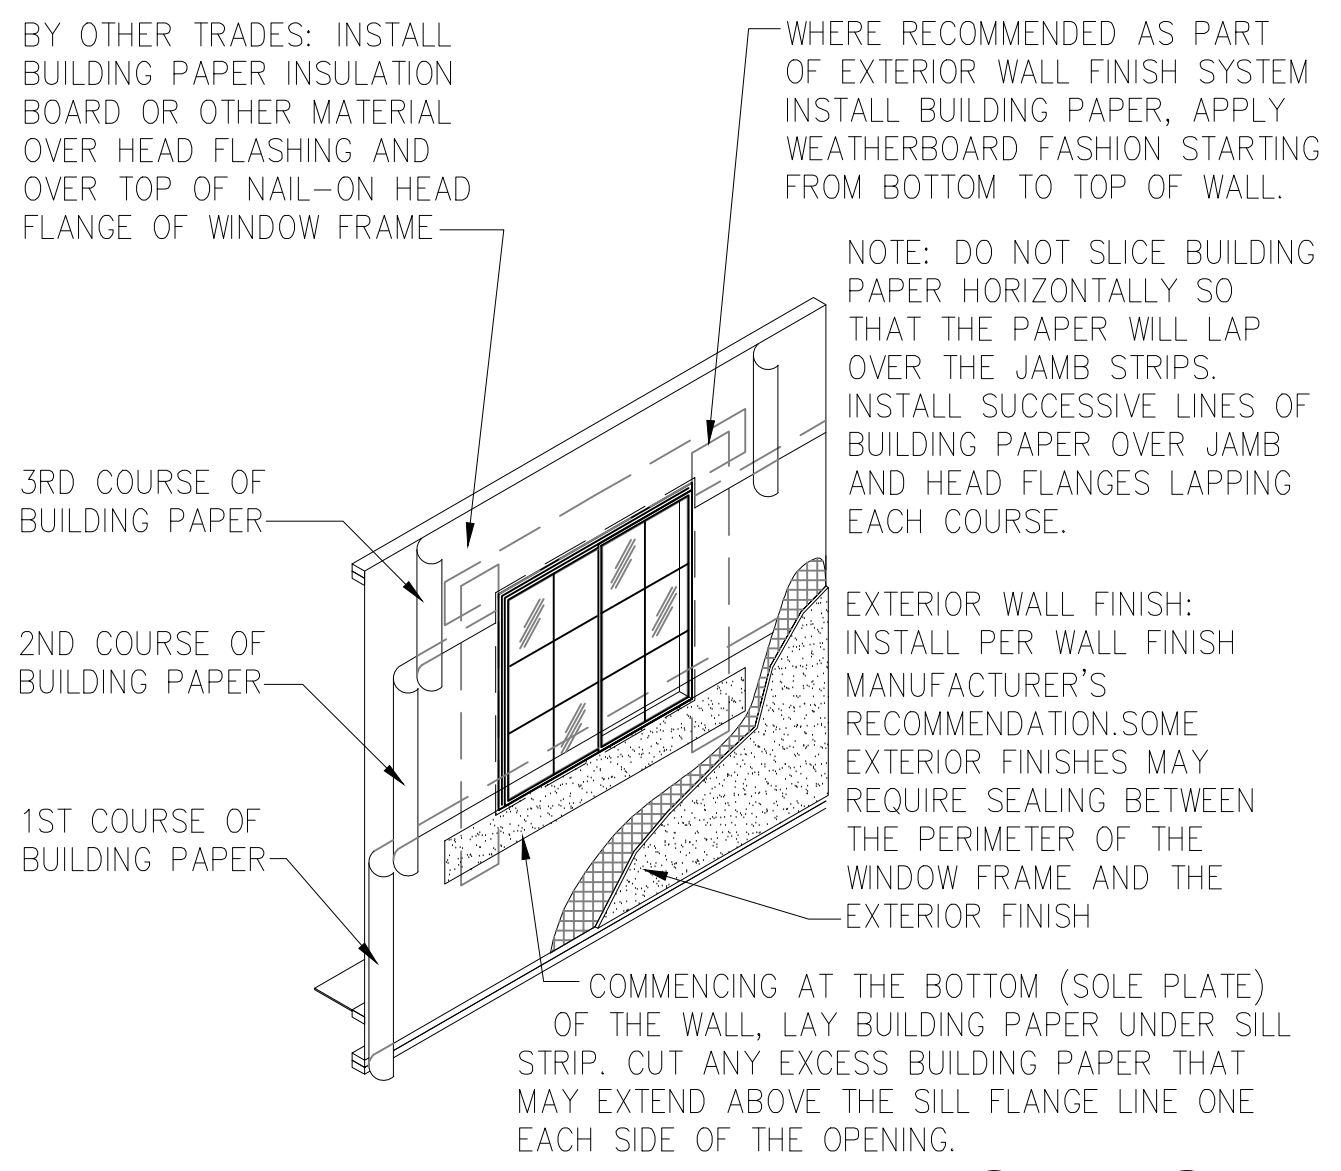
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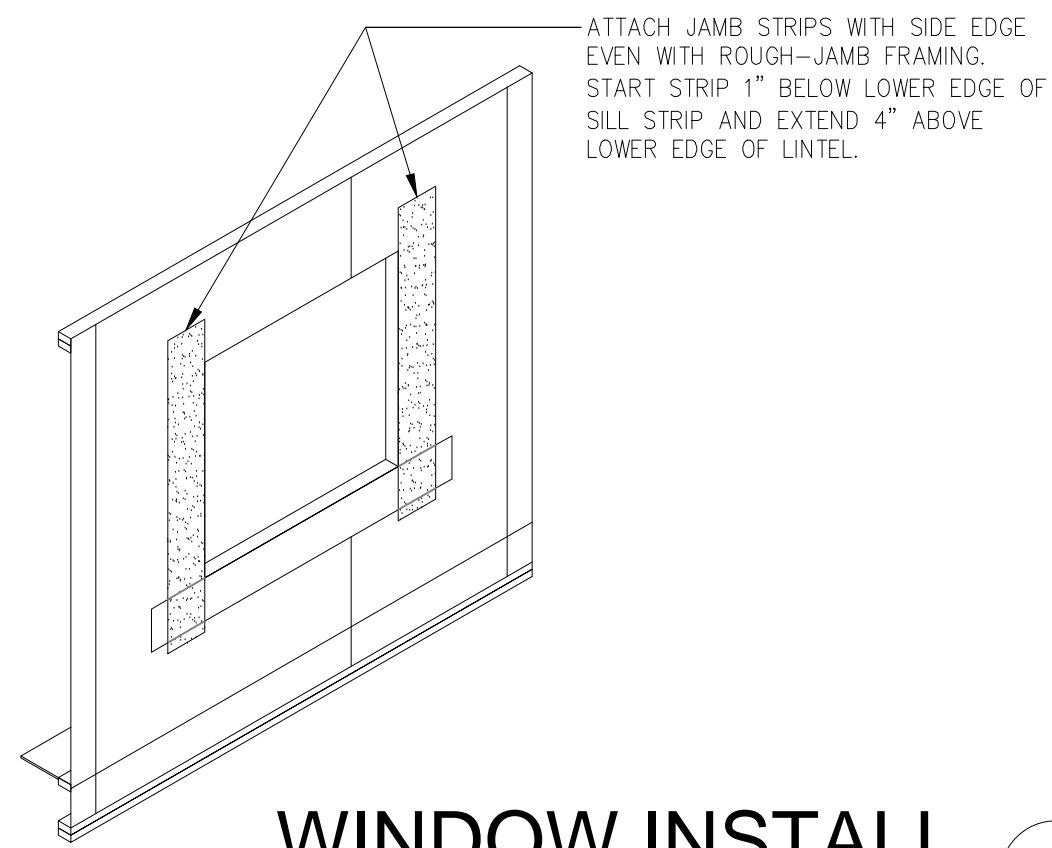
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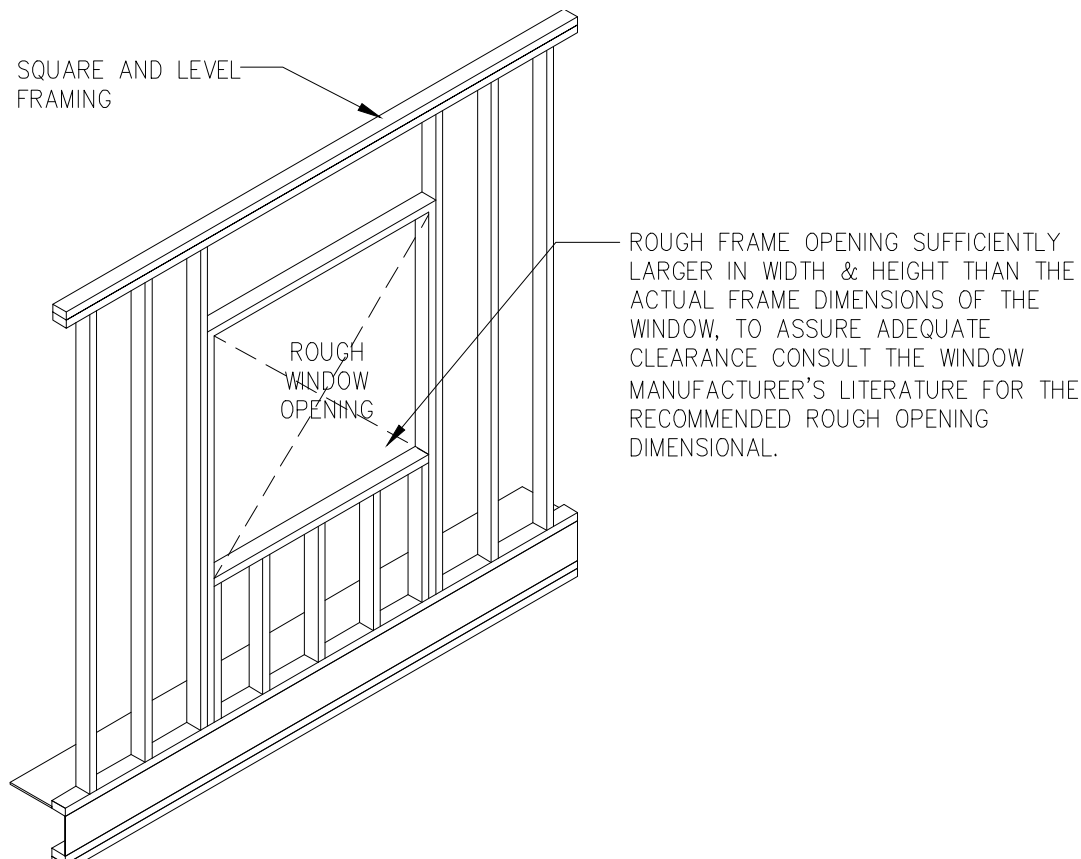
**PRIM. WEATHER BARRIER** 23  
N.T.S.

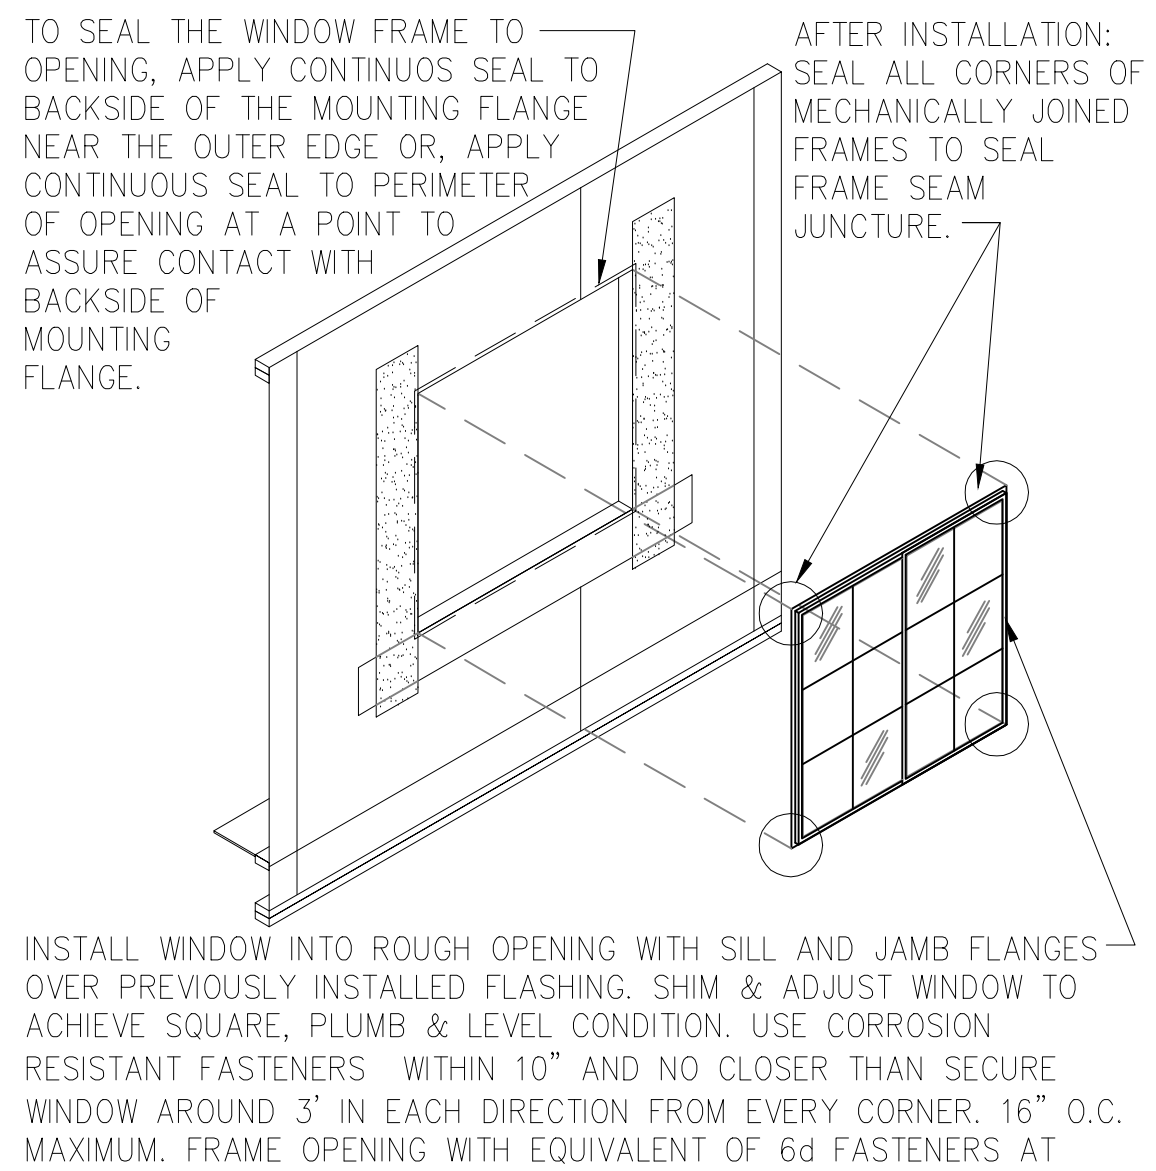

**HEAD FLASHING** 24  
N.T.S.

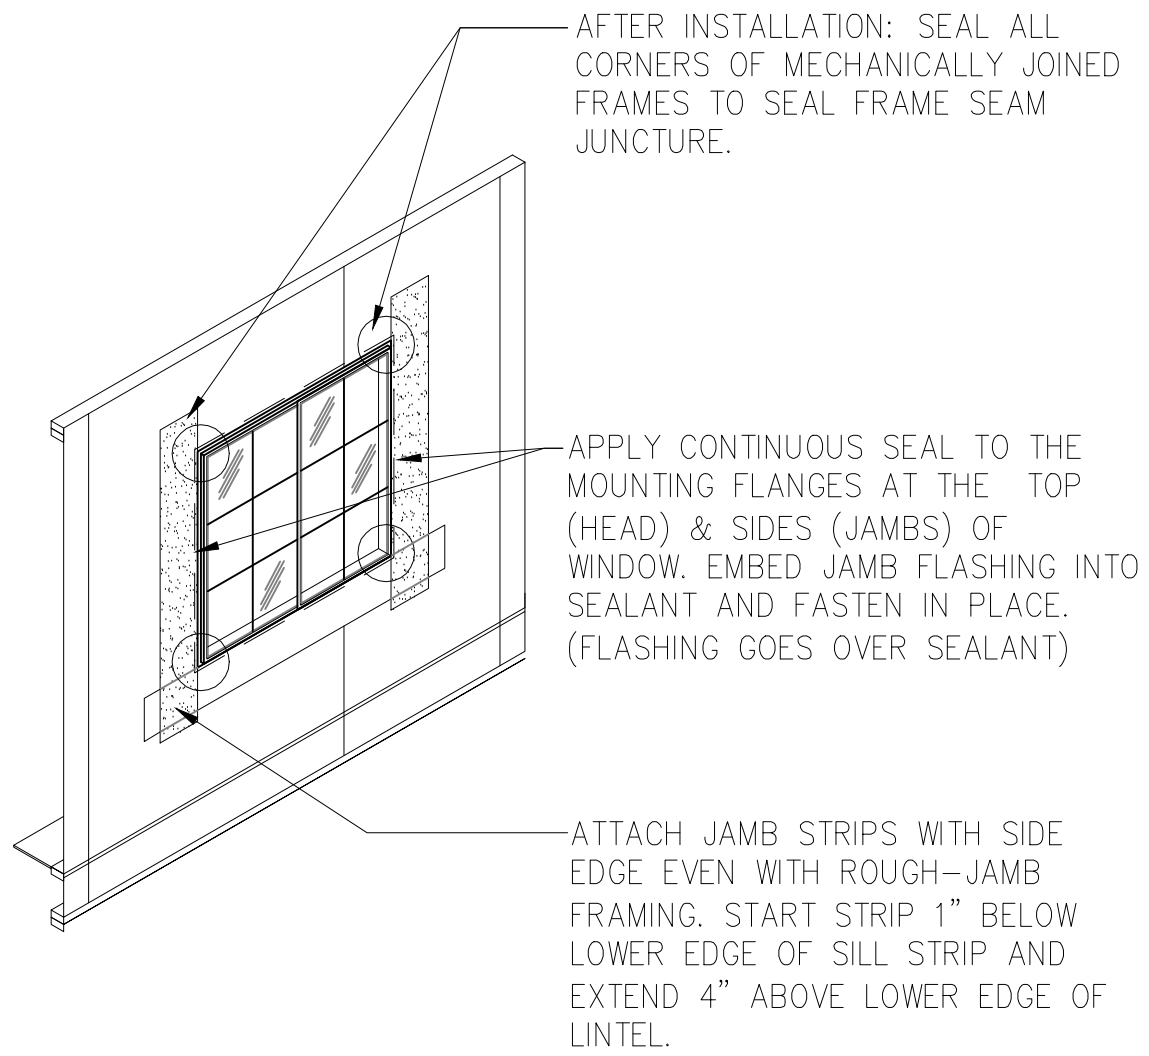

**WINDOW INSTALL.** 20  
N.T.S.

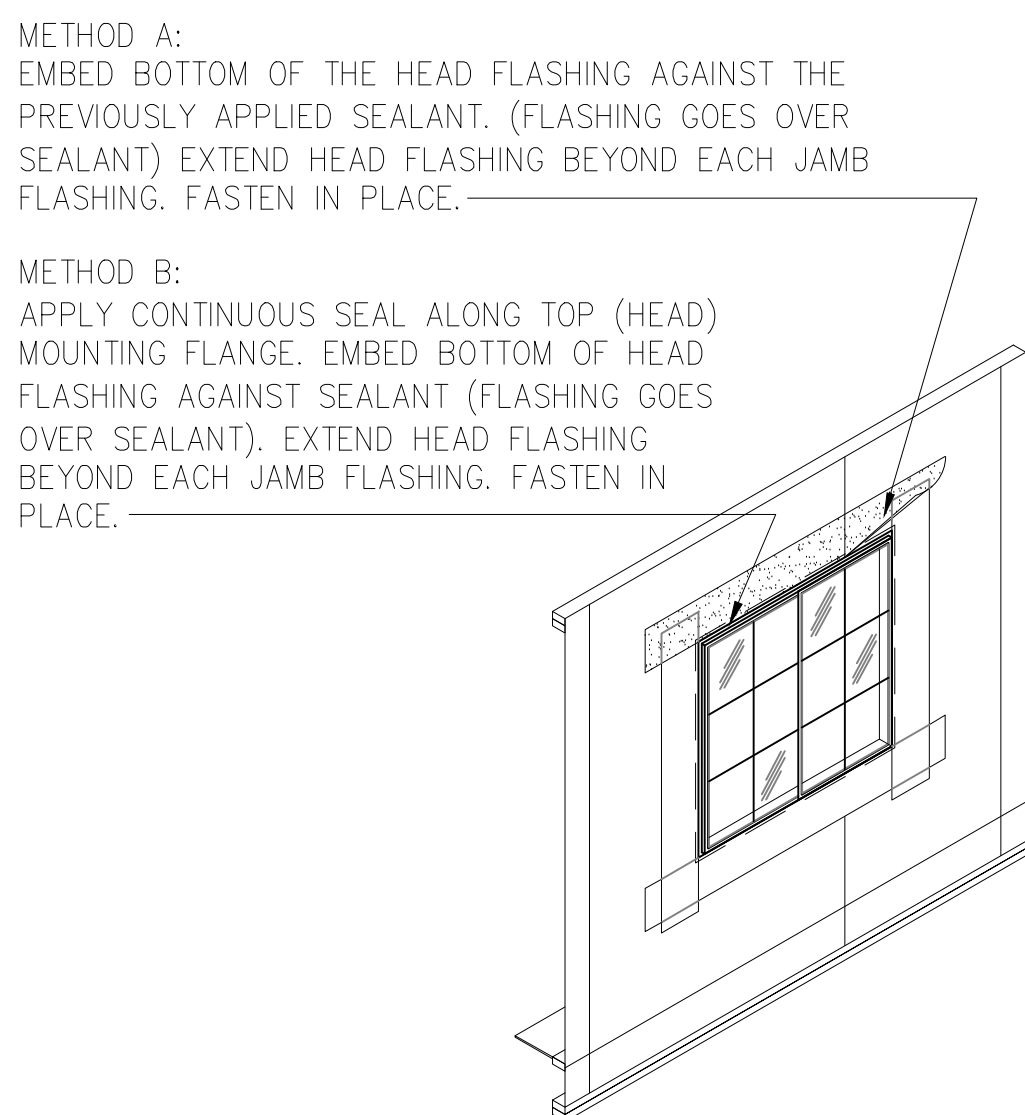


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N.T.S.

WINDOW FLASHING NOTES:


LINE-WIRE, WHEN USED AS BACKING TO SUPPORT BUILDING PAPER BENEATH WIRE LATH (NETTING) FOR PORTLAND CEMENT PLASTER (STUCCO) SHALL BE INSTALLED AS FOLLOWS:

1. WIRE GAUGE, SPACING AND ATTACHMENT SHALL BE IN ACCORDANCE WITH THE REQUIREMENTS OF THE SPECIFICATIONS
2. PERIPHERAL FLASHING AT ALL EDGES OF WALL OPENINGS MUST COVER THE WIRE BACKING.
3. NO ATTACHMENT DEVICES NOR THE WIRE BACKING SHALL COVER OR PENETRATE THE FLASHING MATERIAL.



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N.T.S.









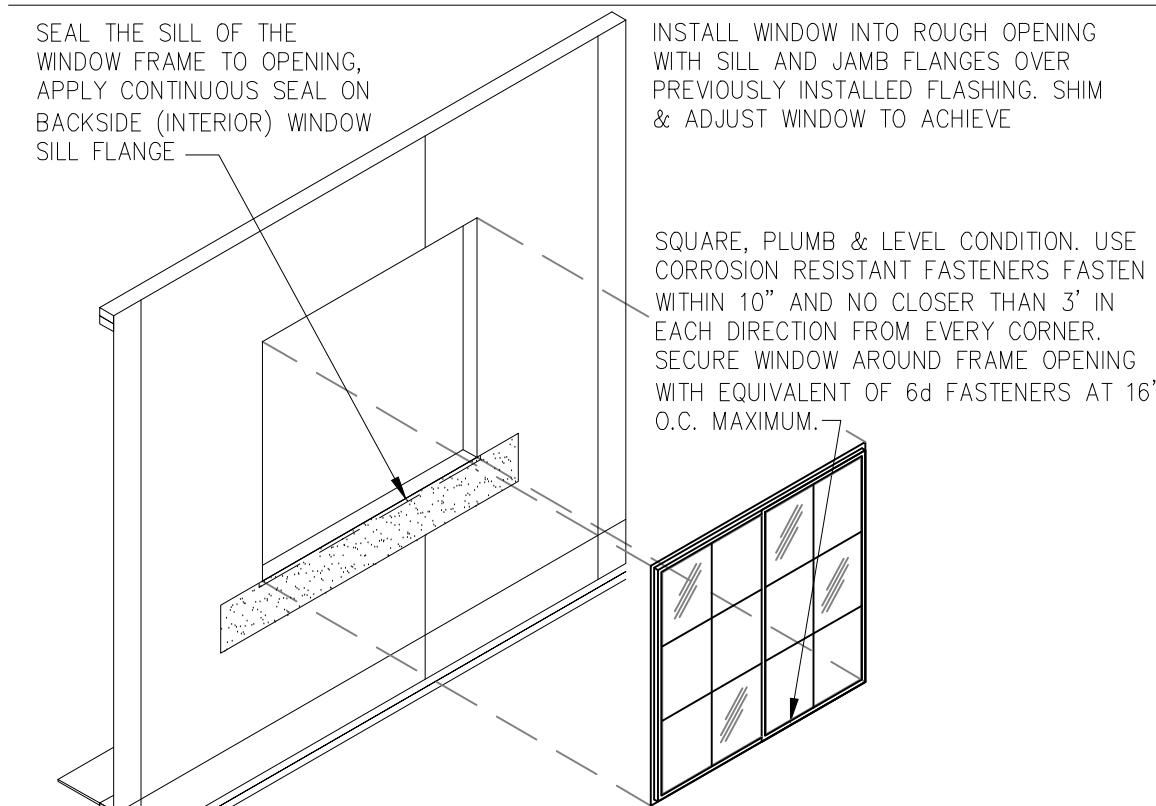


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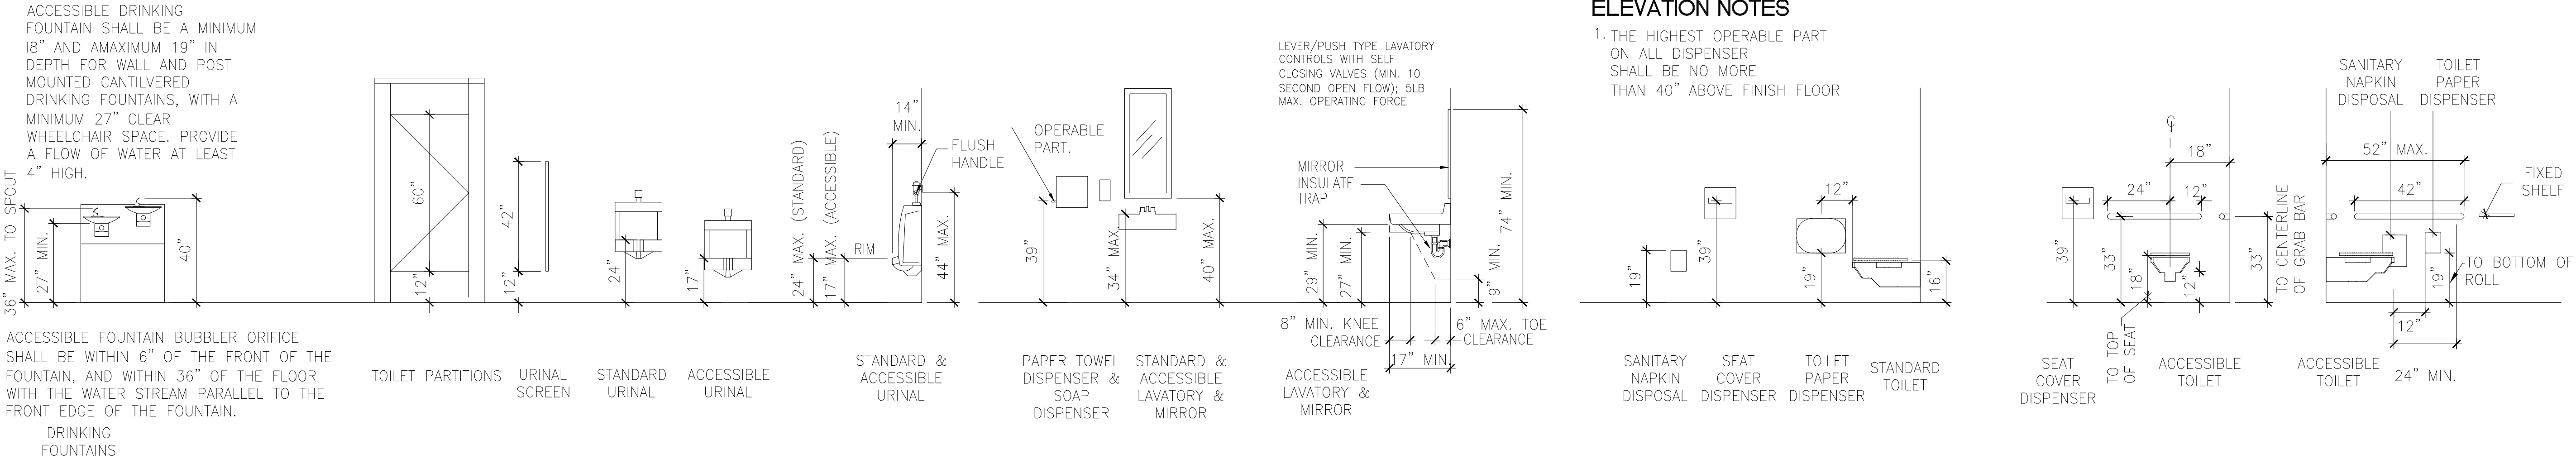


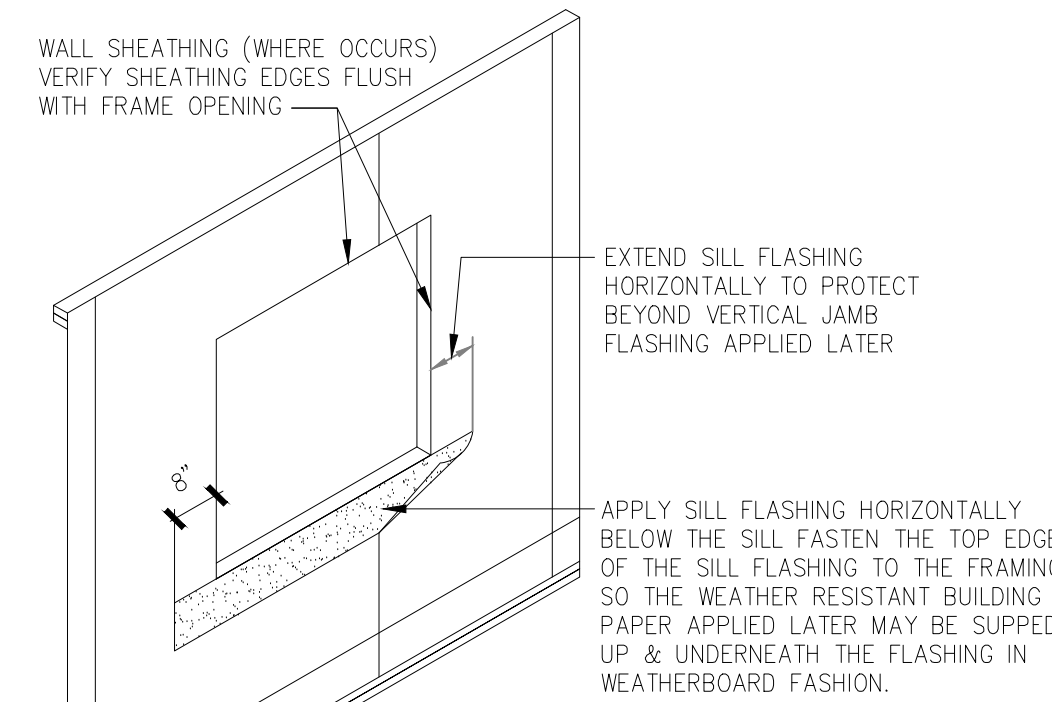**SILL FLASHING** 18  
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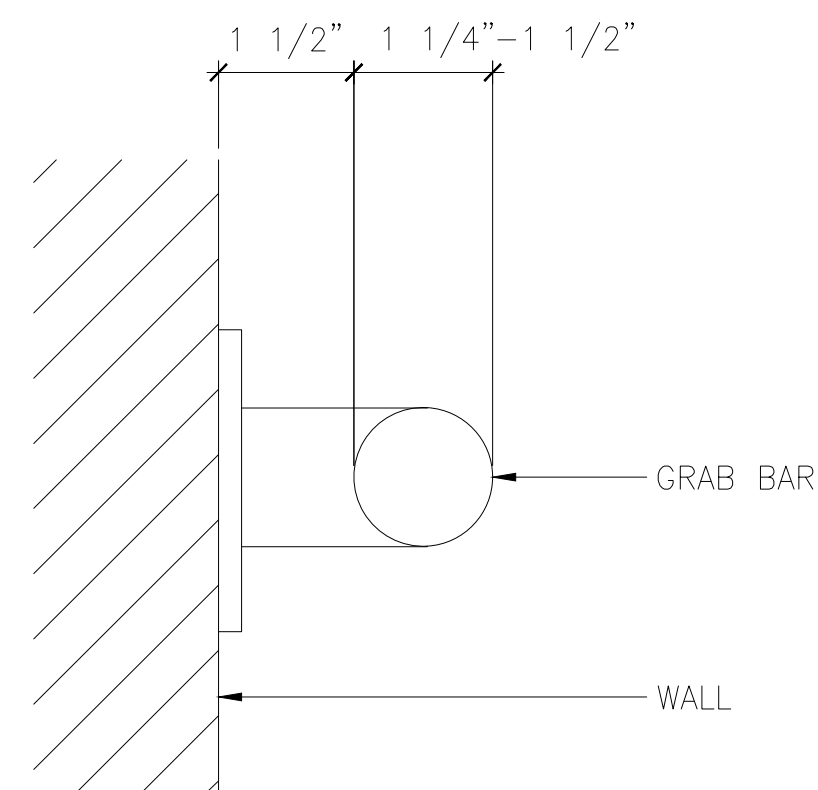
REVISIONS		BY
9/26/2011 - PLAN CHECK		G.O.
		
		
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Job No.:	2011-09	
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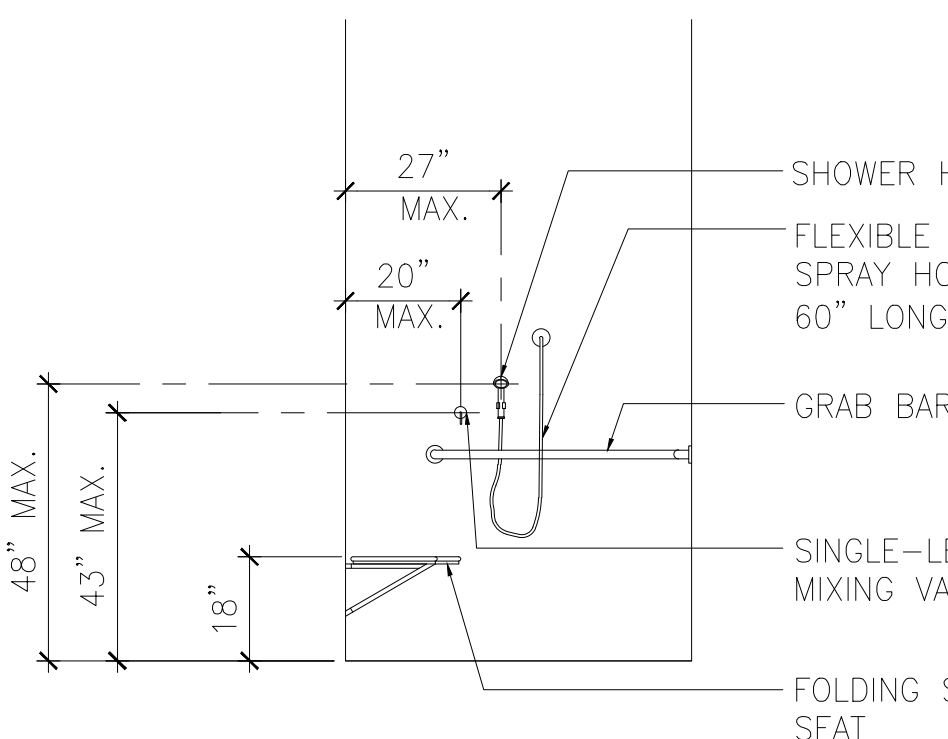
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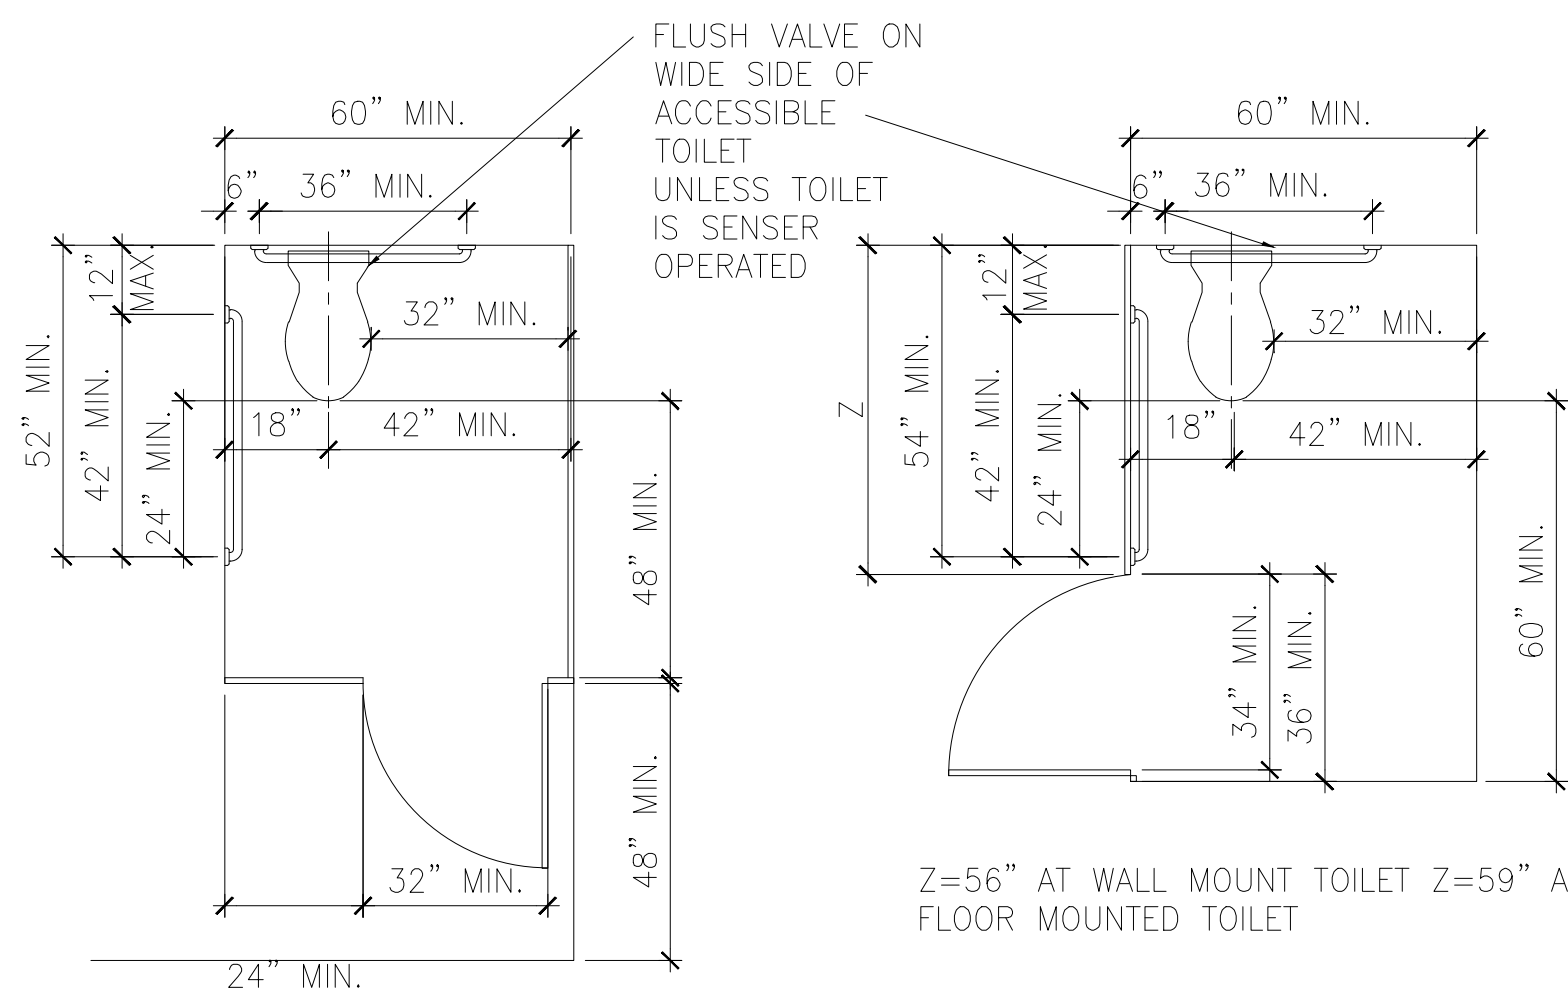
## 1 TYPICAL MOUNTING HEIGHTS @ RESTROOMS & PLUMBING FIXT.

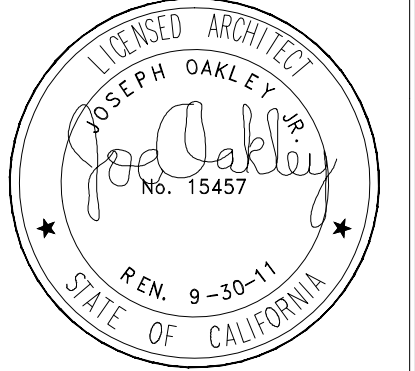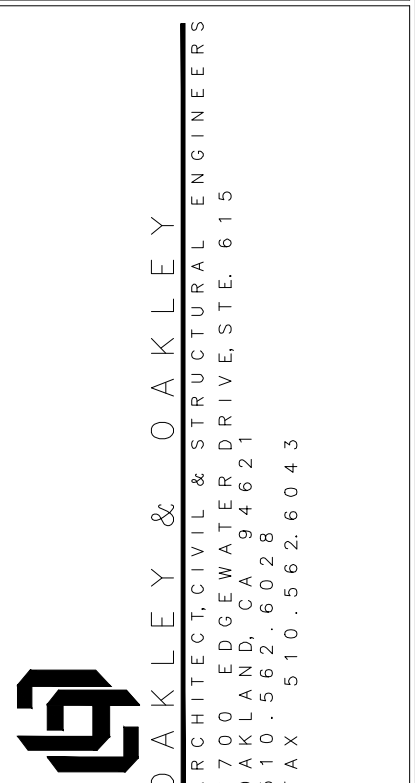


2 GRAB BAR  
DETAIL

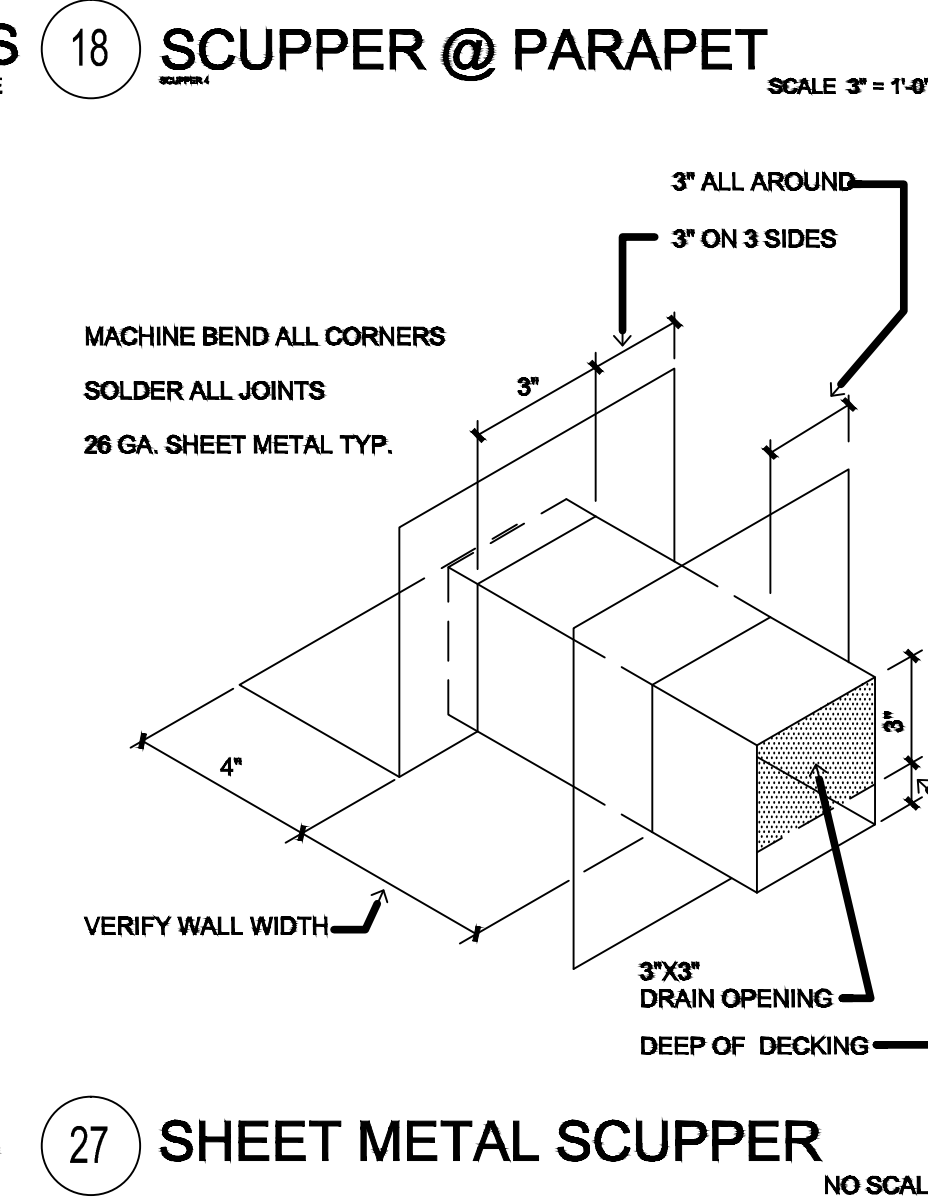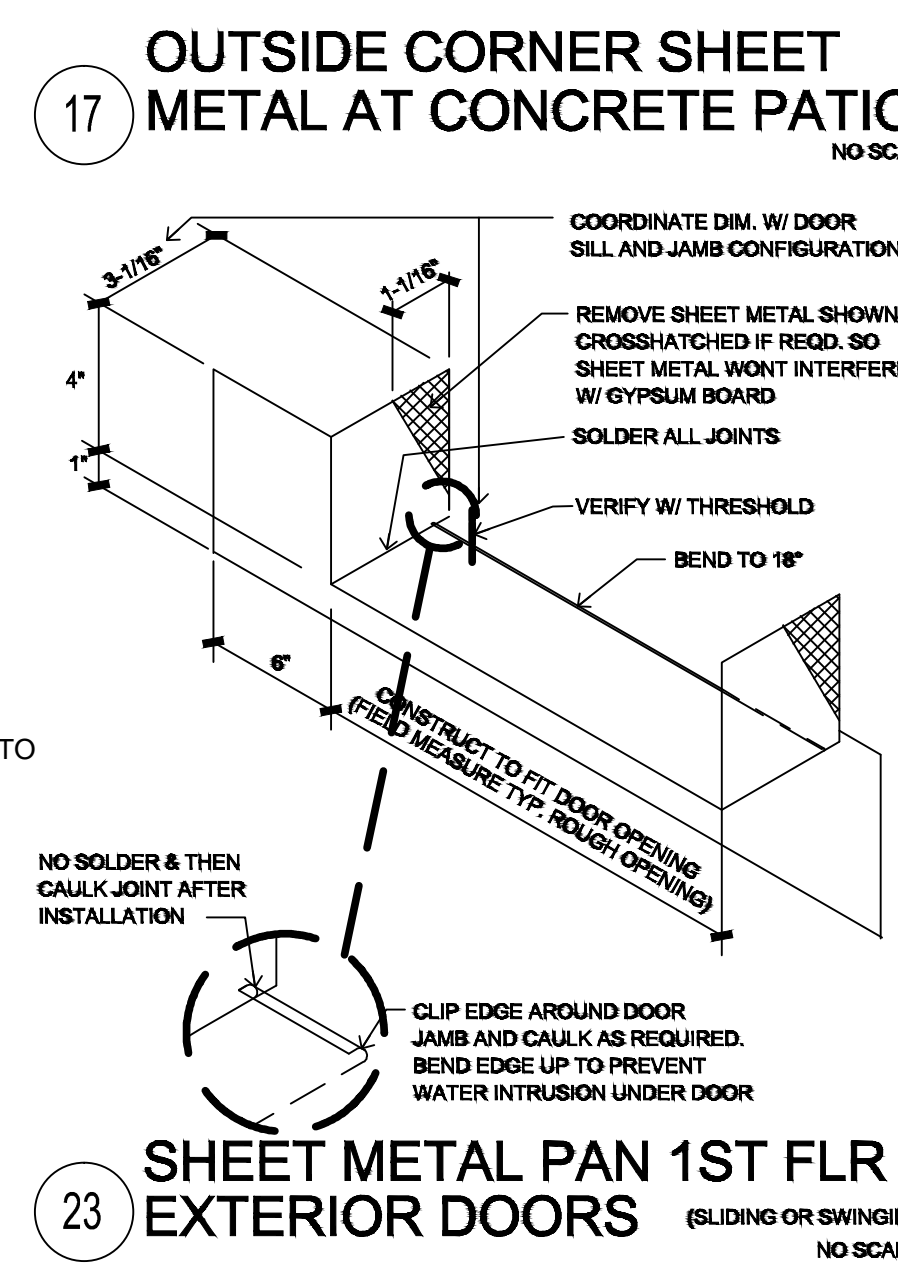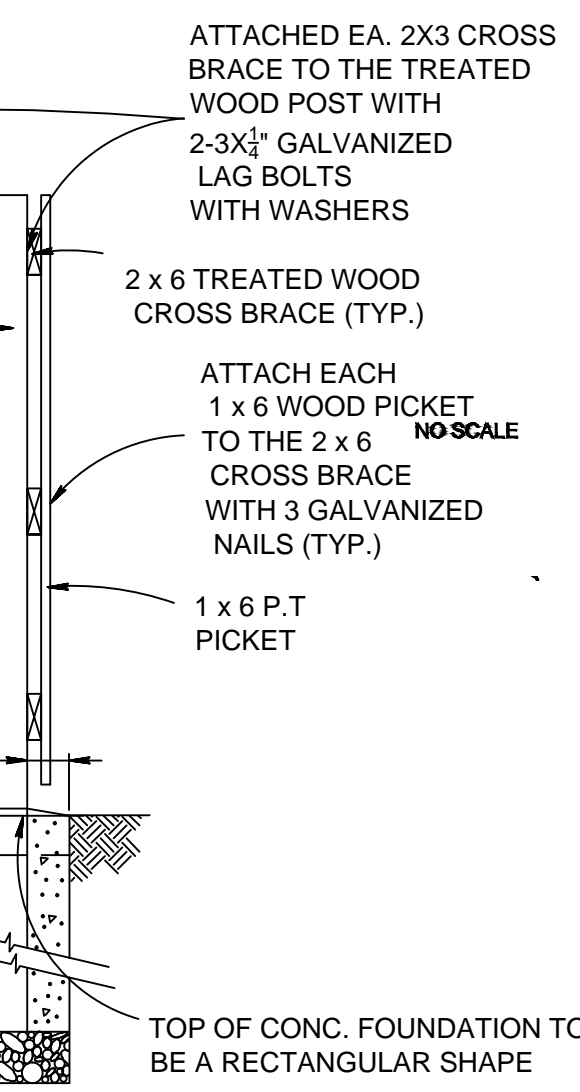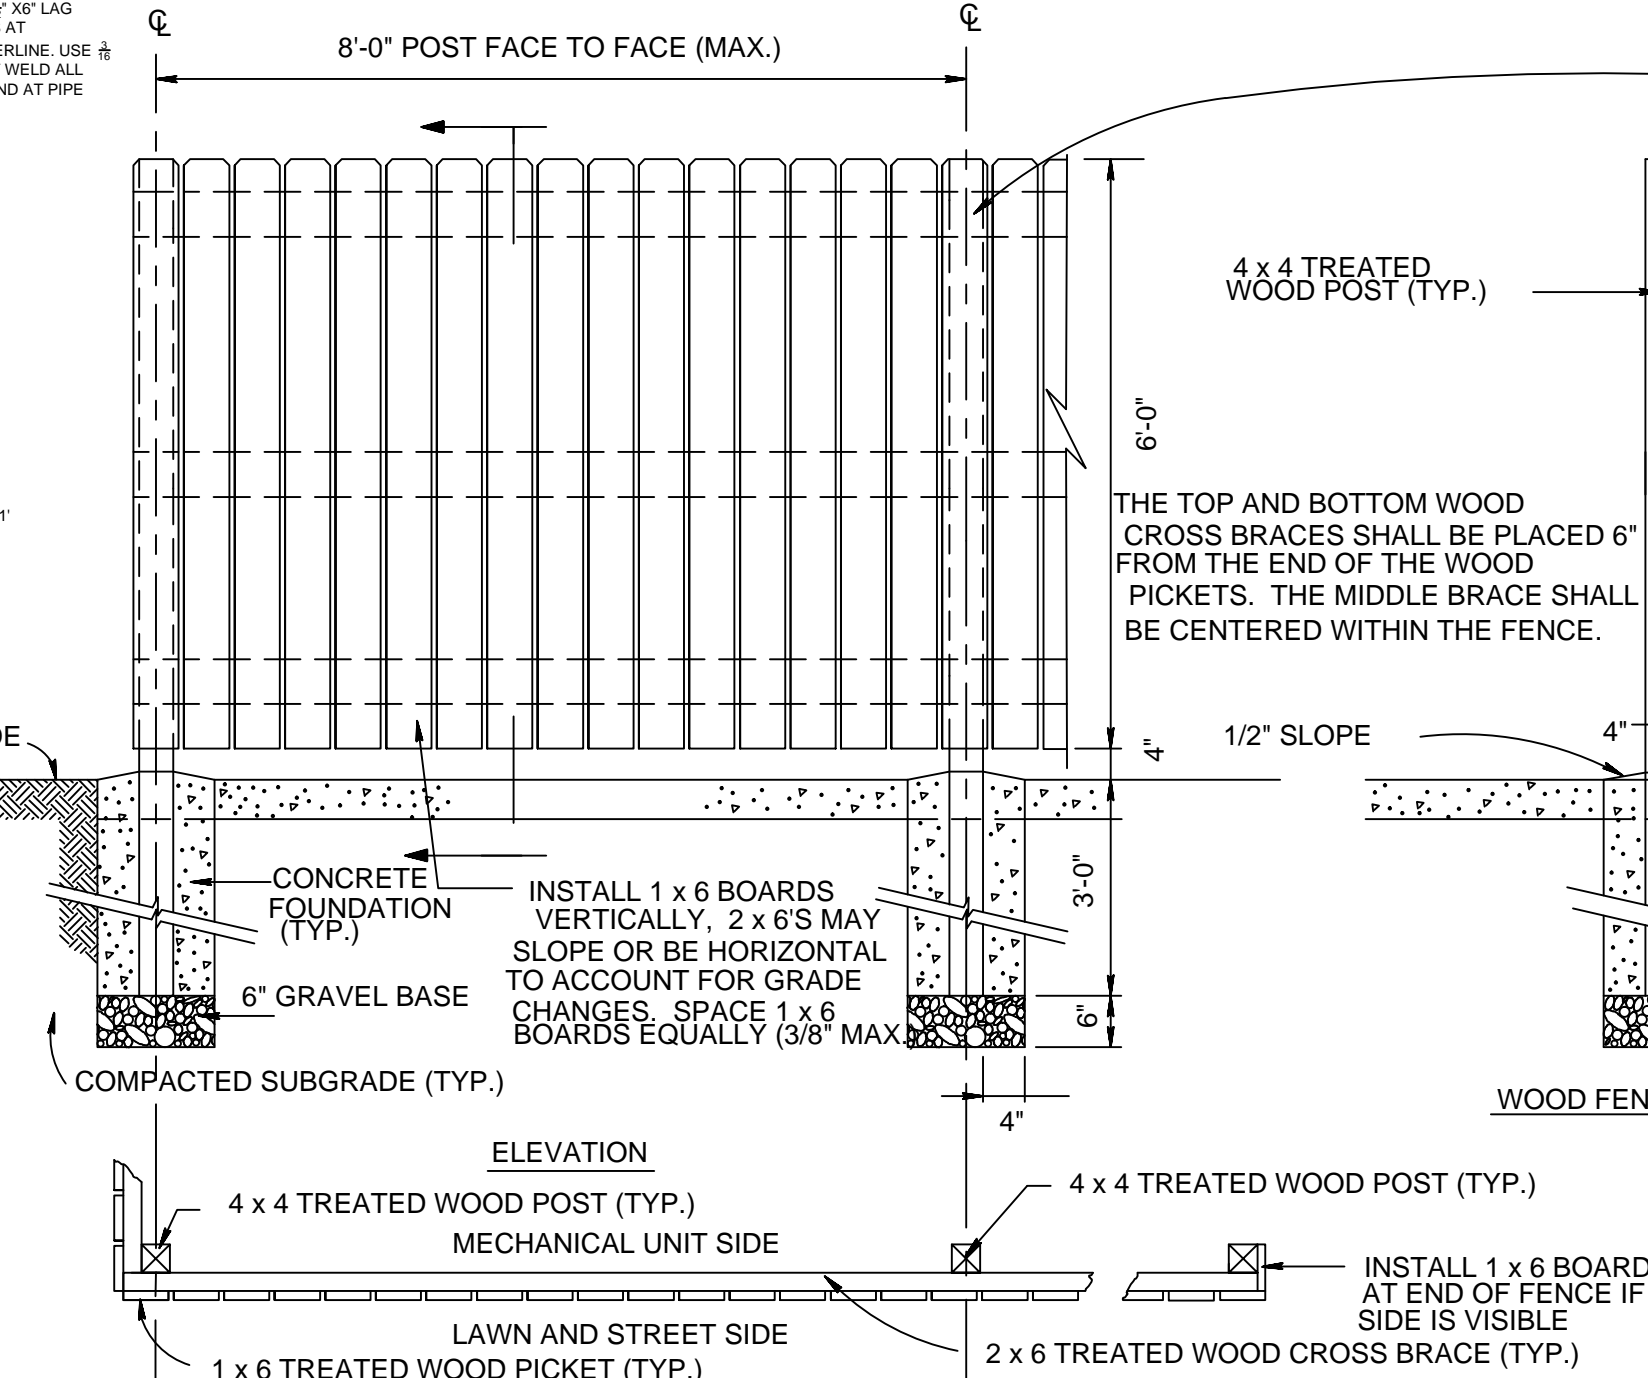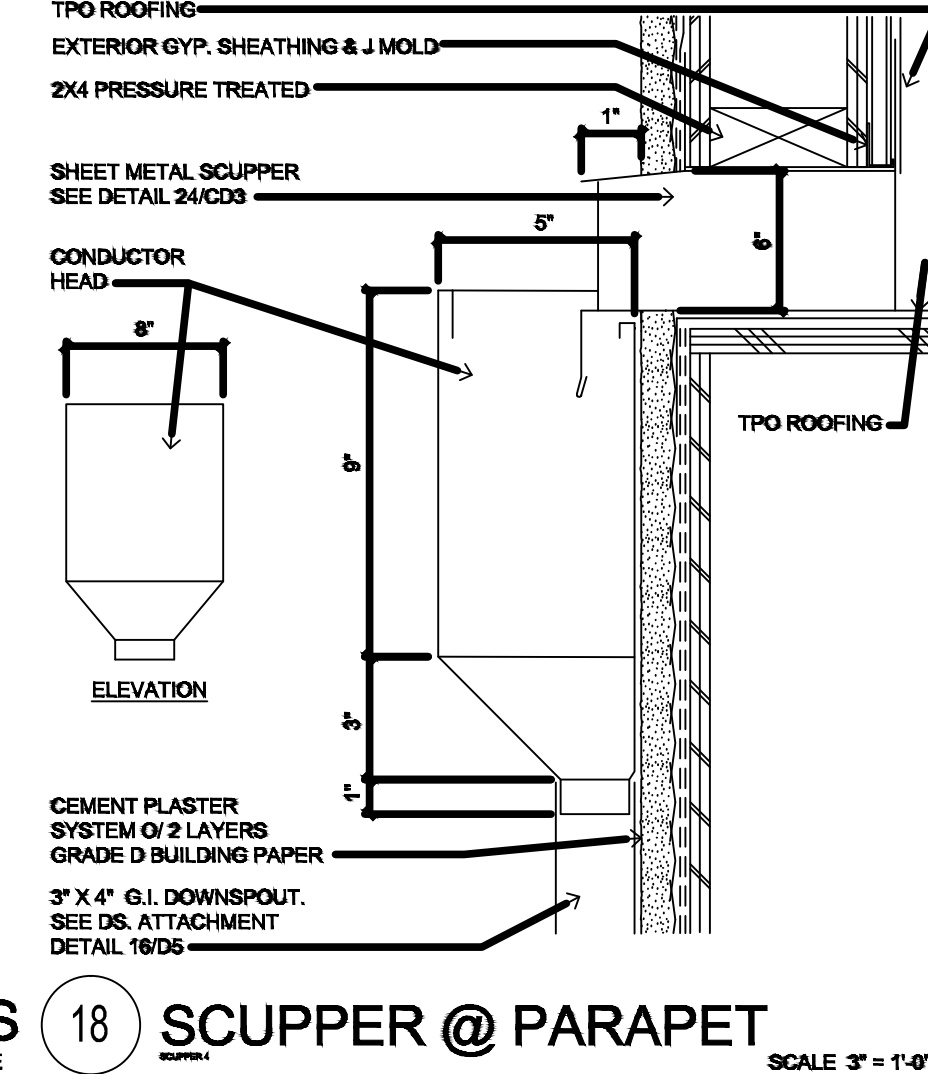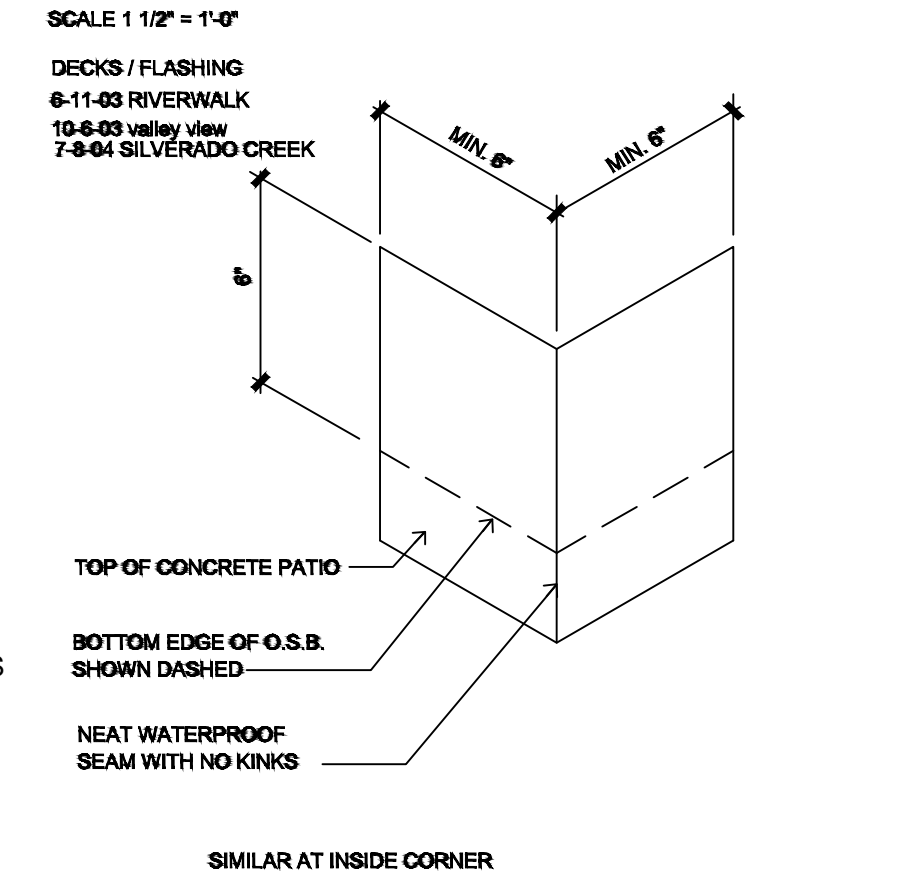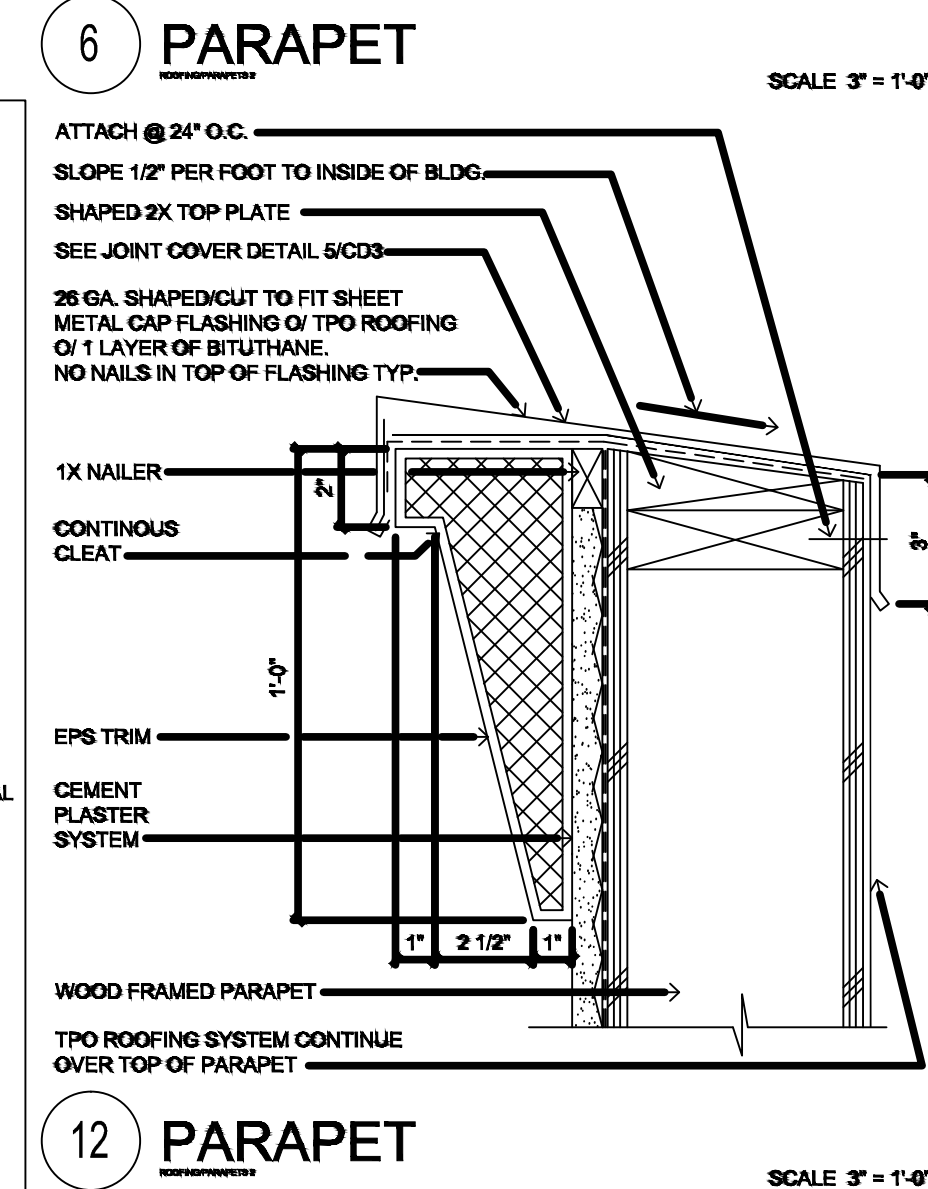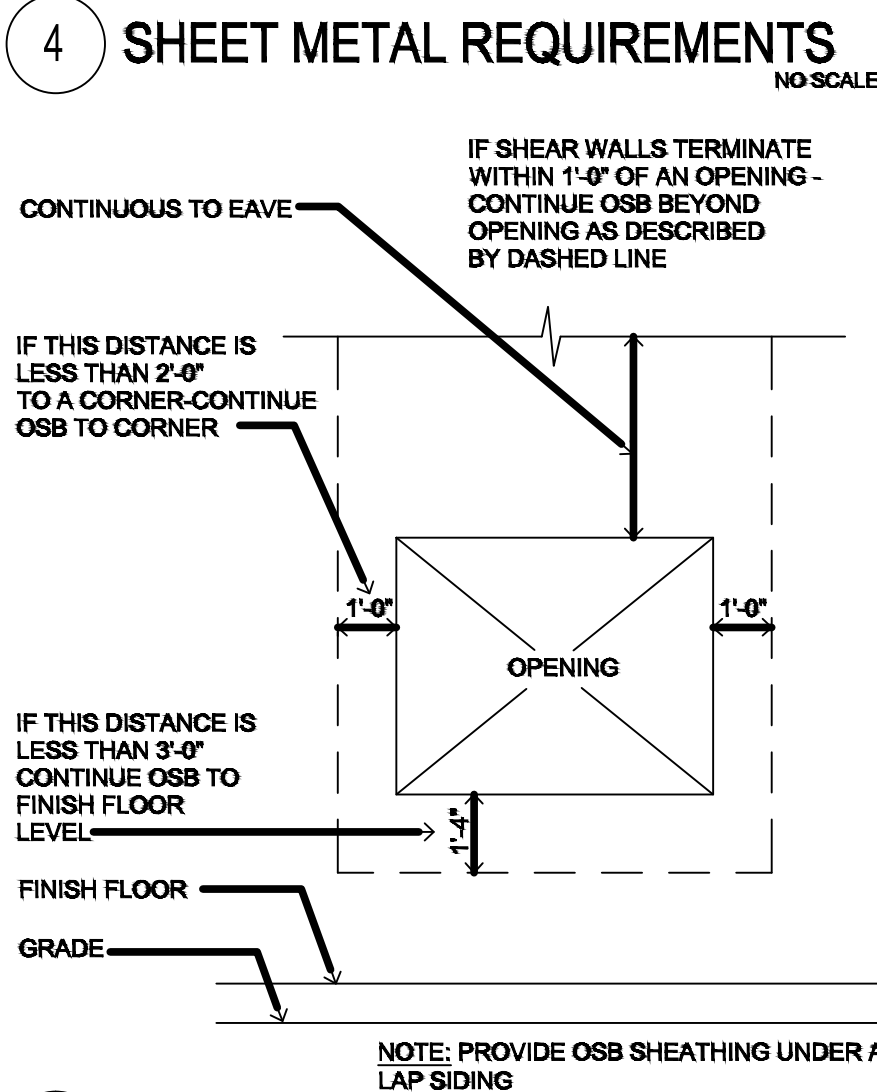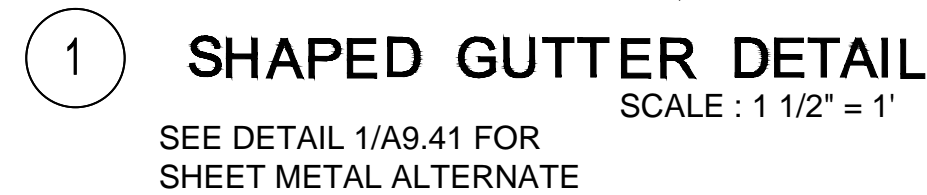


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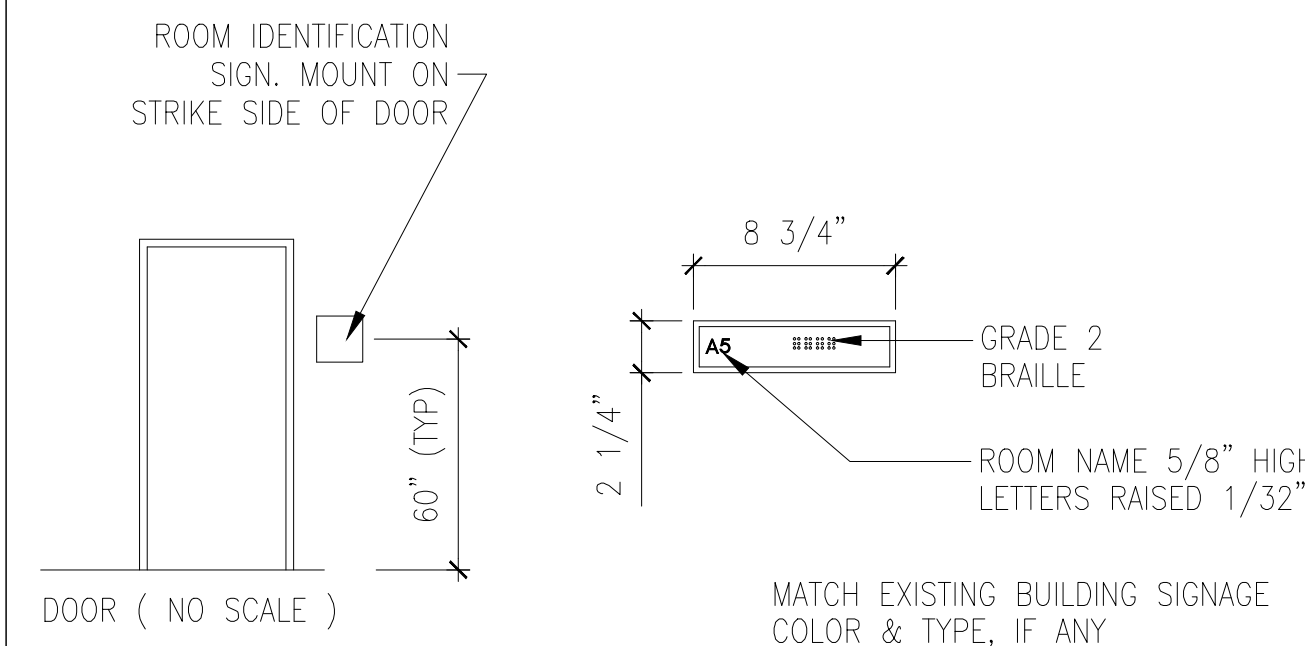
## 6 CLEARANCES @ ACCESSIBLE TOILET STALL




2 CLEARANCES @ ACCESSIBLE  
SINGLE ACCOMMODATION TOILET 3/8"=1'-0"

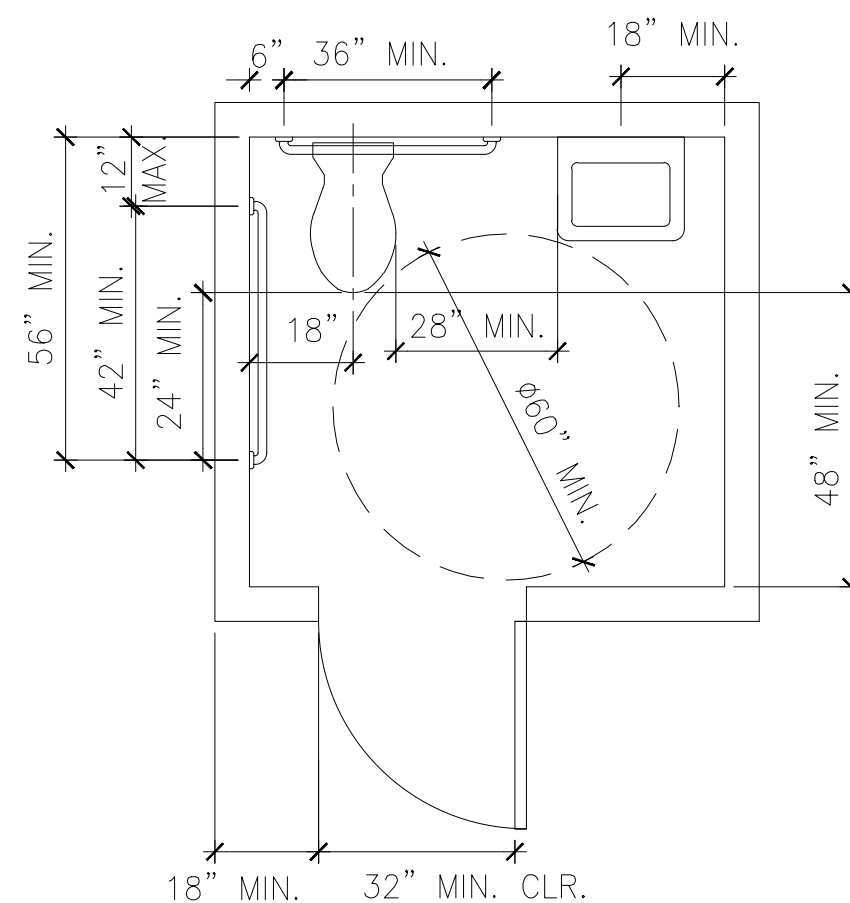


## 16 MOUNTING HEIGHTS FOR ELECTRICAL ITEMS 3/4"=1'-0"

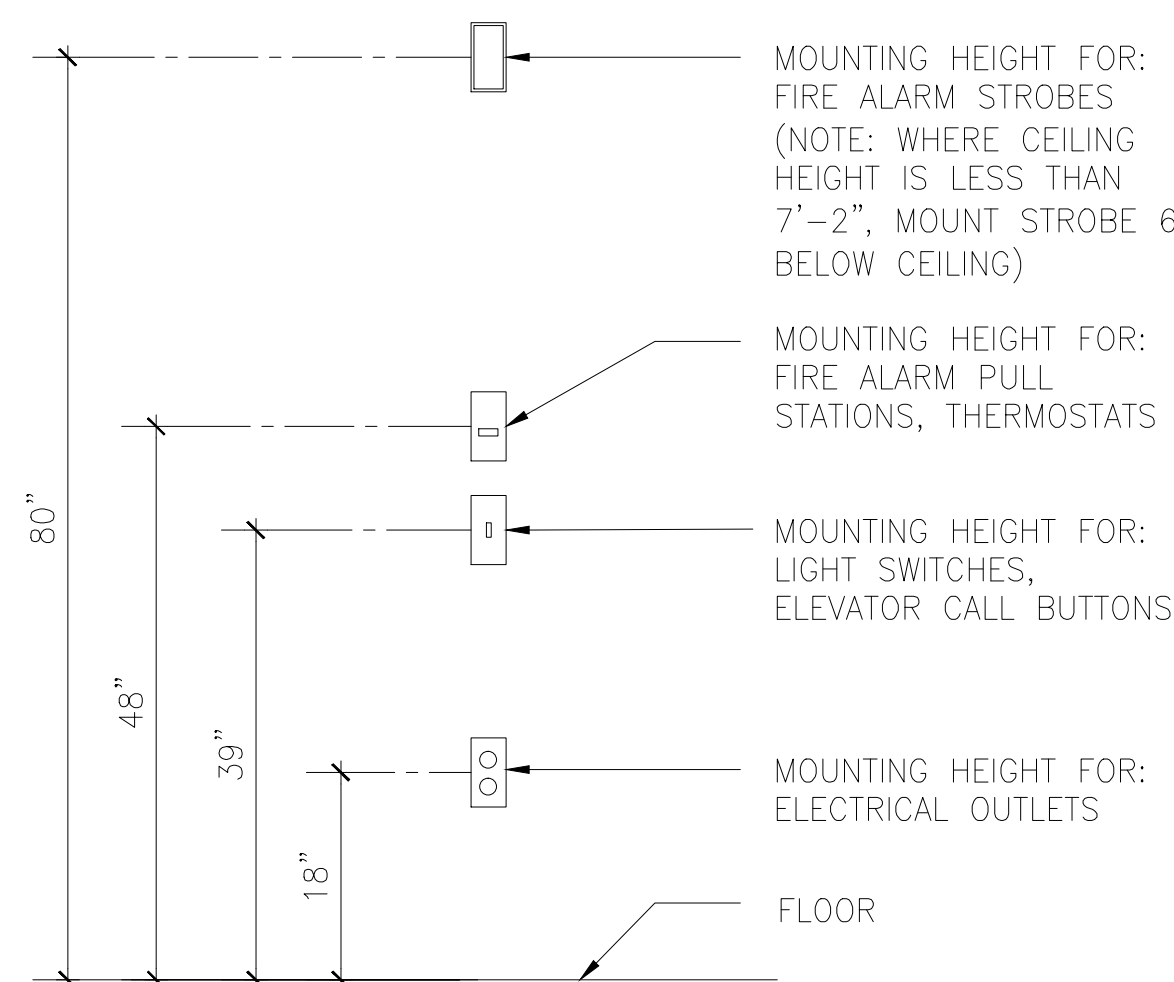

11 TYPICAL ROOM SIGNAGE

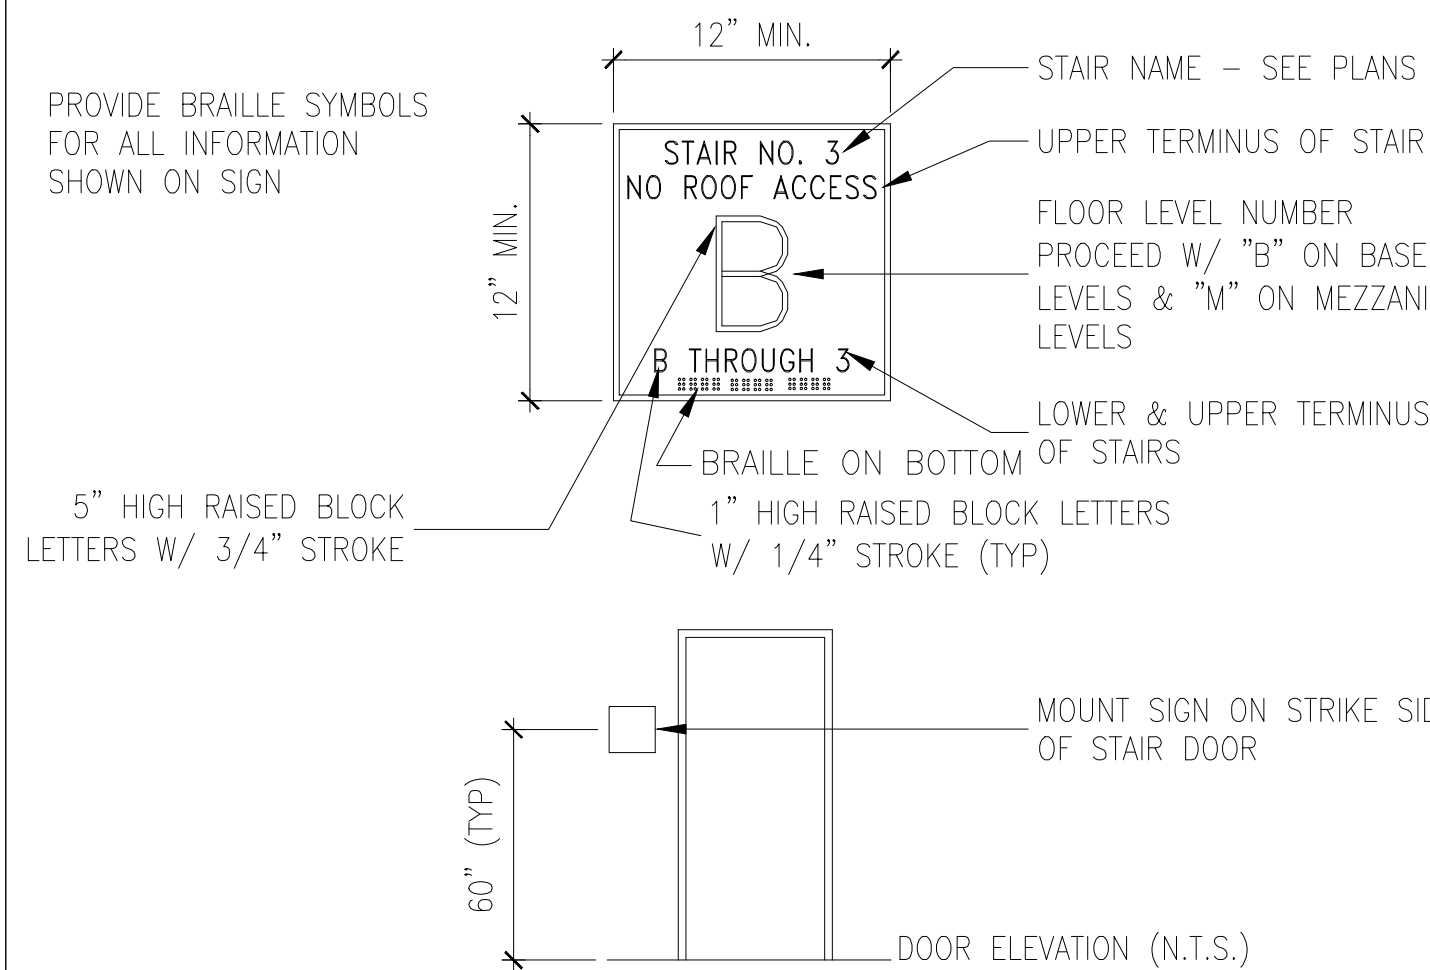


7 STAIR SIGNAGE 1 1/2" = 1'-0" (U.O.N.)

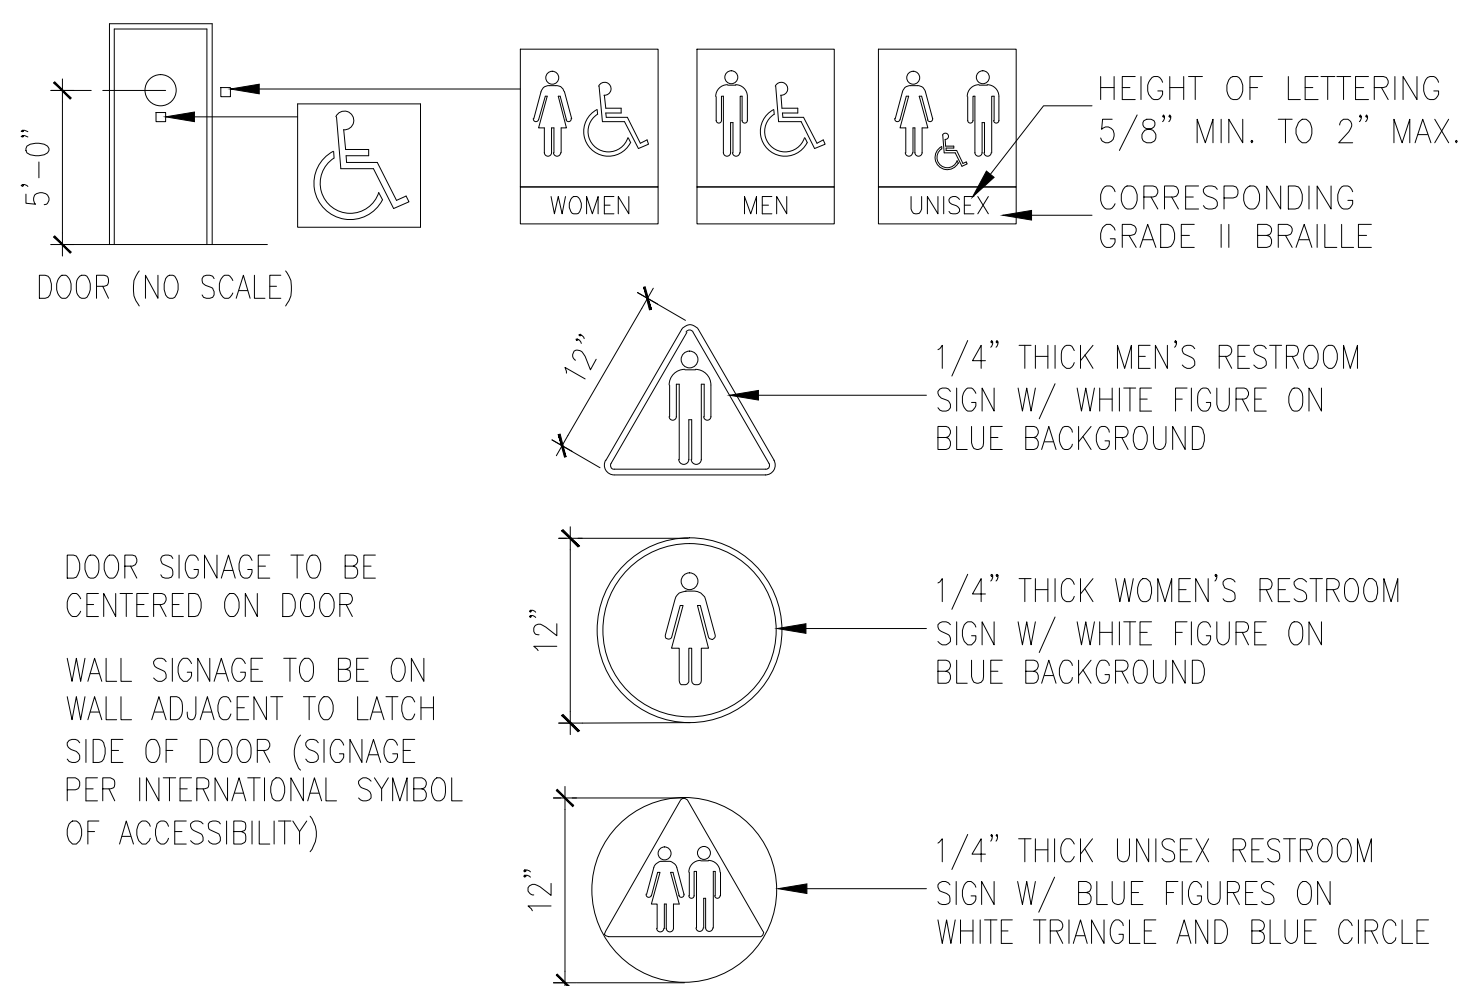

3 RESTROOM SIGNAGE 1 1/2" = 1'-0" (U.O.N.)

REVISIONS	BY
9/26/2011 - PLAN CHECK	G.O.

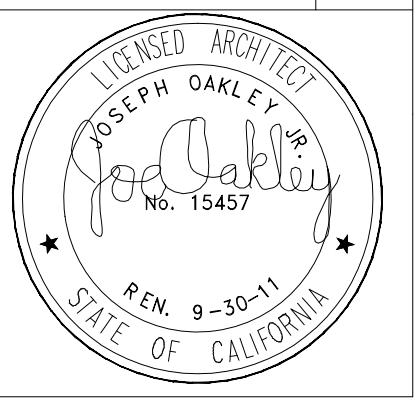

**OKLEY & OKLEY**  
ARCHITECTS, CIVIL & STRUCTURAL ENGINEERS  
700 CALDWELL ROAD, SUITE 400  
OKLAHOMA CITY, OKLA. 73104  
510.562.8028  
FAX 510.562.6043


PROJECT TITLE: COMMUNITY CENTER  
HARBOR PARK APARTMENTS  
369 PORTER STREET, VALLEJO, CA 94560

DRAWING TITLE: ADA REQUIREMENTS

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## A9.5


Jun 27, 2014 - 8:14pm \\SERVER\Server Drive D\Year 2011 Jobs\2011-09-3 - Community Bldg\REVISED DRAWINGS FOR NEGOTIATED CONTRACT WITH WE LYDINS\STRUCTURAL\CURRENT 6-01-2013 - Foundation Plan\_082012.dwg

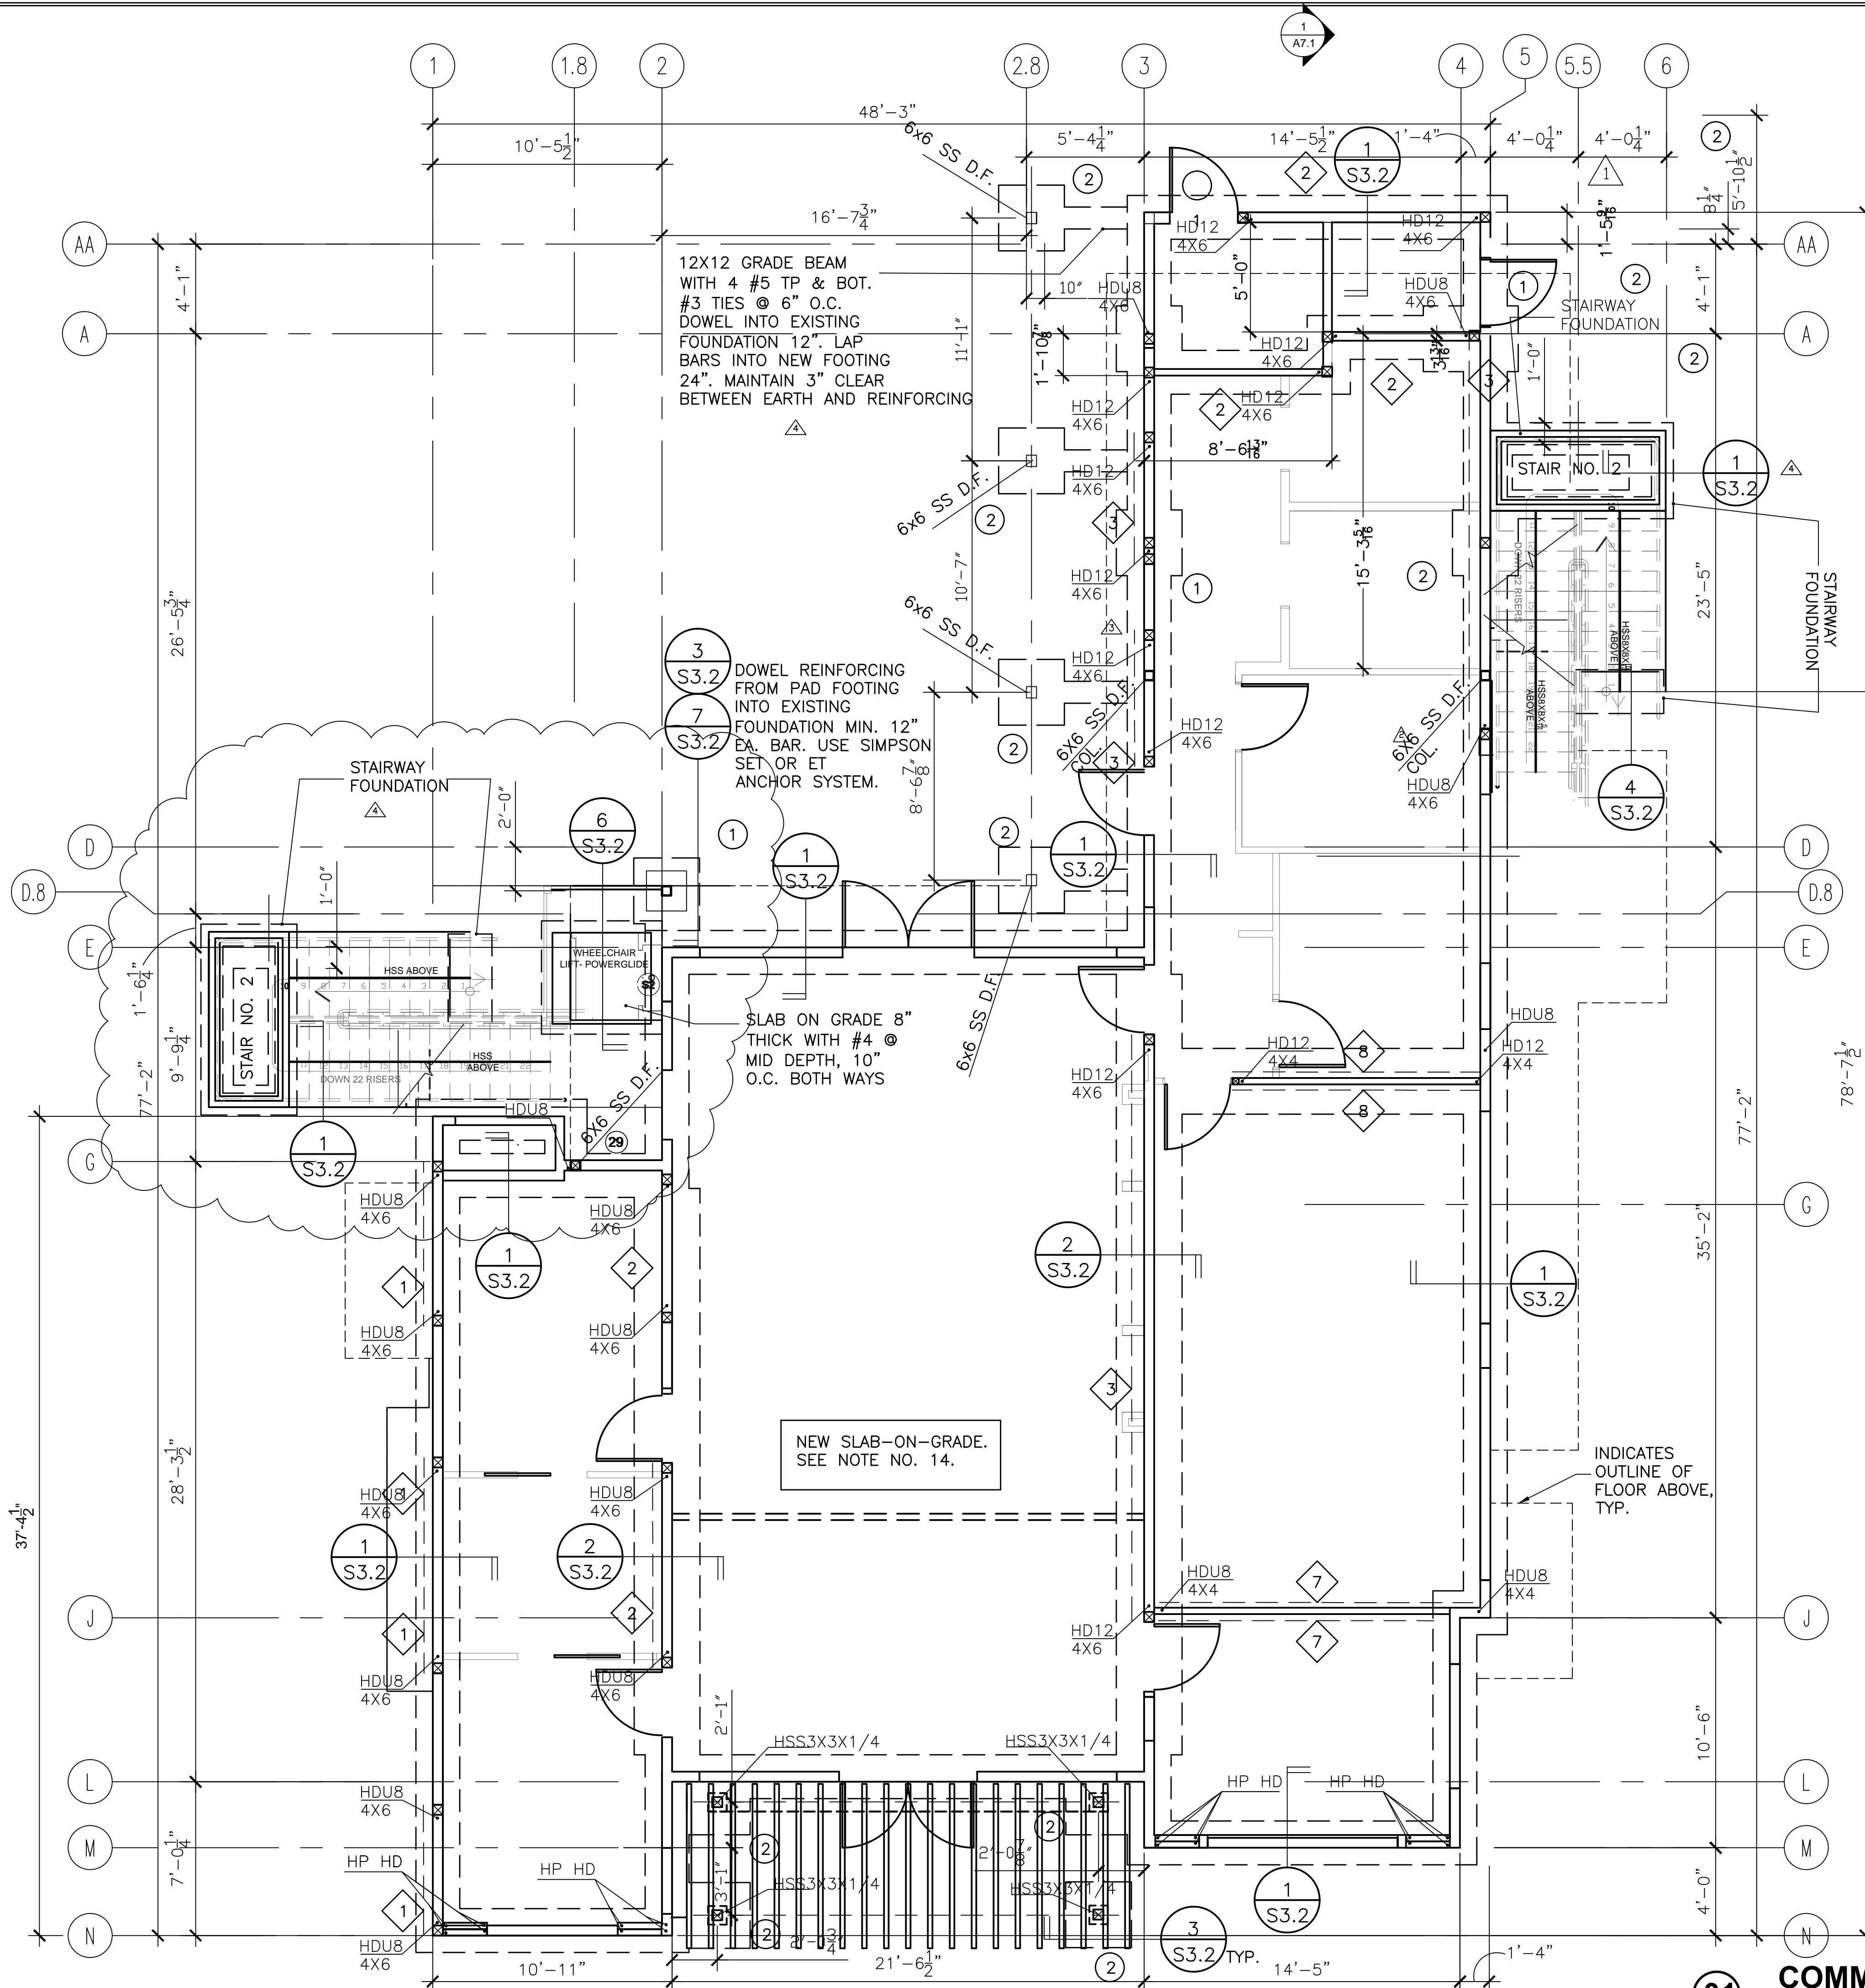

### FOUNDATION NOTES


- SEE GENERAL NOTES ON SHEET S0.1..
- FOUNDATION PLAN IS TAKEN ABOVE SLAB ON GRADE.
- SEE TYPICAL CONCRETE AND WOOD FRAMED STUD WALL DETAILS ON SHEET S3.1, S6.1 AND S6.2.
- SEE ARCHITECTURAL DWGS. FOR TOP OF SLAB ELEVATIONS.
- EXCAVATIONS SHALL BE MADE AS NEAR AS POSSIBLE TO THE NEAT LINES REQUIRED BY THE SIZE AND SHAPE OF THE STRUCTURE. NO MATERIAL IS TO BE EXCAVATED UNNECESSARILY.
- ALL FOUNDATION EXCAVATIONS MUST BE REVIEWED AND APPROVED BY THE SOILS ENGINEER PRIOR TO PLACEMENT OF CONCRETE.
- VERIFY LOCATION OF UNDERGROUND UTILITIES BEFORE EXCAVATION. NOTIFY ARCHITECT PRIOR TO EXCAVATION IN THE EVENT SUCH UTILITIES ARE ENCOUNTERED.
- SLAB CONSTRUCTION AND CONTROL JOINT LOCATIONS SHALL BE APPROVED BY THE ARCHITECT PRIOR TO PLACING ANY CONCRETE.
- NEW STRUCTURAL BEARING WOOD WALLS ARE SHOWN THUS: ON PLAN AND SHALL BE 2x6 STUDS @ 16" O.C. U.O.N. SEE ARCHITECTURAL DRAWINGS FOR NON-LOAD BEARING PARTITIONS. USE 3X STUDS AT PANEL JOINTS AT ALL SHEAR WALLS
- SILL BOLTS AND/OR SHOT PINS ARE REQUIRED AT ALL STUD WALLS SHOWN ON STRUCTURAL PLANS. SEE DETAILS ON SHEETS S3.1.
- WHERE NOTED ON PLAN AS "HP HD" INDICATES HARDY PANEL HOLDOWN. PROVIDE HARDY PANEL GROUND FLOOR HOLDOWN SHEET S3.21 & PER THE MANUFACTURES STANDARD DETAILS 2B/S8, 29B,S9.
- SEE DETAIL 23/S3.1 FOR EQUIPMENT PAD DETAIL AND REINFORCEMENT. SEE ARCHITECTURAL DRAWINGS FOR PAD LOCATIONS
- (X) - DENOTES PAD FOOTING. SEE SCHEDULE ON SHEET S3.1.
- NEW SLAB-ON-GRADE SHALL BE 5" THICK w/ #4 BARS AT 12" O.C., EA WAY, o/ 2" OF SAND o/ A 12 MILL VAPOR BARRIER o/ A MIN. OF 4" OF FREE DRAINING GRAVEL
- FOR STAIR 1 AND STAIR 2 FRAMING PLANS AND ELEVATIONS, SEE SHEET S5.1.
- GROUND FLOOR HOLDOWN TIES ARE REQUIRED AT EACH END OF SHEAR WALL AND AT LOCATIONS NOTED THUS: . ALL HOLDOWNS TO BE ON 6x6 POST U.N.O. SEE DETAILS ON SHEET S3.1, AND S6.1 AND S6.2

1 A7.1

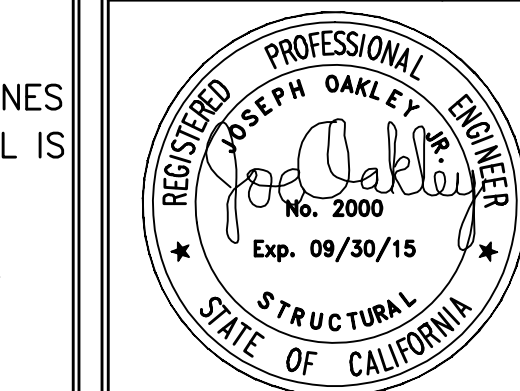

PROJECT TITLE:  
COMMUNITY CENTER  
HARBOR PARK APARTMENTS  
969 PORTER STREET, VALLEJO, CA 94560  
DRAWING TITLE:  
FOUNDATION PLAN





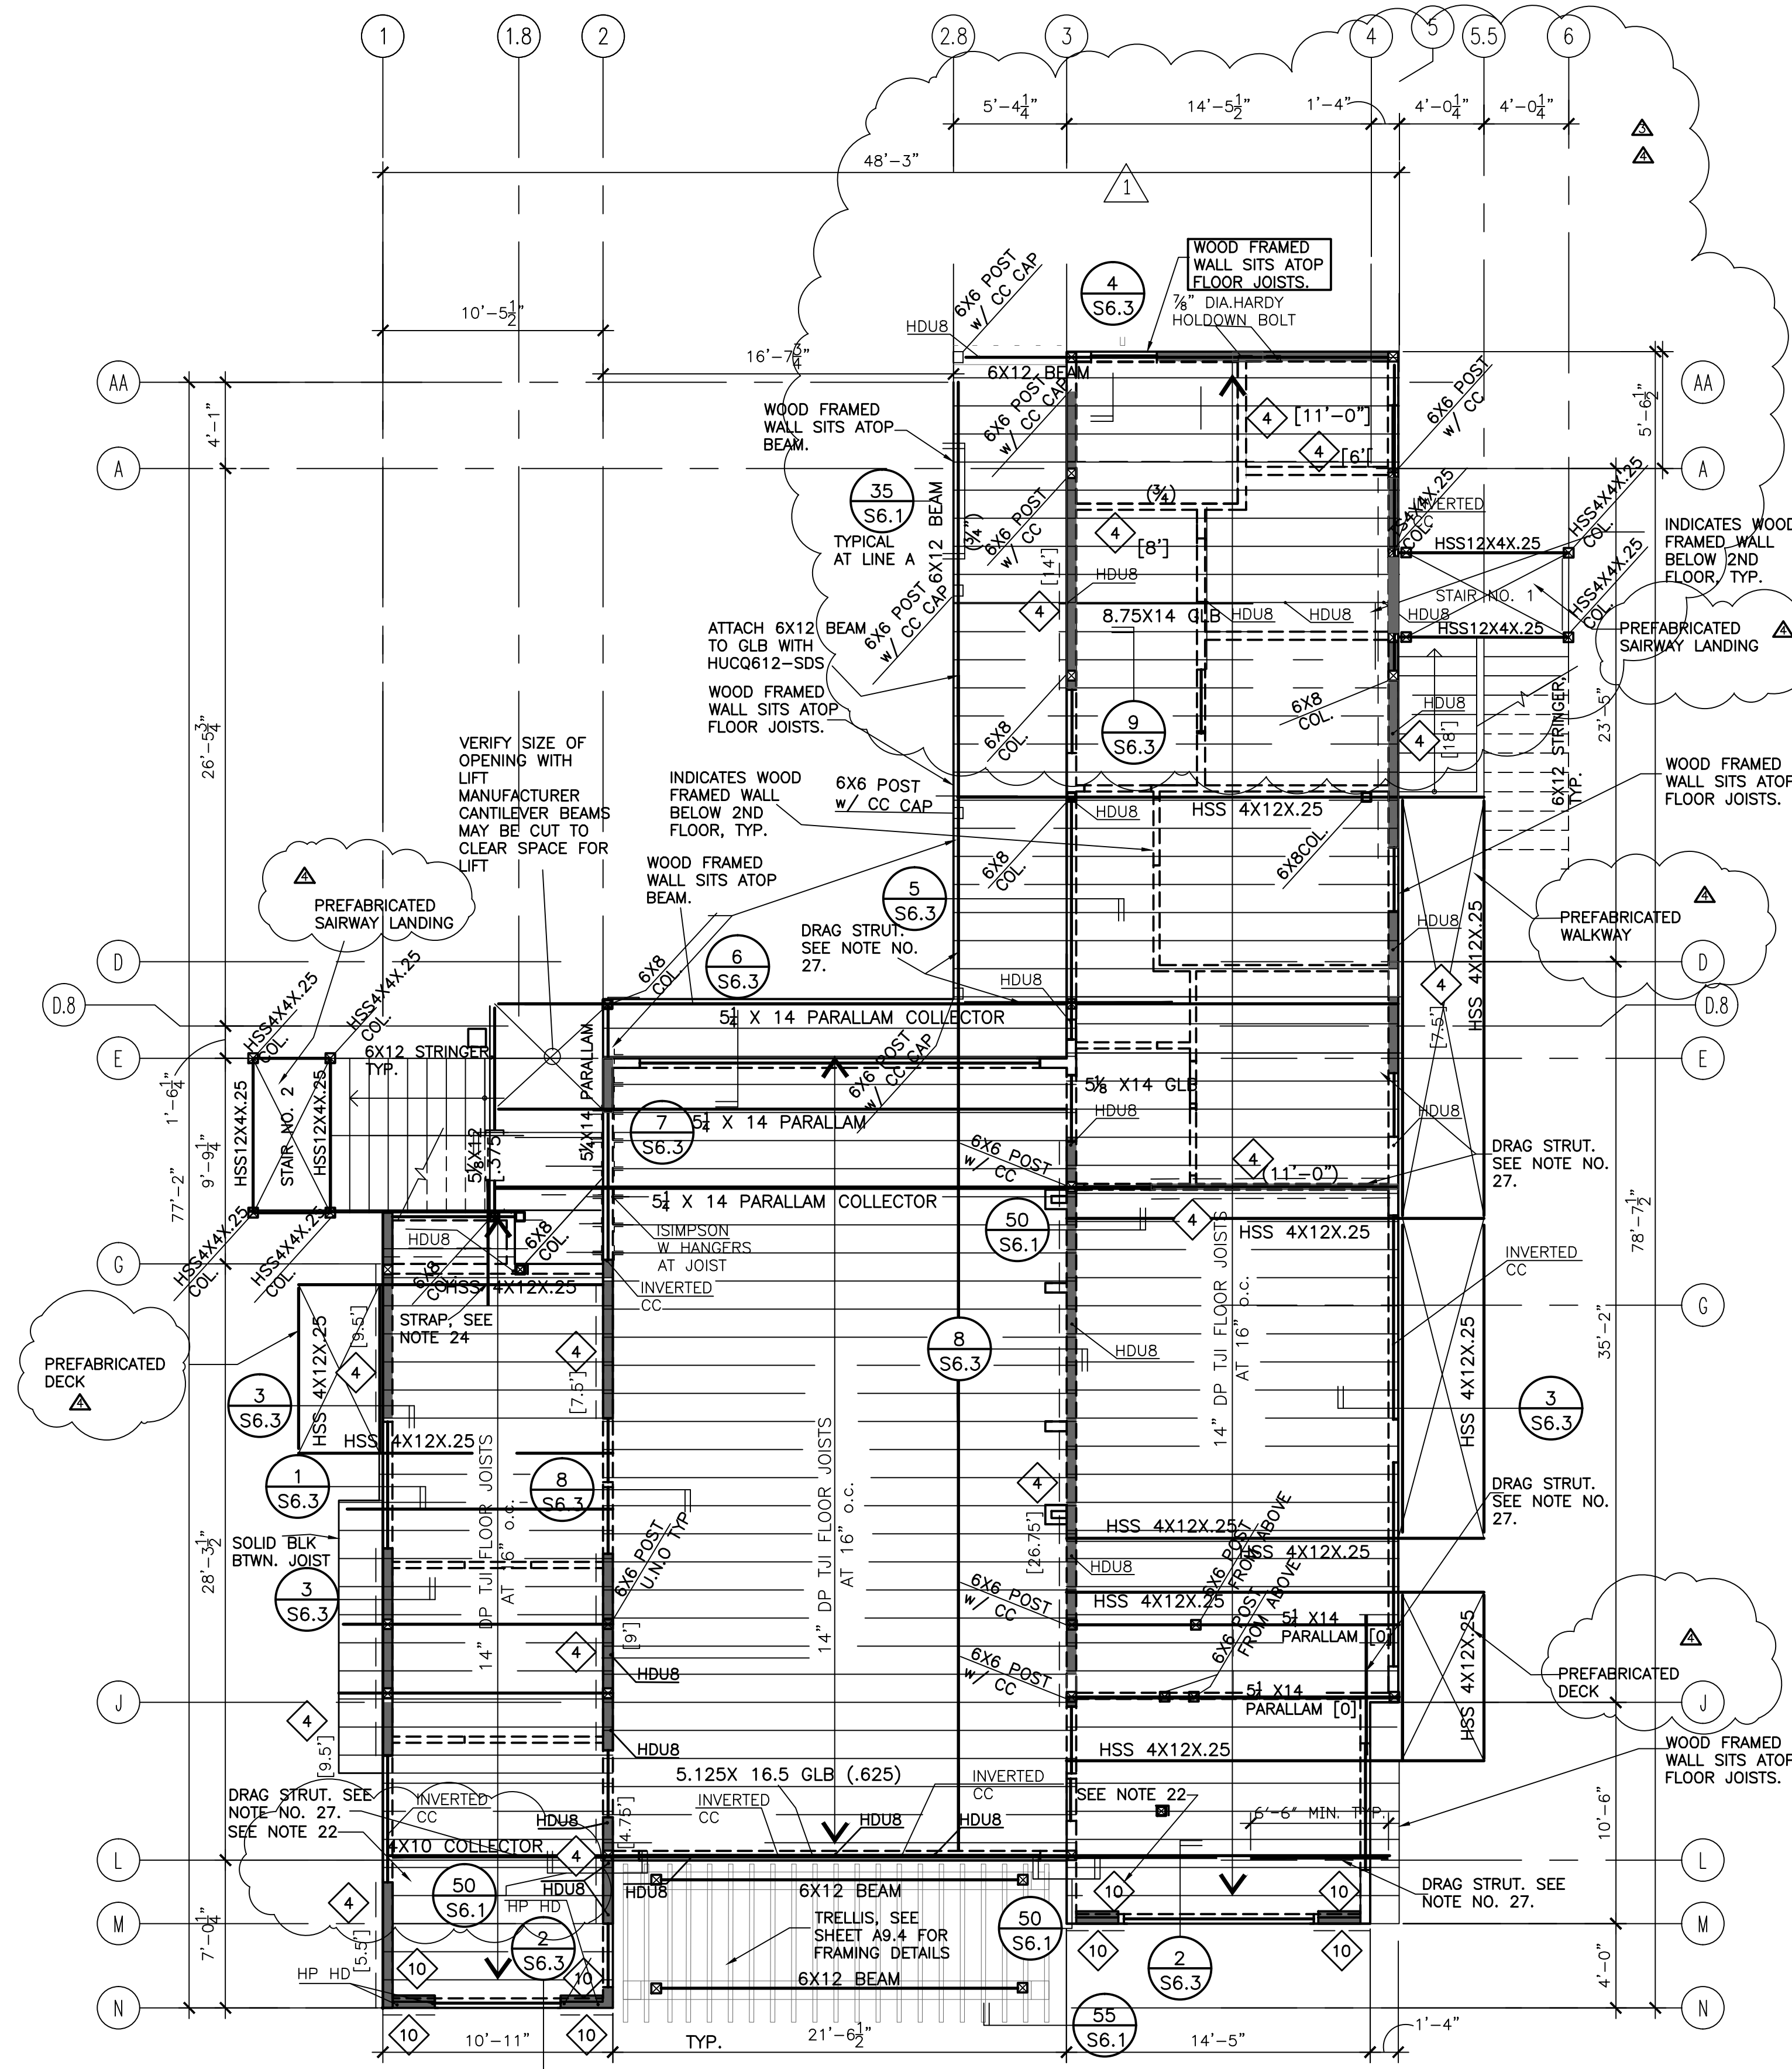




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Of Sheets




**01 COMMUNITY CENTER 2ND FLOOR FRAMING PLAN**  
SCALE:  $3/16" = 1'-0"$  NOTE ALL PLYWOOD EDGES SHALL BE BLOCKED AT WALL, ROOF AND F

SCALE: 3/16" = 1'-0" NOTE ALL PLYWOOD EDGES SHALL BE BLOCKED AT WALL, ROOF AND FLOOR SHEATHING EXCEPT ROOF ABOVE THIRD FLOOR
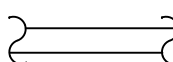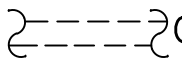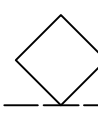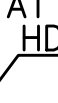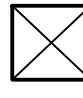
## 2ND FLOOR FRAMING NOTES

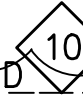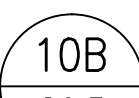



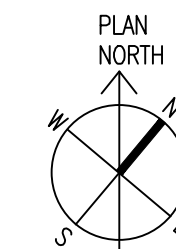


1. SEE GENERAL NOTES ON SHEET S0.1.
2. SEE TYPICAL WOOD DETAILS ON SHEET S6.1 AND S6.2.
3. SEE ARCHITECTURAL DRAWINGS FOR FINISHED FLOOR ELEVATIONS.
4. MARKS "TJI" ETC. INDICATE WOOD TRUSS JOIST.
5. NEW STRUCTURAL WOOD WALLS ARE SHOWN THUS:  OR THUS:  ON PLAN AND SHALL BE AS FOLLOWS:  
2X6 AT 16" o.c. FROM GROUND/FDN TO 2ND FLOOR  
2X6 AT 16" o.c. FROM 2ND FLOOR TO THE ROOF.  
  
USE 3X STUDS ALL ALL WOOD FRAMED SHEAR WALLS.  
SEE ARCHITECTURAL DRAWINGS FOR NON-LOAD BEARING PARTITIONS.
6.  DENOTES (N) 15/32" THK. STRUCTURAL I PLYWOOD SHEAR WALL. AS REQUIRED. PLYWOOD EXTENDS FULL HEIGHT OF THE WALL. SEE DETAILS AND SCHEDULE ON SHEET S1-04.
7. FLOOR TO FLOOR HOLDOWN TIES ARE REQUIRED AT EACH END OF SHEAR WALL AND AT LOCATIONS NOTED THUS:  . ALL HOLDOWNS TO BE ON 6x6 POST U.N.O. SEE DETAILS ON SHEET S3.1, AND S6.1 AND S6.2
8. WHERE METAL FRAMING CONNECTORS ARE REQUIRED, "SIMPSON" CONNECTORS ARE DENOTED.
9.  ON PLAN INDICATES 6X6 POST U.N.O.
10. SEE  FOR HEADER SIZES NOT CALLED OUT ON PLAN
11. SEE ARCH. DWGS. FOR SLOPES OF ROOFS/EXTERIOR DECKS.
12. ALL GLULAM BEAMS 24F-V4
13. [ X ] INDICATES CAMBER IN GLULAM BEAMS
14. SEE ARCH. DWGS. FOR EXACT LOCATION OF WINDOWS & DOORS.
15. ALL FLOOR JOIST ARE 14" DEEP U.N.O. WITH 1 1/2" LIGHTWEIGHT CONCRETE TOPPING OVER 3/4" CDX PLYWOOD.
16. AT SHEAR WALL TYPE  AND  PROVIDE HARDY PANEL PER THE WIDTHS INDICATED ON THE SHEAR WALL SCHEDULE SHOWN ON SHEET S6.2. PROVIDE ASSOCIATED HOLDOWNS, SILL ANCHORAGE AND SHEAR TRANSFER DETAILS PER THE MANUFACTURES STANDARD DETAILS.
17. WHERE NOTED ON PLAN AS "HP HD" INDICATES HARDY PANEL HOLDOWN. PROVIDE HARDY PANEL FLOOR TO FLOOR HOLDOWN PER THE MANUFACTURES STANDARD DETAILS.
18. WHERE NOTED ON PLAN AS "HP HD\*" INDICATES HARDY PANEL HOLDOWN THAT RESTS ATOP A BEAM. PROVIDE HARDY PANEL FLOOR TO BEAM HOLDOWN PER THE MANUFACTURES STANDARD DETAILS.
19. NOT USED.
20. ALL TJI'S ARE TJI/360, TYP. U.N.O..
21. 6X6 POST FROM ABOVE
22. PROVIDE BLOCKING @ 4'-0" O.C. IN-BETWEEN JOISTS BLOCK ALL PLYWOOD EDGES
23. DOUBLE JOIST UNDER ALL PARALLEL PARTITIONS.
24. 10' LONG CMST12 STRAP. CENTER STRAP AT END OF BEAM AND PROVIDE FULL BLOCKING AT FLOOR JOIST
25. NOT USED.
26. FOR STAIR 1 AND STAIR 2 FRAMING PLANS AND ELEVATIONS, SEE SHEET S5.1.
27. INDICATES DRAG STRUT/CHORD USING CMST12 CONT. STRAP. SEE  FOR CONNECTION INFO. EXTEND STRAP ACROSS ENTIRE DIAPHRAGM U.N.O.



<b>REVISIONS</b>		<b>BY</b>
9/26/2011 - PLAN CHECK		G.O.
2/3/2012 - 3RD STRY		RT-J
ADDED NOTE FOR POST FROM ABOVE AND SUPPORT		RFAMS
ENLARGED ELECTRIC ROOM		
ADDED PREFABRICATED STAIRS AND BALCONY		
REVISED FLOOR FRAMING BIDDING		
<p style="text-align: center;"><b>O A K L E Y   &amp;   O A K L E Y</b>  <b>E N G I N E E R S</b>  77001 CEDARWATER DRIVE STE. 615  OAKLAND, CA 94621  P H O N E . 5 1 0 . 5 6 2 . 6 0 4 3  F A X . 5 1 0 . 5 6 2 . 6 0 4 3</p>		
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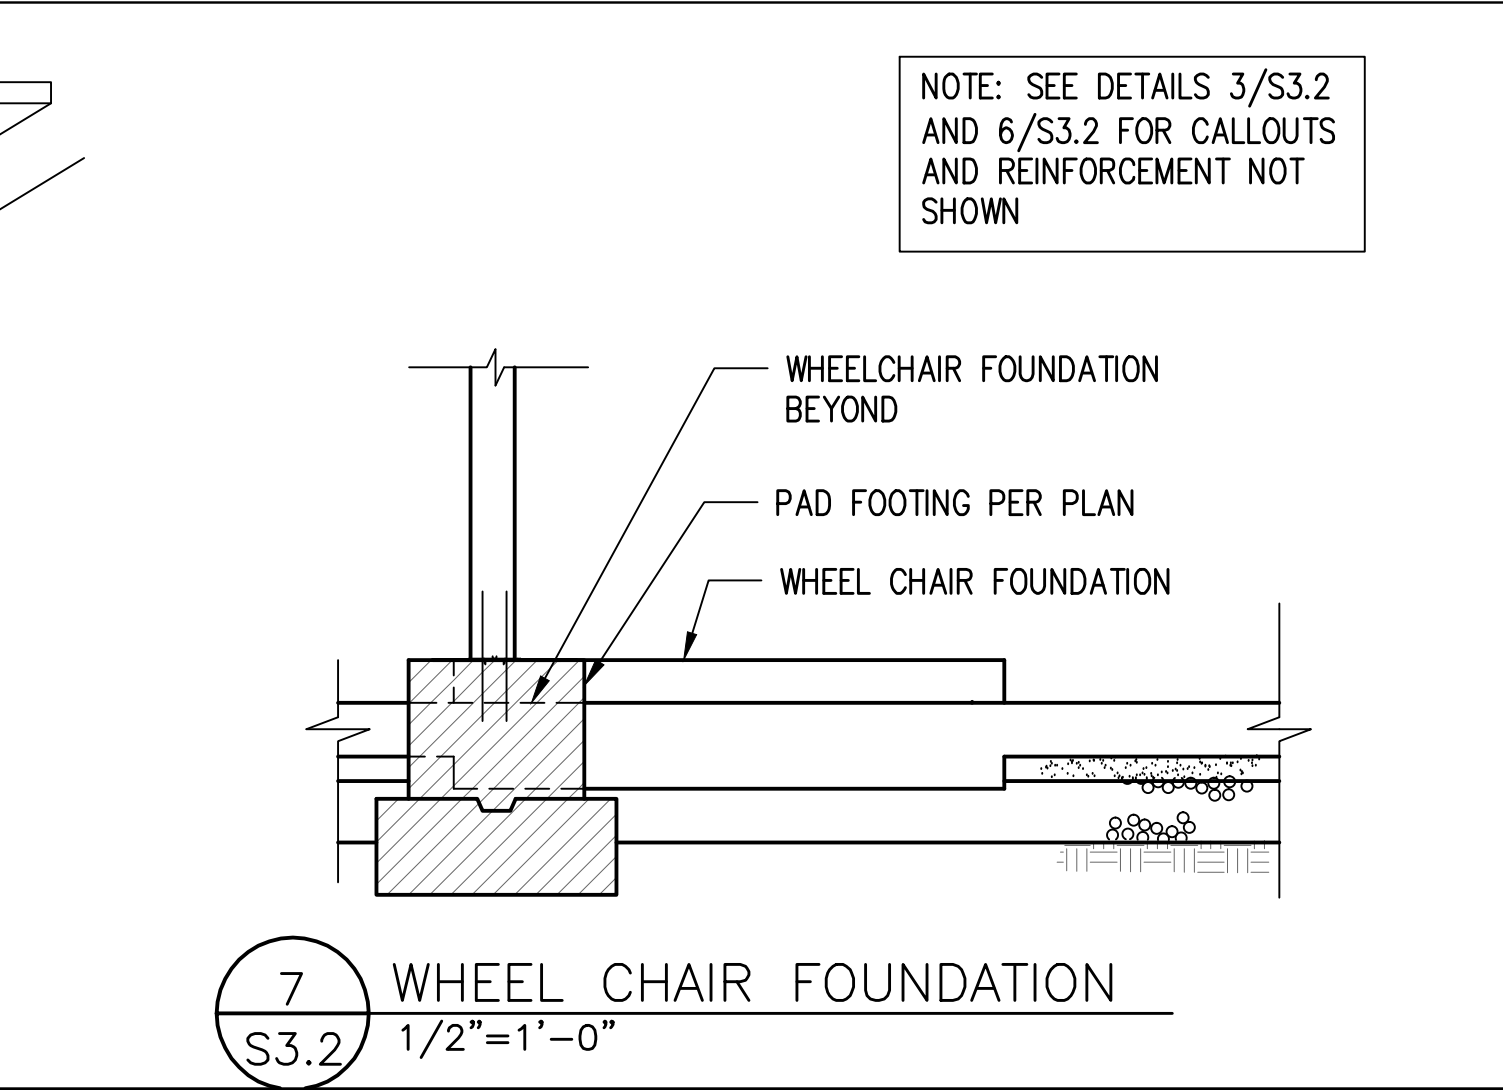
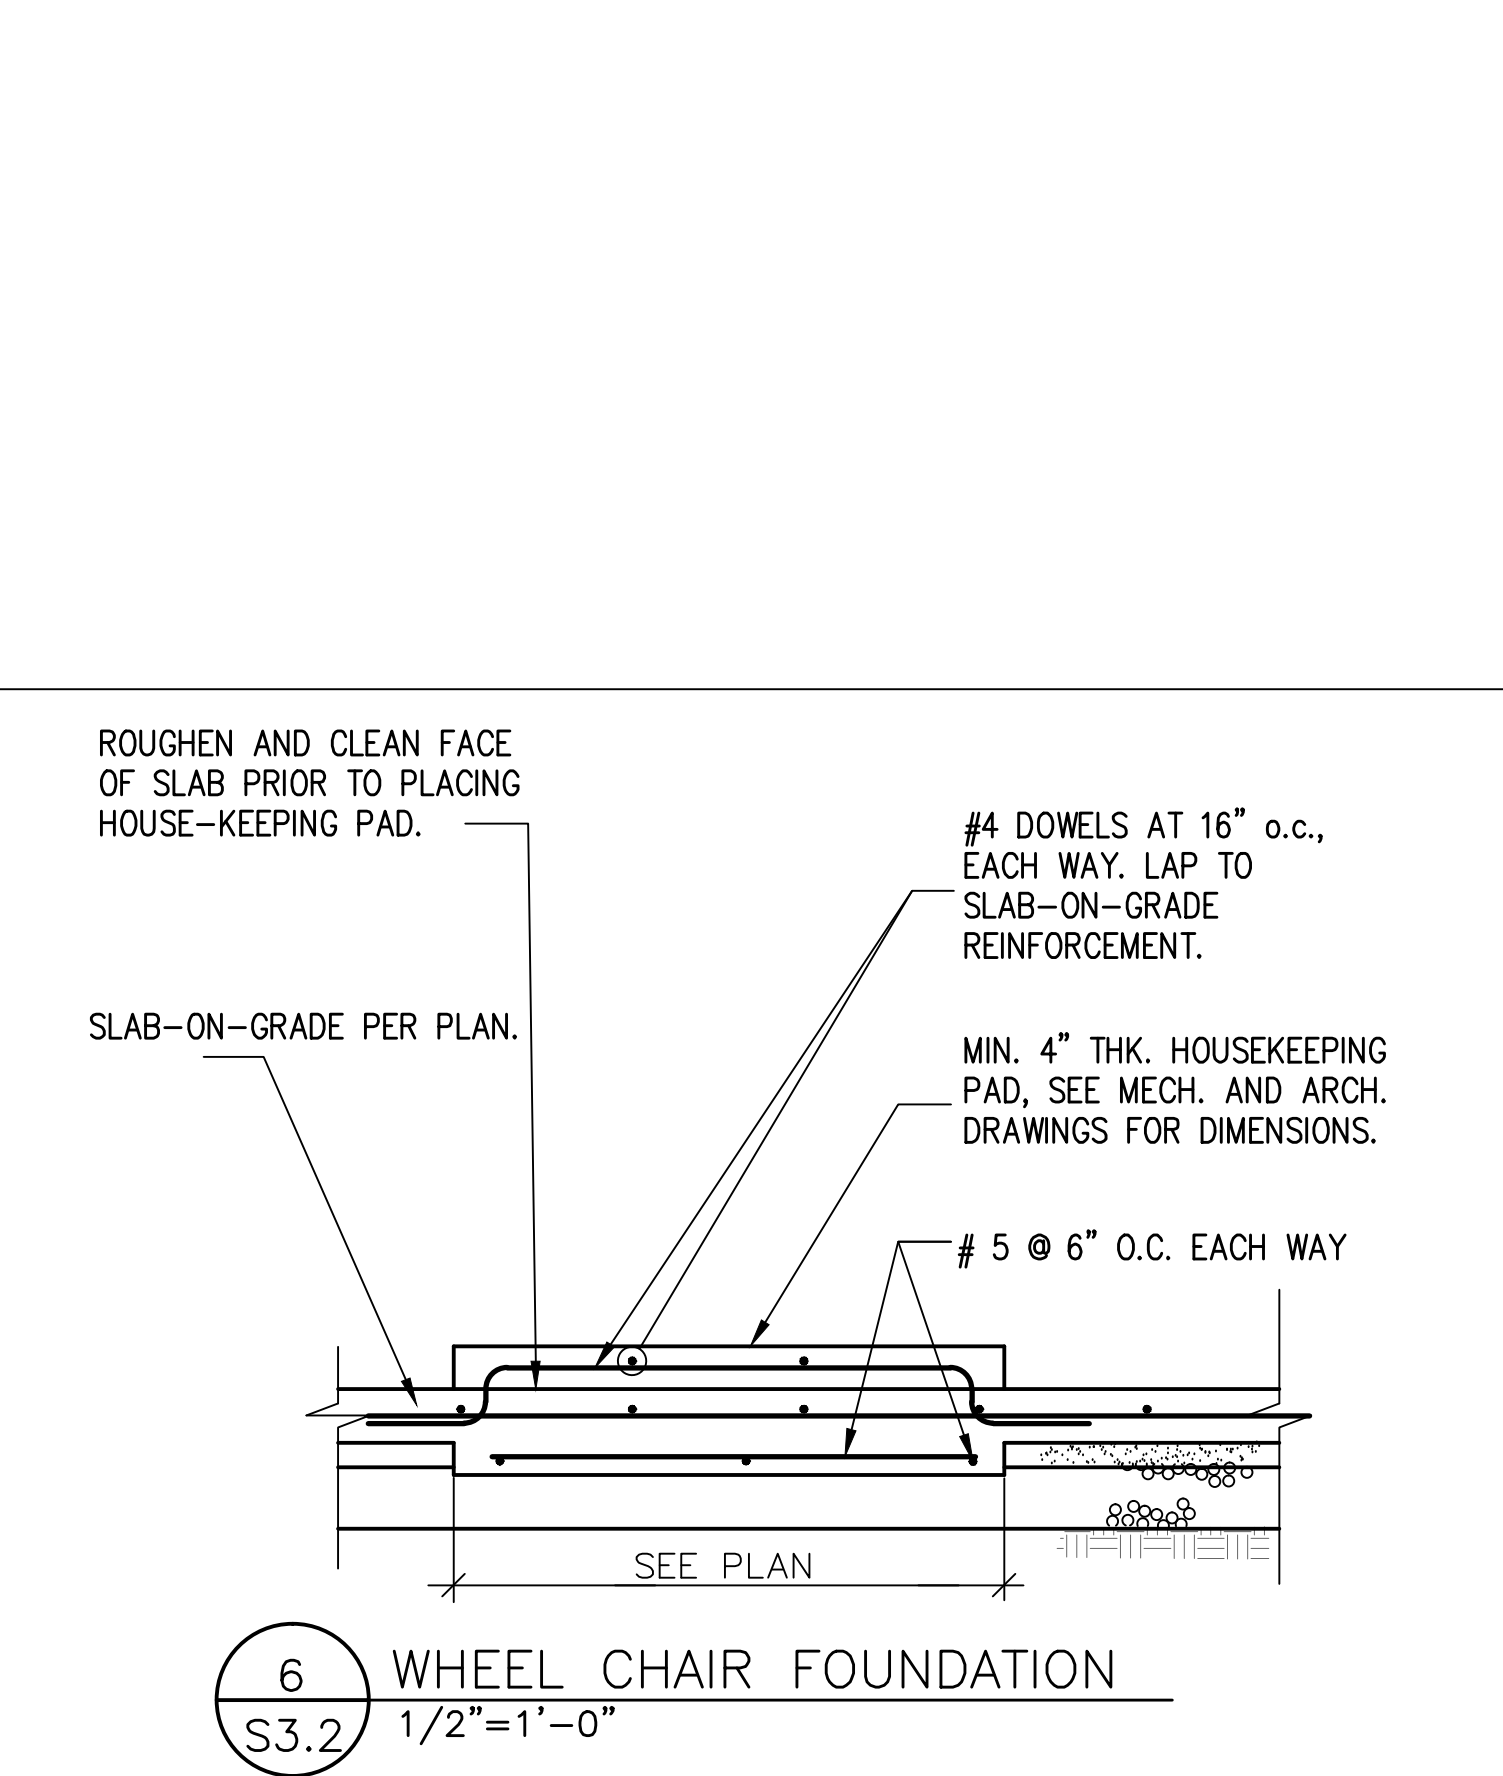
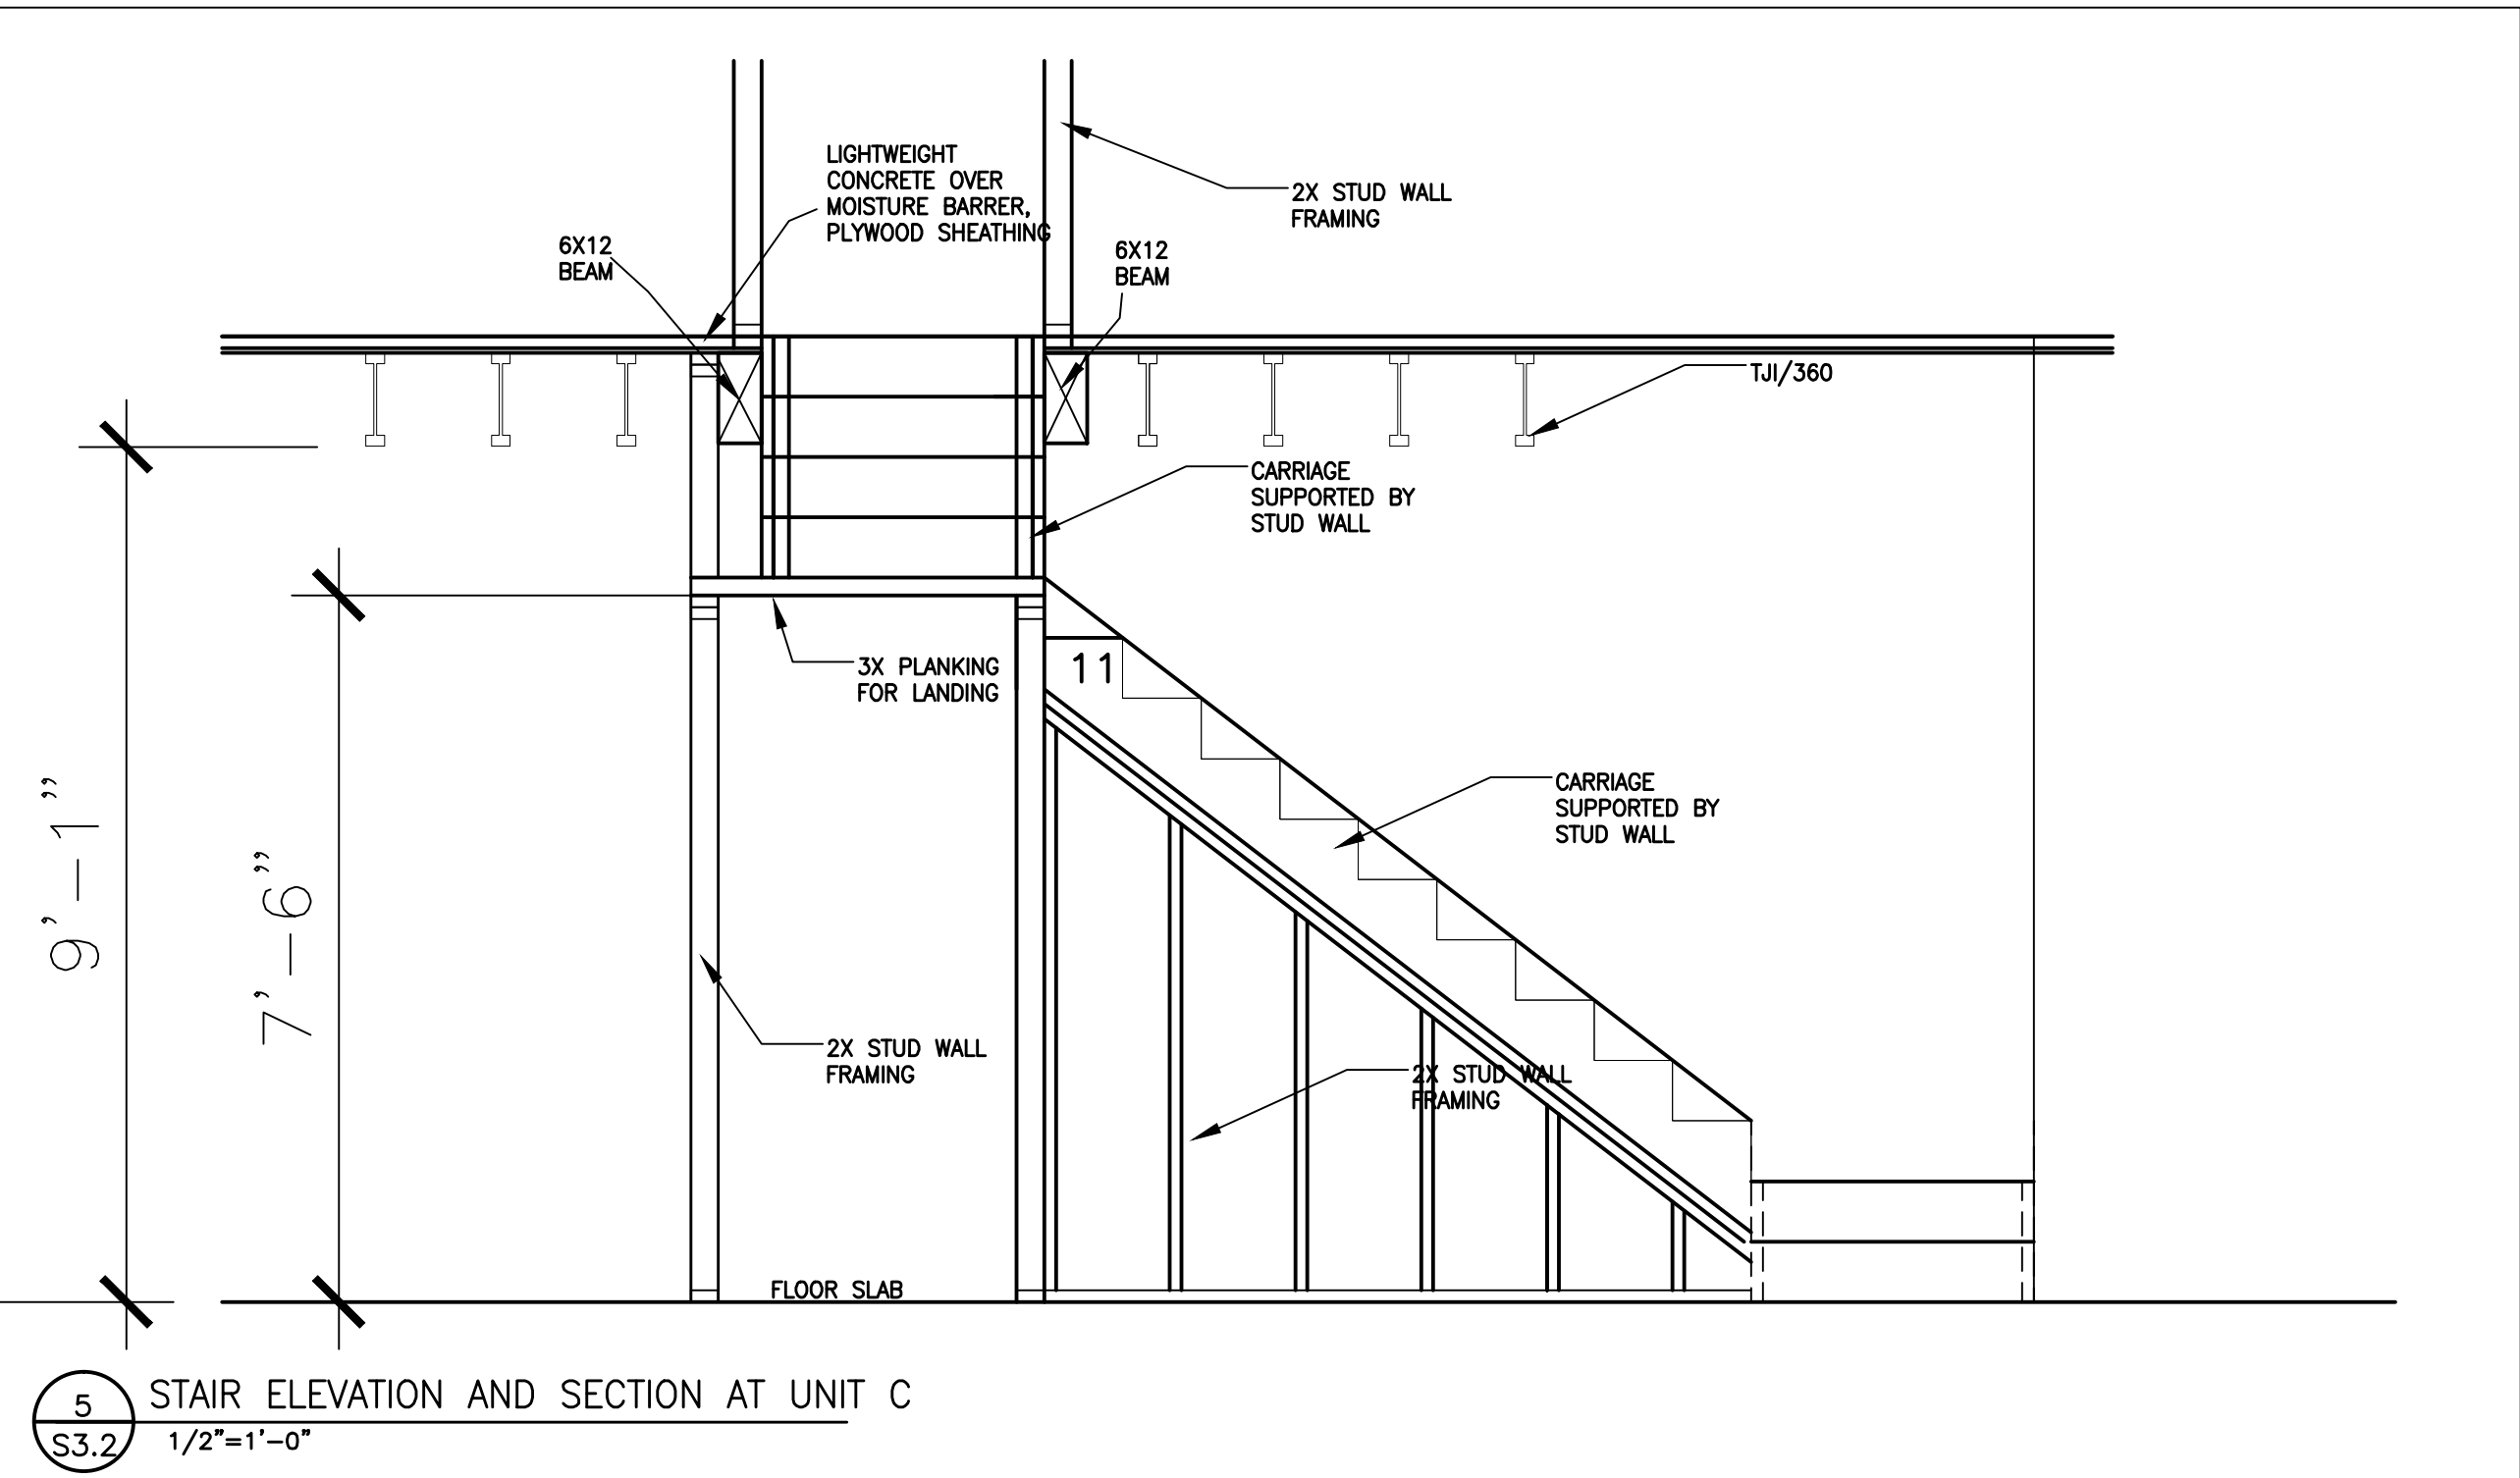
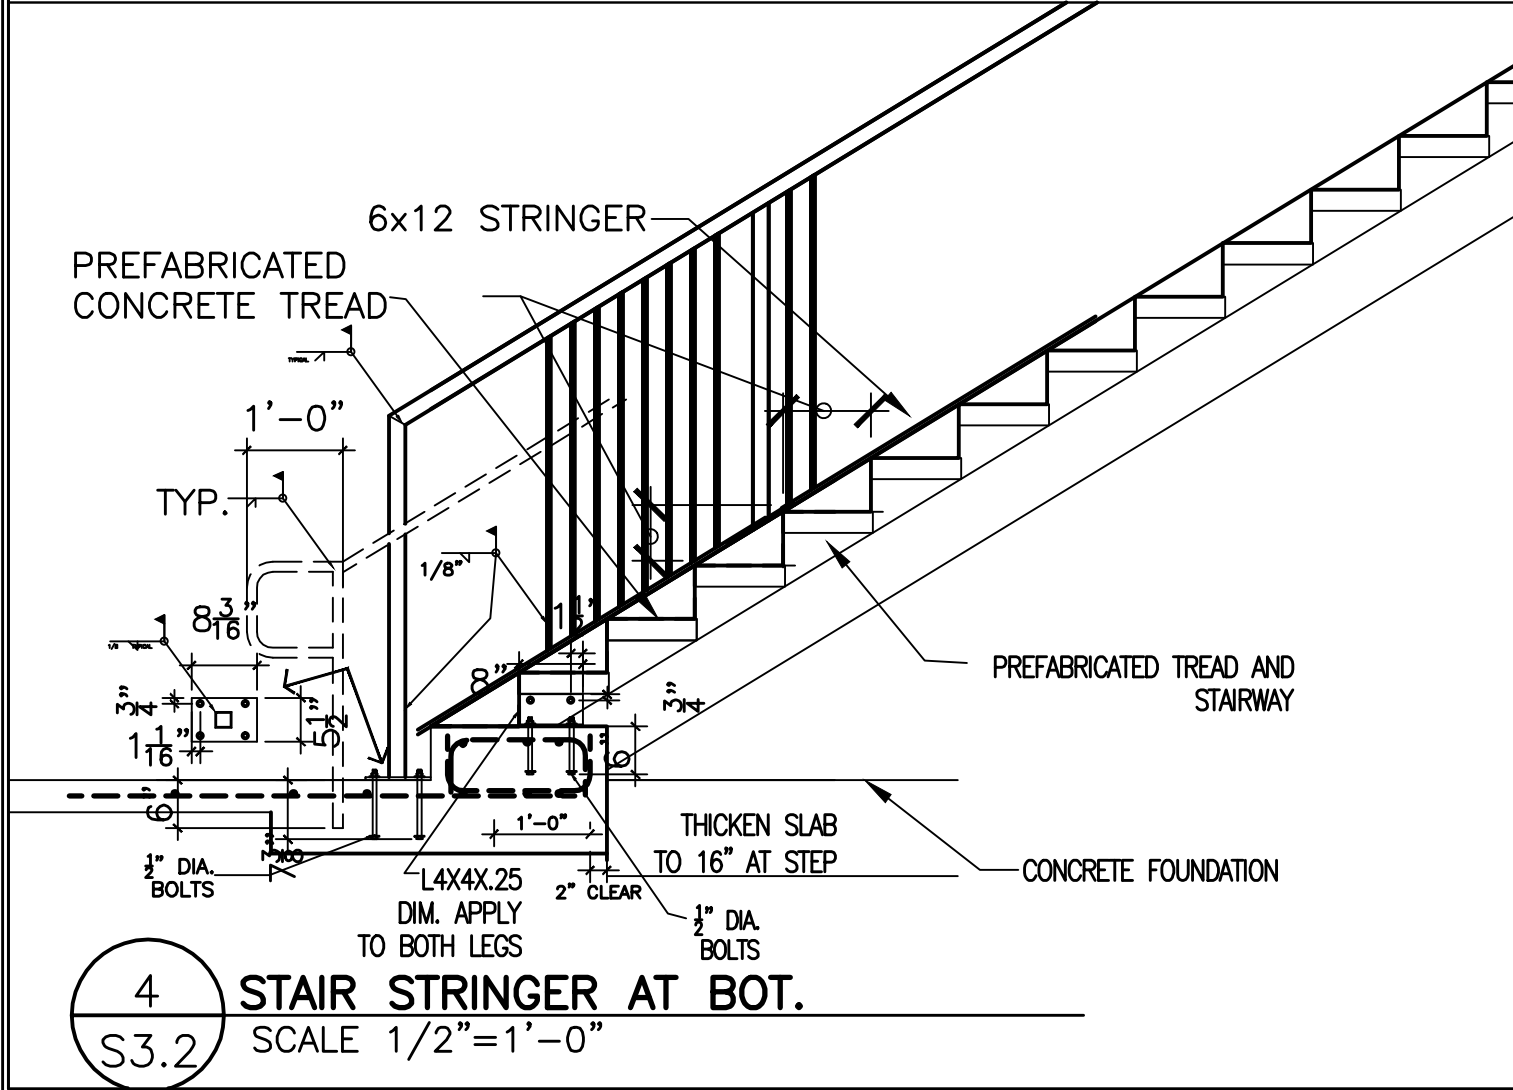
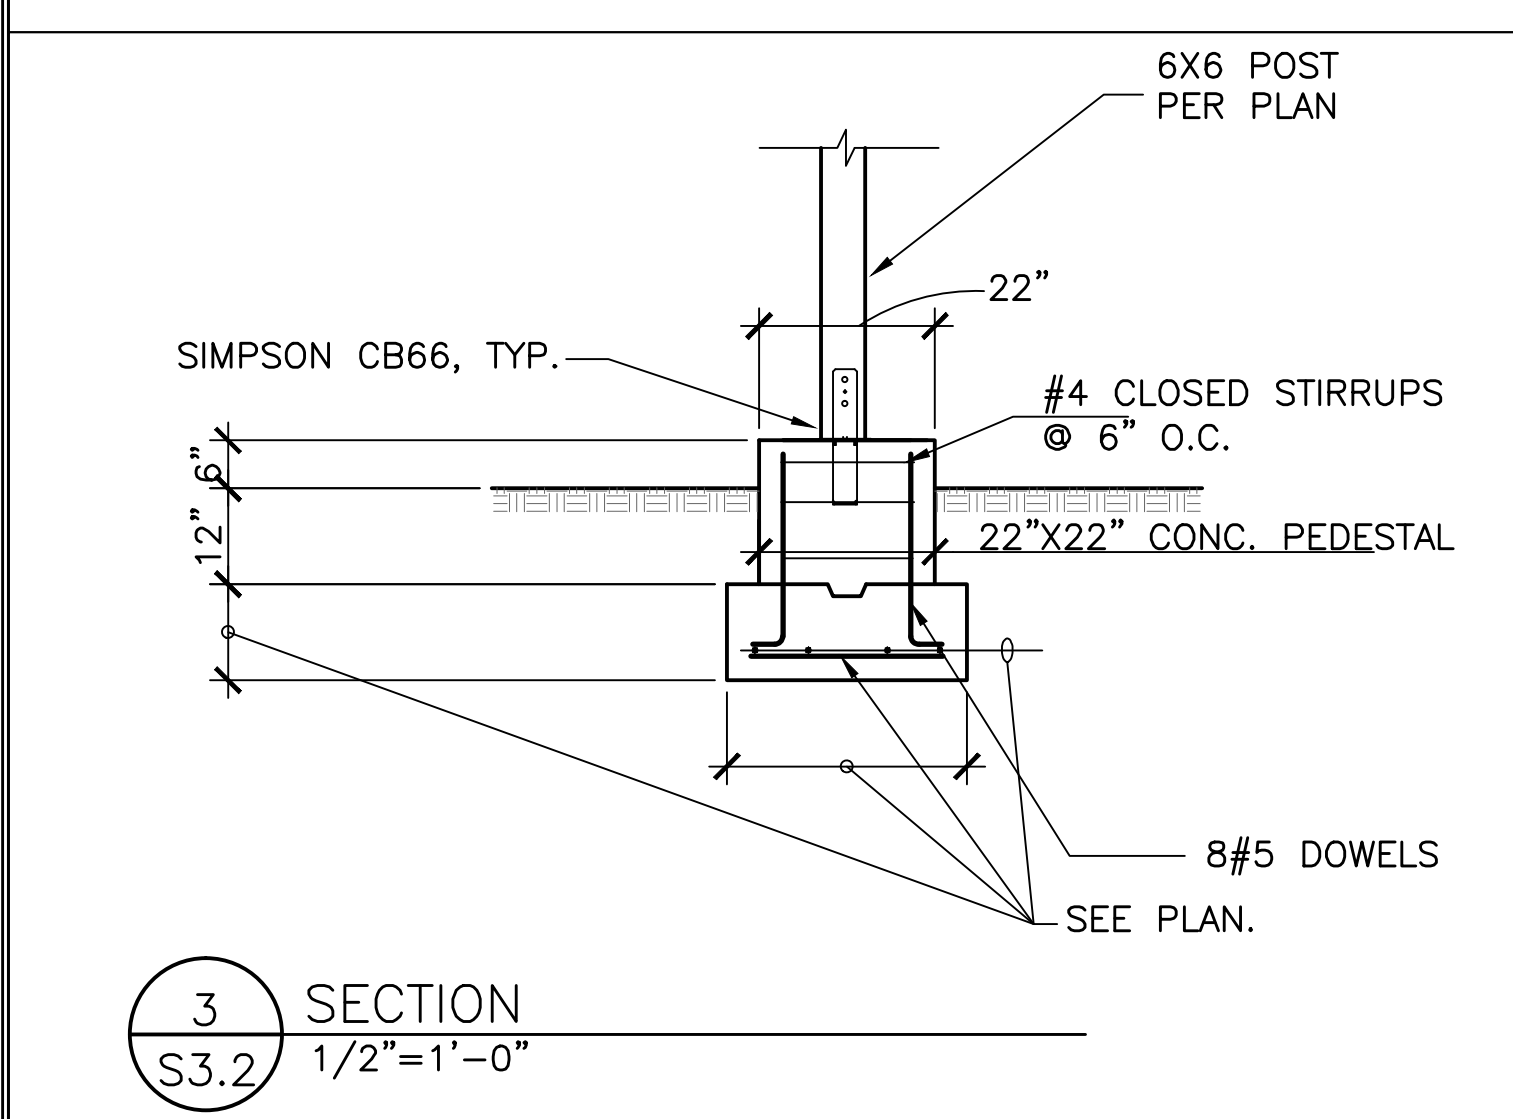
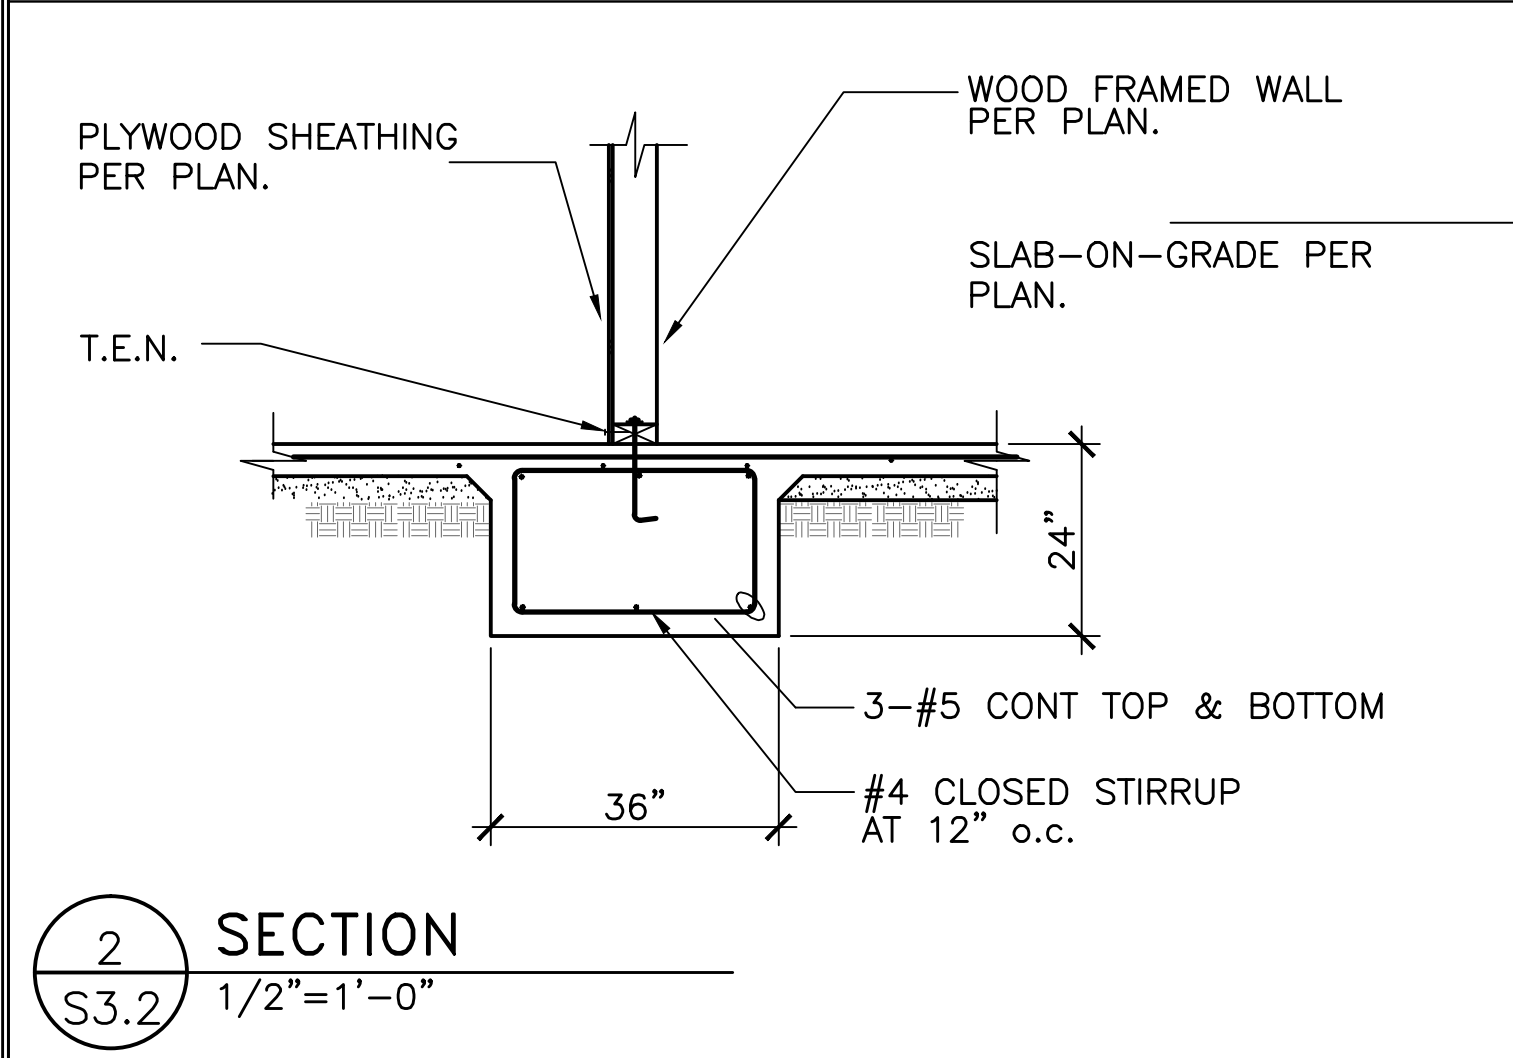
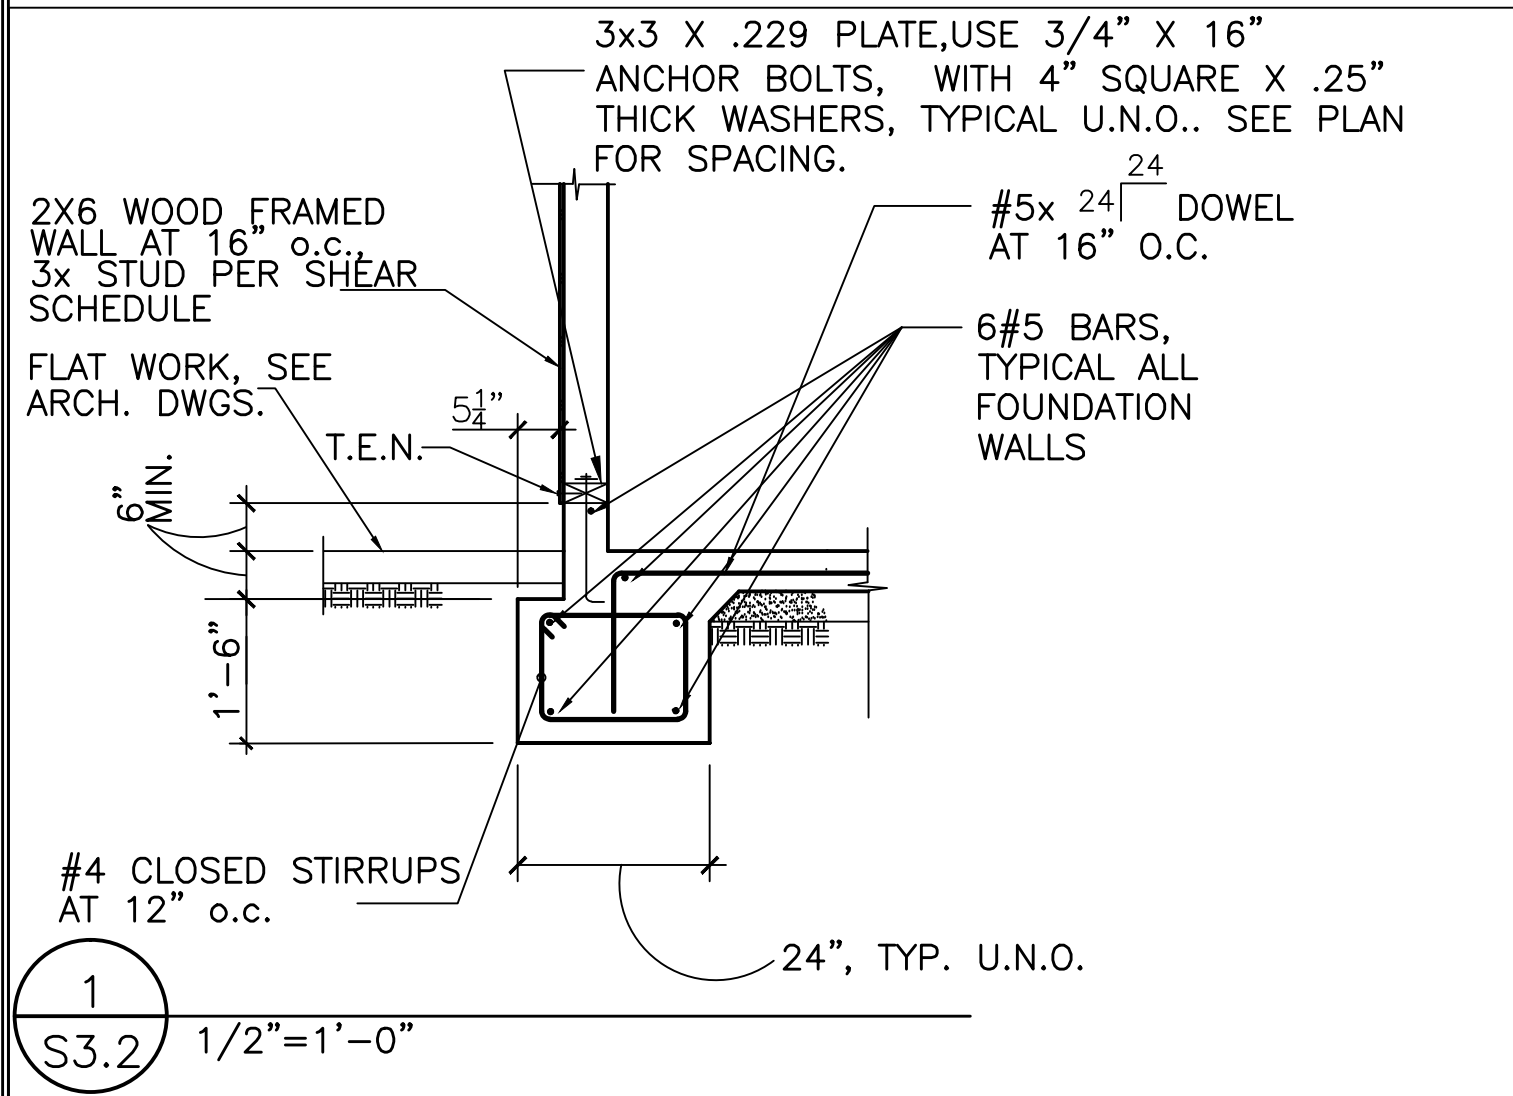


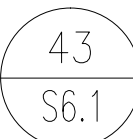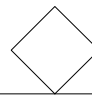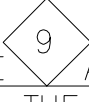

1. SEE GENERAL NOTES ON SHEET S0.1.
2. SEE TYPICAL WOOD DETAILS ON SHEETS S6.1 AND S6.3.
3. WHERE NOTED ON PLAN, PROVIDE 2x12 TAPERED TO 2x10 AT 24" O.C. SEE ARCH
4. STRUCTURAL WOOD WALLS SUPPORTING THE ROOF ARE SHOWN THUS:  OR THUS:  WHERE PARAPET OCCURS. SEE ARCHITECTURAL DRAWINGS FOR NON-LOAD BEARING PARTITIONS.
5. WHERE NEW METAL FRAMING CONNECTORS ARE REQUIRED, "SIMPSON" CONNECTORS ARE DENOTED.
6. NOT USED.
7. SEE  FOR HEADER SIZES NOT CALLED OUT ON PLAN
8. SEE ARCH. DWGS. FOR SLOPES OF ROOFS.
9. ALL GLULAM BEAMS 24F-V4
10. [ X ] INDICATES CAMBER IN GLULAM BEAMS
11. SEE ARCH. DWGS. FOR EXACT LOCATION OF WINDOWS AND DOORS.
12.  INDICATES NEW SHEAR WALL. SEE SCHEDULE ON SHEET S6.2.
13. ALL NEW WOOD FRAMED BEARING WALLS ARE 2x6 @ 16" O.C. TYP. U.N.O. USE 3x6 STUDS AT SHEAR WALLS
14. AT SHEAR WALL TYPE  AND  PROVIDE HARDY PANEL PER THE WIDTHS INDICATED ON THE SHEAR WALL SCHEDULE SHOWN ON SHEET S6.2. PROVIDE ASSOCIATED HOLDDOWNS, SILL ANCHORAGE AND SHEAR TRANSFER DETAILS PER THE MANUFACTURES STANDARDS.
15. NOT USED.
16. ALL TJI'S ARE TJI/360, TYP U.N.O.
17. WHERE NOTED ON PLAN PROVIDE 11 7/8" DP TJI JOIST AT 24" o.c..
18. ROOF SHEATHING IS 5/8" STRUCT 1 PLYWOOD w/ 10d NAILS AT 4" o.c., PROVIDE BLOCKING.
19. NOT USED.
20. U.N.O. TOP PLATE SPLICES ALONG GRIDLINES THAT ARE SHEARWALLS SHALL BE MST48
21. USE 8'-0" LONG CMST12 BOTH WAYS, CENTER ON CORNER BLOCK FLOOR JOISTS AS REQUIRED
22. NOT USED.
23. INDICATES DRAG STRUT/CHORD USING CMST12 CONT. STRAP. SEE  FOR CONNECTION INFO.
24. DESIGN TRUSSES AT STRUT LOCATIONS FOR 2.5 KIP LOAD AT TOP CHORD. USE CMST12 STRAP AS TENSION TIE UNLESS NOTED OTHERWISE
25. WHERE NOTED ON PLAN INDICATES EXTENT OR TAPERED INSULATION. SEE ARCHITECTURAL DRAWING FOR ADDITIONAL INFORMATION
26. FOR STAIR 1 AND STAIR 2 FRAMING DETAILS AND ELEVATIONS, SEE SHEET S5.1

[illegible]

Jun 27, 2014 - 11:25pm \\SERVER\Server Drive D\Year 2011 Jobs\2011-09\3 - Community Bldg\REVISED DRAWINGS FOR NEGOTIATED CONTRACT WITH VE LYONS\STRUCTURAL\S3.2.dwg




REVISIONS	BY
9/26/2011 - PLAN CHECK	G.O.



**OAKLEY & OAKLEY**  
REGISTERED PROFESSIONAL ENGINEERS  
PROJECT CIVIL & STRUCTURAL ENGINEERS  
OAKLAND, CA 94612  
TEL: 510.566.6043 FAX: 510.566.6043


PROJECT TITLE:  
**COMMUNITY CENTER**  
HARBOR PARK APARTMENTS  
969 PORTER STREET, VALLEJO, CA 94560  
DRAWING TITLE:  
**FOUNDATION DETAILS**

Date:	08/30/2011
Scale:	AS NOTED
Drawn:	STAFF
Checked:	RY
Job No.:	2011-09
Sheet:	<b>S3.2</b>
Of	Sheets

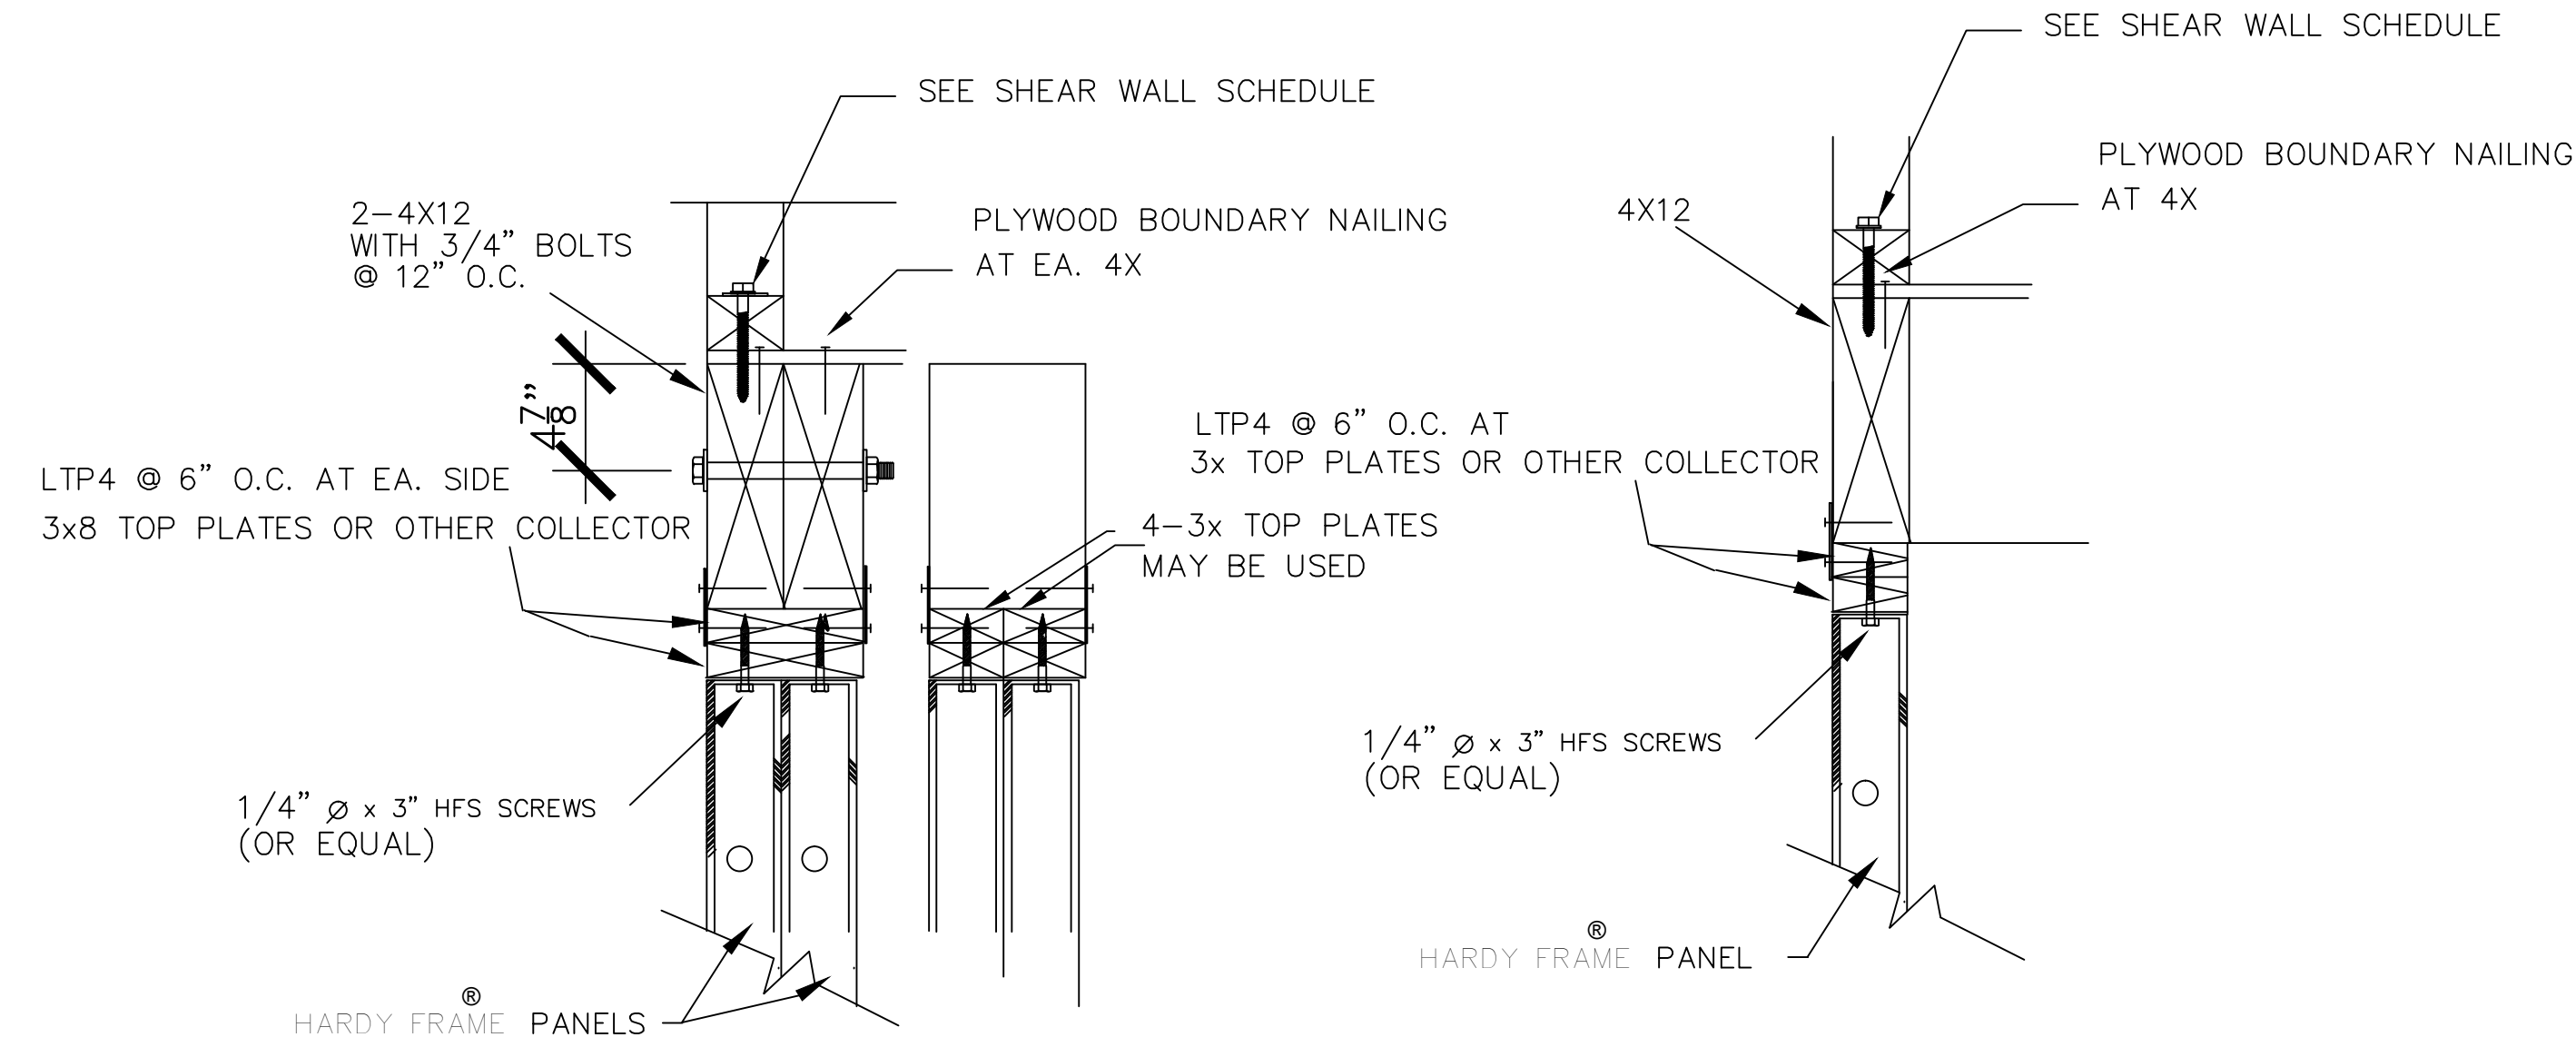

### HARDY FRAME® SECTION AT TOP PLATES

#### SINGLE FACE INSTALLATION

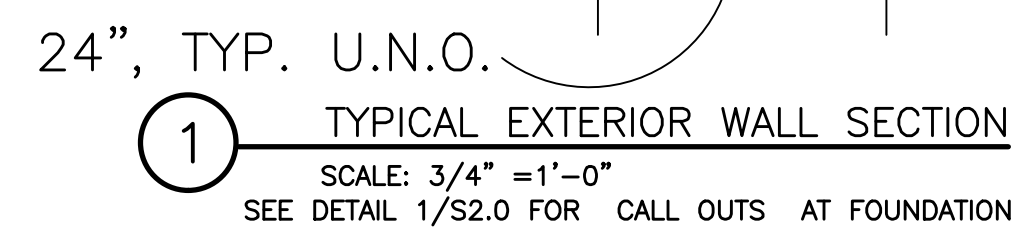



3 TYPICAL SECTION AT SIDE BY SIDE HARDY FRAMES  
NO SCALE

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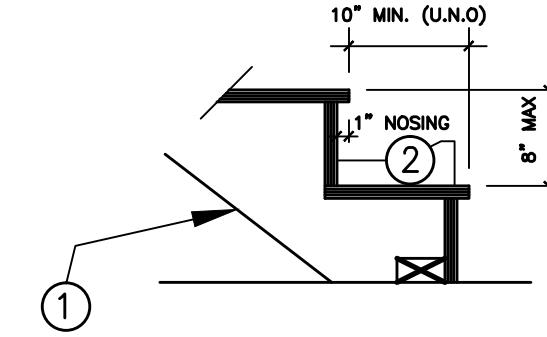
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Of Sheets

Jan 27, 2014 - 11:27pm \\SERVER\Server Drive D\Year 2011 Jobs\2011-09-3 - Community Bldg\REVISED DRAWINGS FOR NEGOTIATED CONTRACT WITH VE LYONS\STRUCTURAL\S5.1.dwg






- 1 2X14 STRINGERS (MIN 2) (PRESSURE TREATED)
- 2 2X12 OR 1.125" PLY TREADS & RISERS (MIN 3/4")
- 3 2X4 THRUST PLATE OR SILL ANCHORED W/ SHOT PINS AT 24" O.C. W/ 2 DIA. WASHERS (SIMPSON PDPWL-300 PINS-ICC-ES ER 4546) NOTES ON FOUNDATION PLAN)

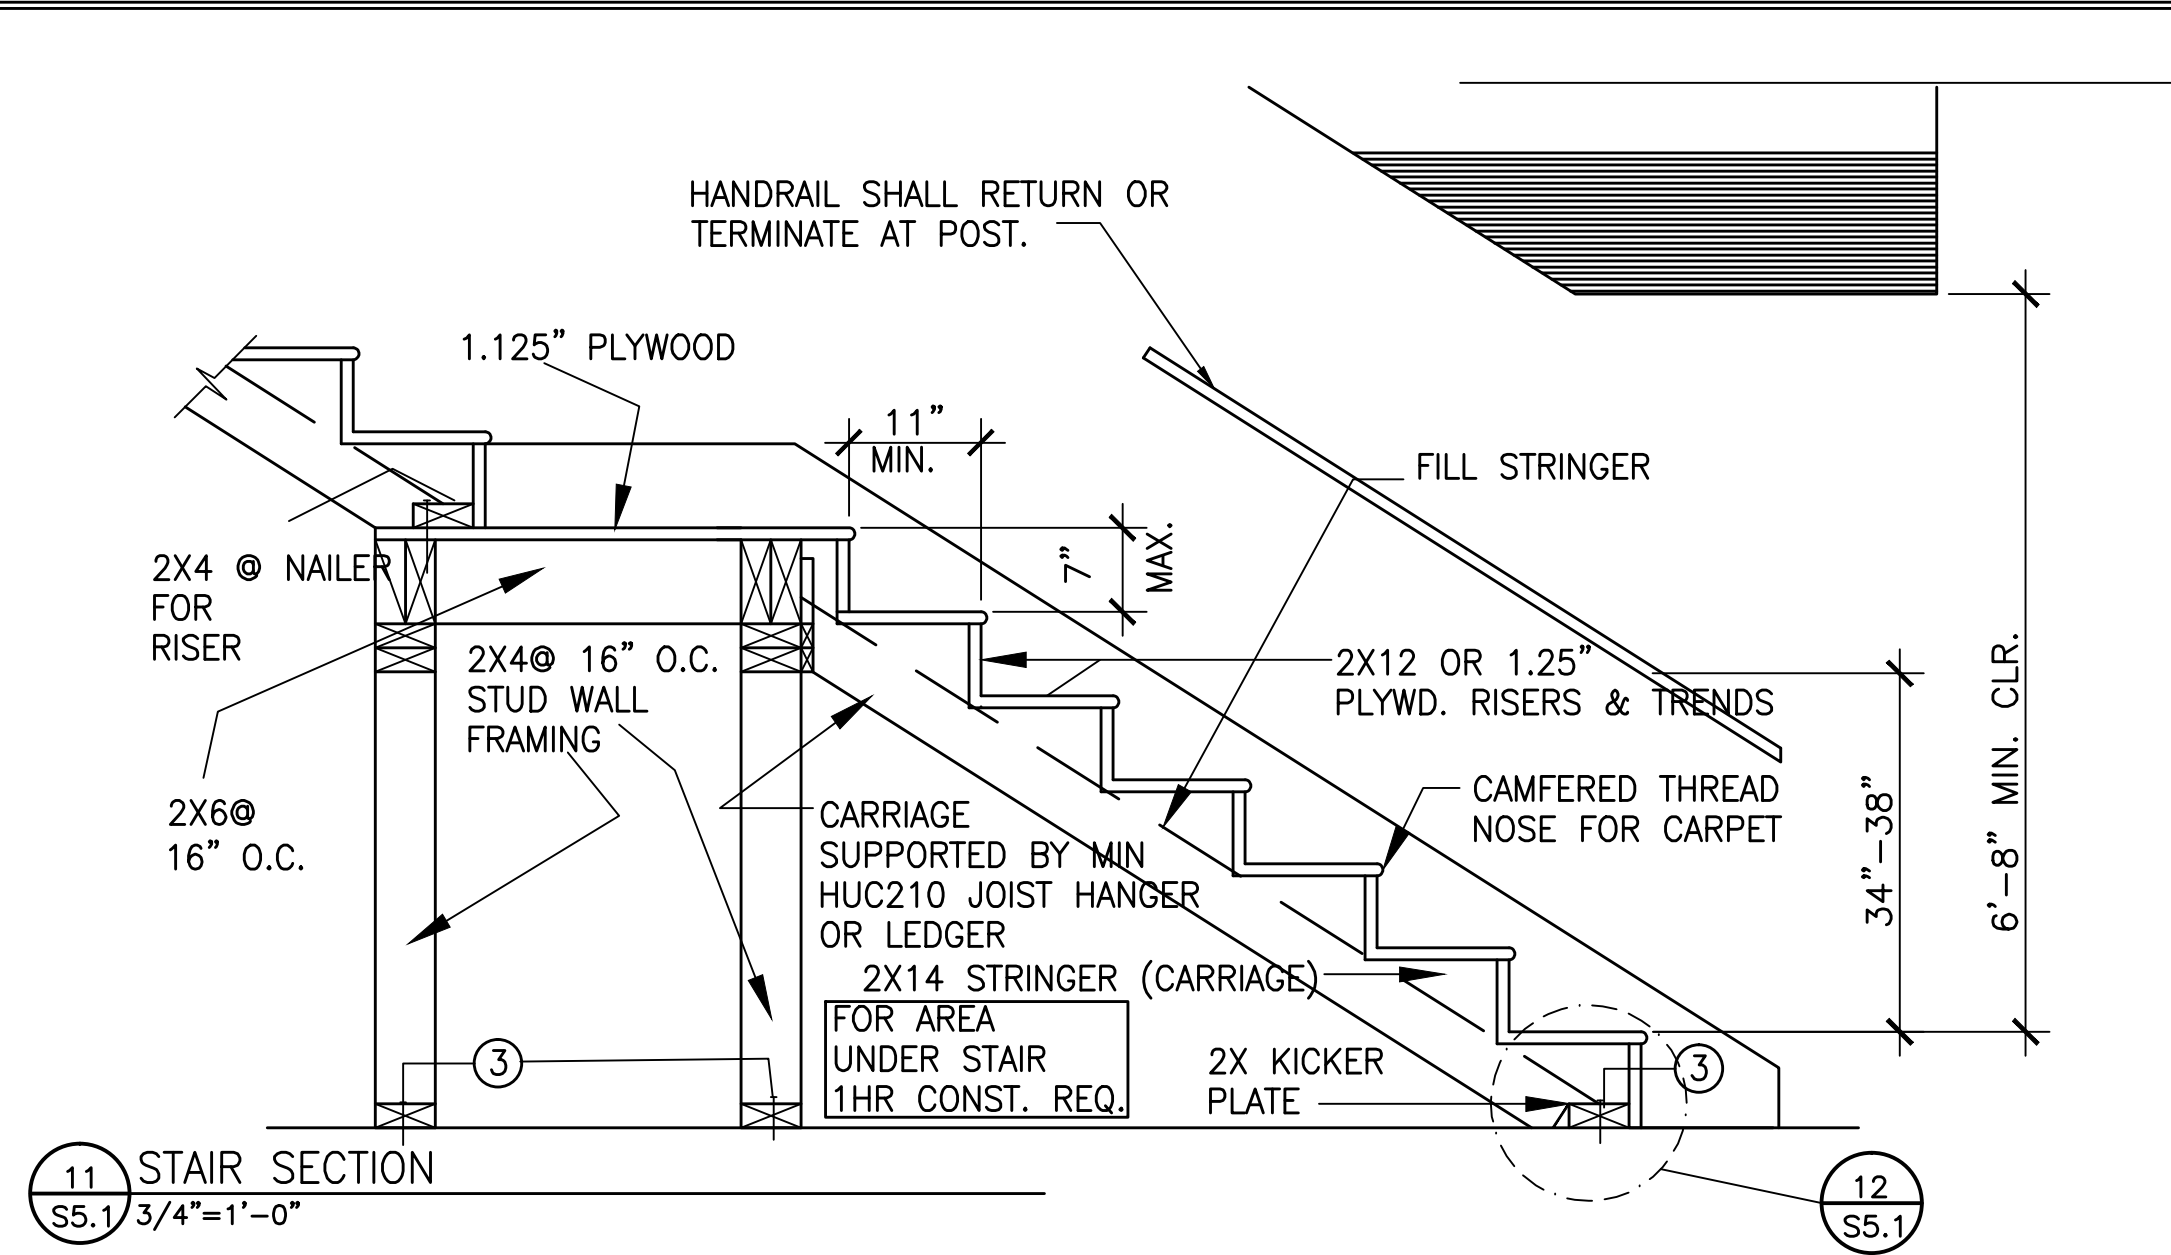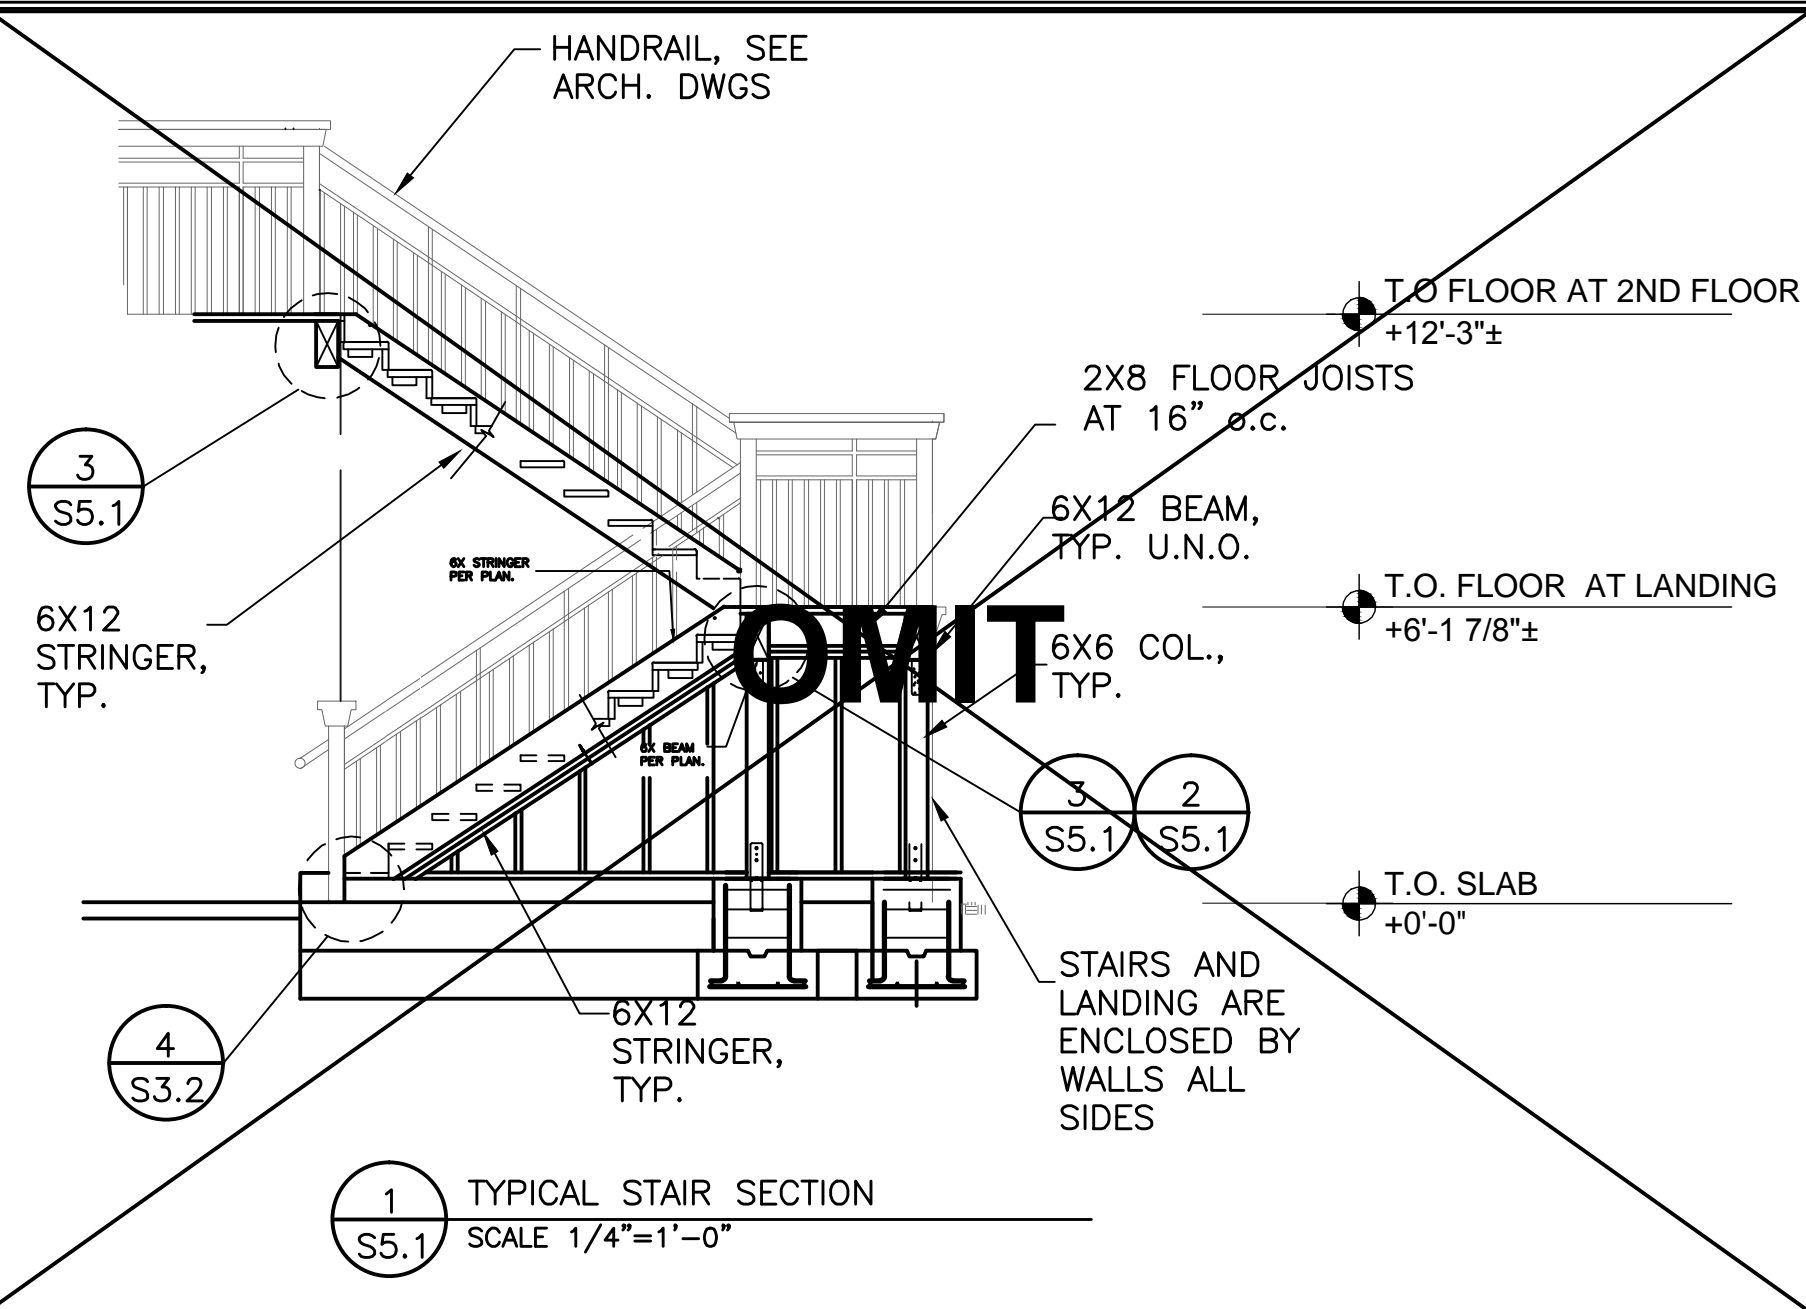

STRINGER @ FLOOR


12 S5.1  
3/4"=1'-0"

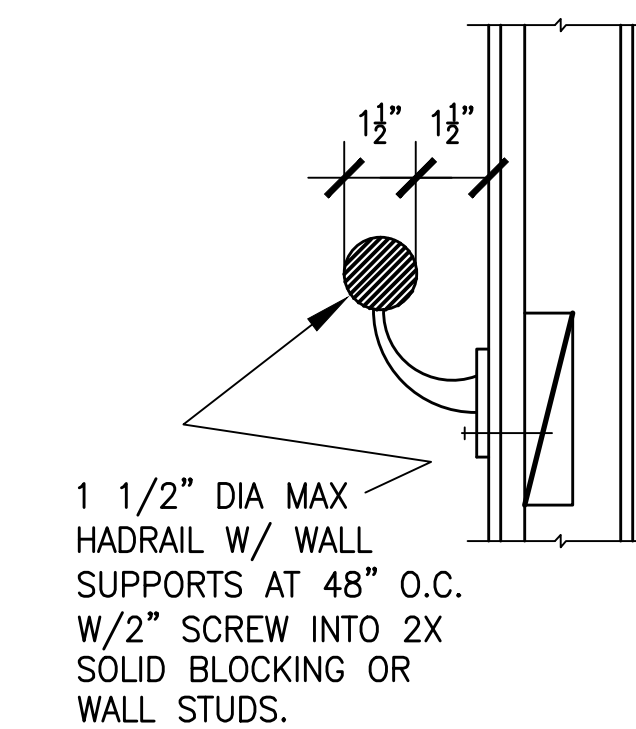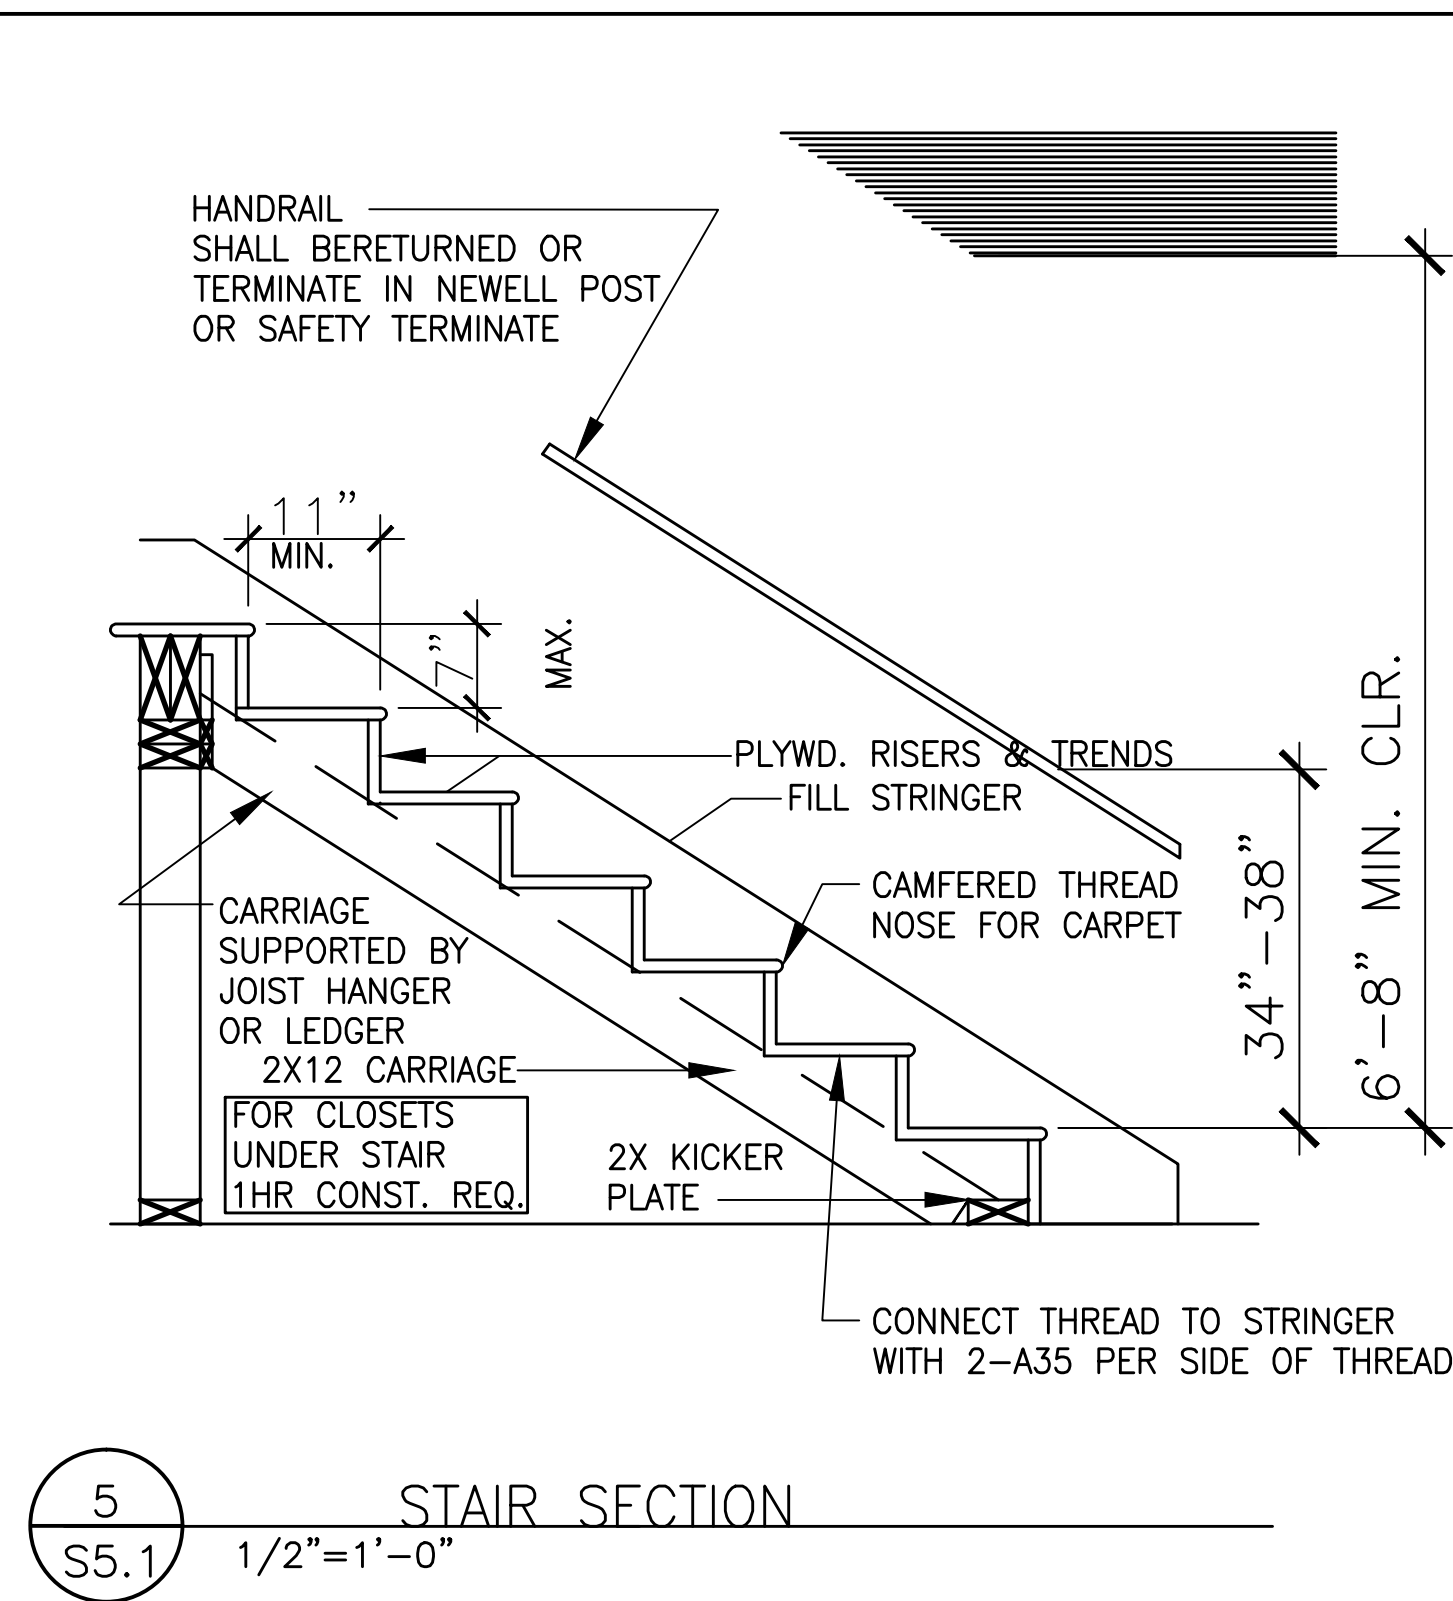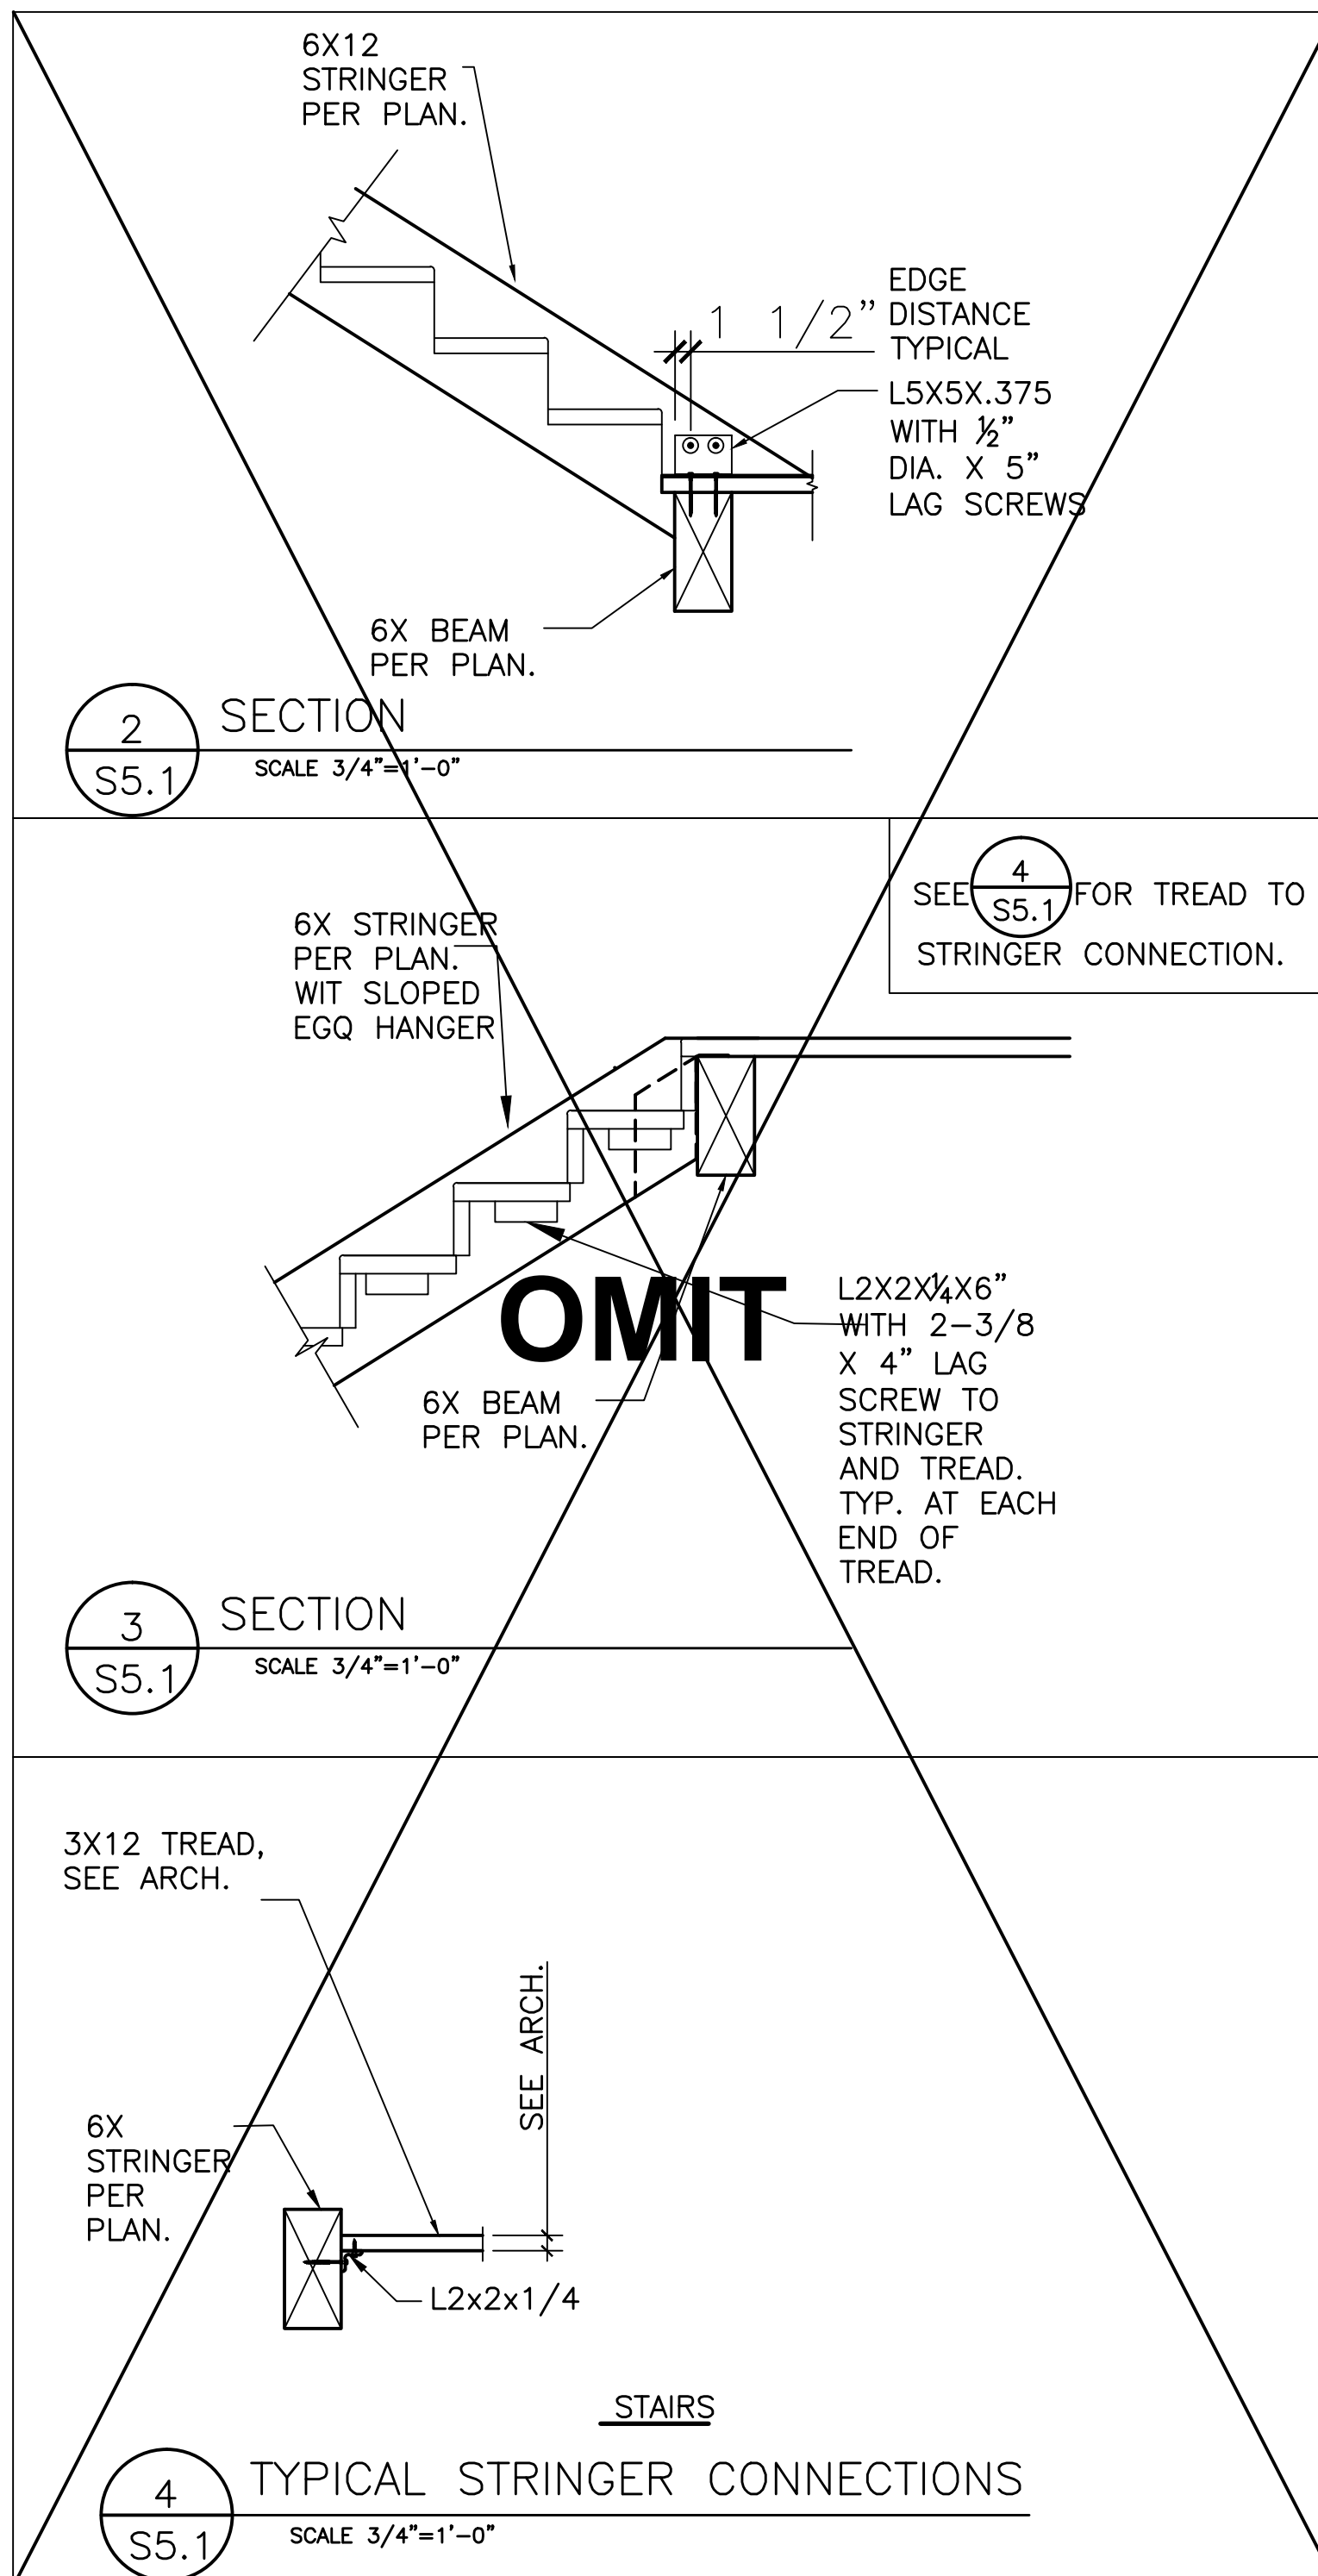

HAND RAIL DETAIL


6 S5.1  
STAIR SECTION

- 1 PLYWD SUBFLOOR
- 2 3/4" PLYWOOD RISERS
- 3 2X12 STRINGERS (MIN 3)
- 4 DBL FLOOR JOIST OR HEADER
- 5 SIMPSON THA213 TRUSS HANGER
- 6 1-1/8" PLYWOOD OR 2X12 THREADS

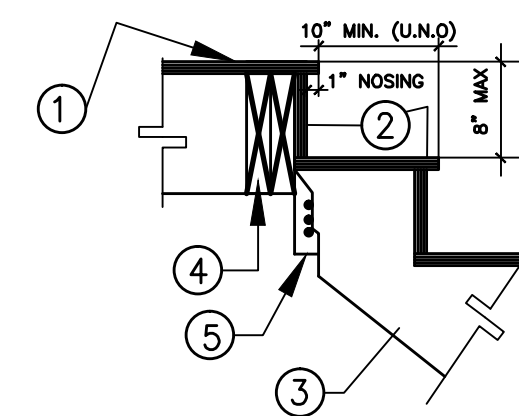

STRINGER @ HEADER


7 S5.1  
STAIR SECTION  
1/2"=1'-0"

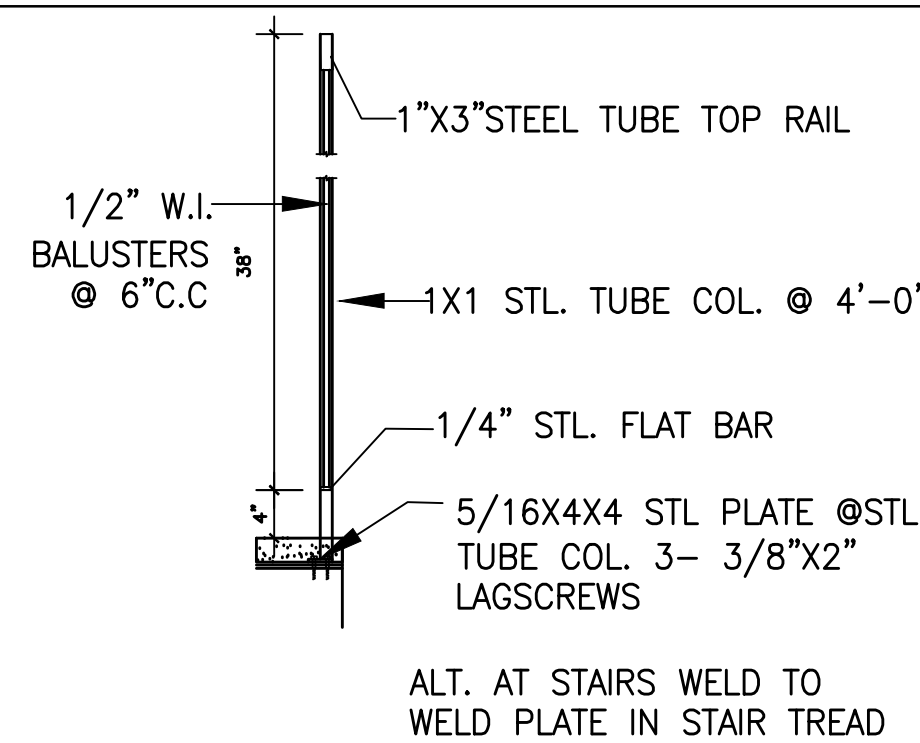


RAILING

8 S5.1  
STAIR SECTION  
1/2"=1'-0"

- 1 PLYWD SUBFLOOR
- 2 3/4" PLYWOOD RISERS
- 3 2X12 STRINGERS (MIN 3)
- 4 5/8" TYPE "X" G.B. (WHEN REQ'D)
- 5 DBL FLOOR JOIST OR HEADER
- 6 2X CRIPPLE WALL
- 7 1/2" GYP BD
- 8 4X HDR OR WALL WHERE OCCURS
- 9 SIMPSON THA213 TRUSS HGR
- 10 1-1/8" PLYWOOD OR 2X12 THREADS CONNECT THREAD TO STRINGER WITH 2-A35 PER SIDE OF THREAD

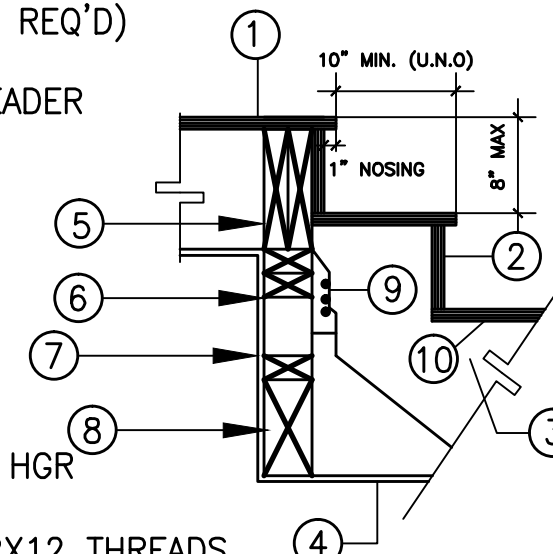

9 S5.1  
STAIR SECTION  
1/2"=1'-0"

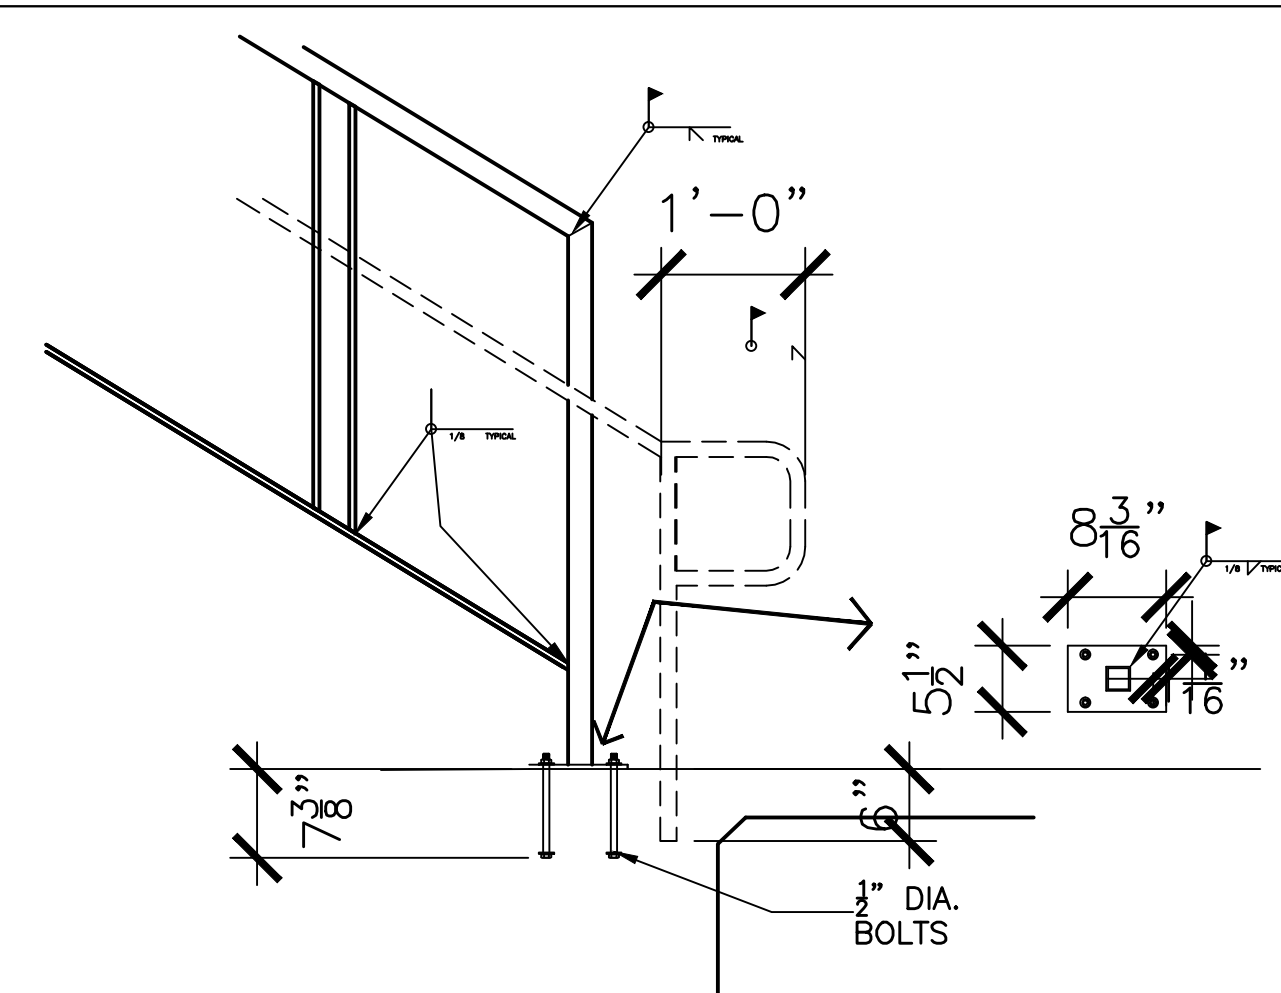

10 S5.1  
STAIR SECTION  
1/2"=1'-0"

REVISIONS	BY
9/26/2011 - PLAN CHECK	G.O.




**OAKLEY & OAKLEY**  
ARCHITECTURAL & STRUCTURAL ENGINEERS  
909 PORTER STREET, VALLEJO, CA 94560  
TEL: 925-266-6621 FAX: 925-266-6043

PROJECT TITLE:  
**COMMUNITY CENTER**  
HARBOR PARK APARTMENTS  
969 PORTER STREET, VALLEJO, CA 94560  
DRAWING TITLE:  
**STEEL FRAMING DETAILS**


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Job No.: 2011-09

Sheet:  
**S5.1**  
Of Sheets

Jan 27, 2014 - 11:29pm \\SERVER\Server Drive D\Year 2011 Jobs\2011-09-3 - Community Bldg\REVISED DRAWINGS FOR NEGOTIATED CONTRACT WITH VE LYONS\STRUCTURAL\S61.dwg

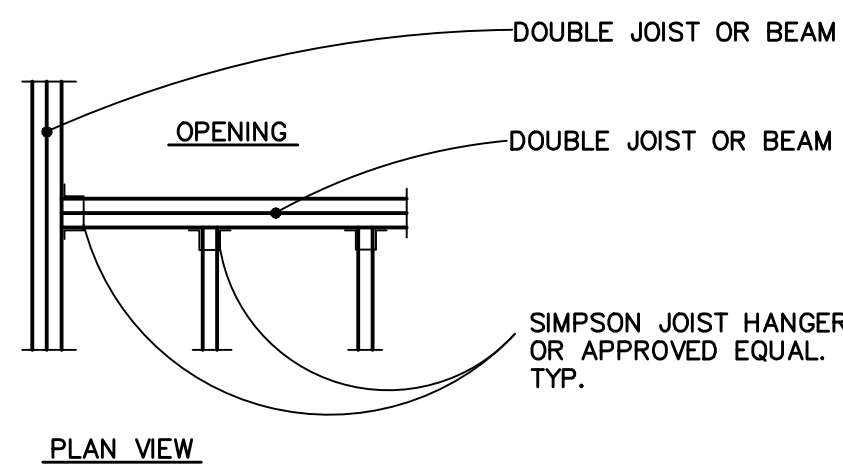


31 TYP. JOIST/RAFTER FRAMING @ OPENING  
NOT TO SCALE

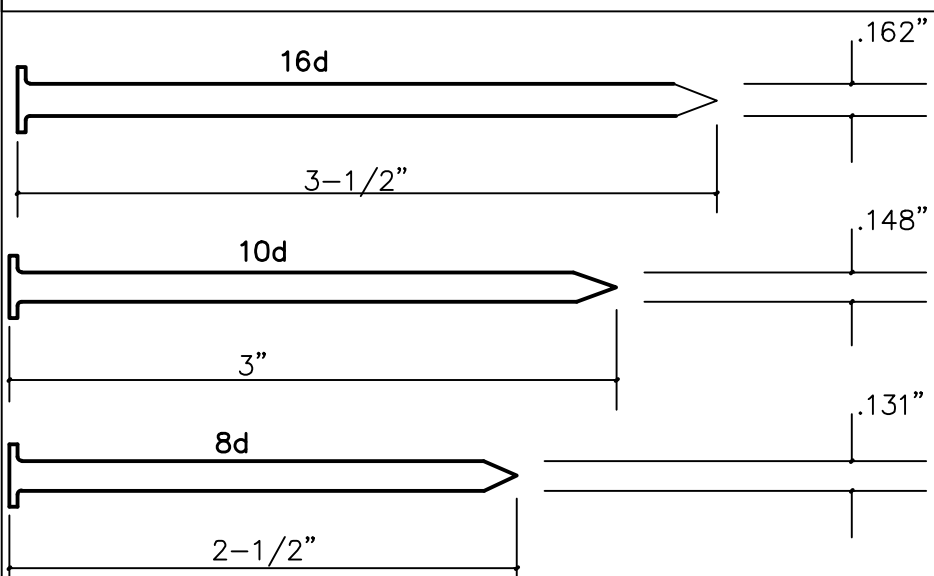

NOTE: IF NAILING @ DIAPHRAGM IS DONE USING POWER DRIVEN FASTENERS USE HILTI OR EQ.-POWER DRIVEN FASTENERS ARE NOT RECOMMENDED FOR SMALL ALTERATION WORK; TOE, SLANT OR END NAILING-USE FULL HEAD NAILS ONLY.

37 FULL SCALE COMMON NAILS  
FULL SIZE

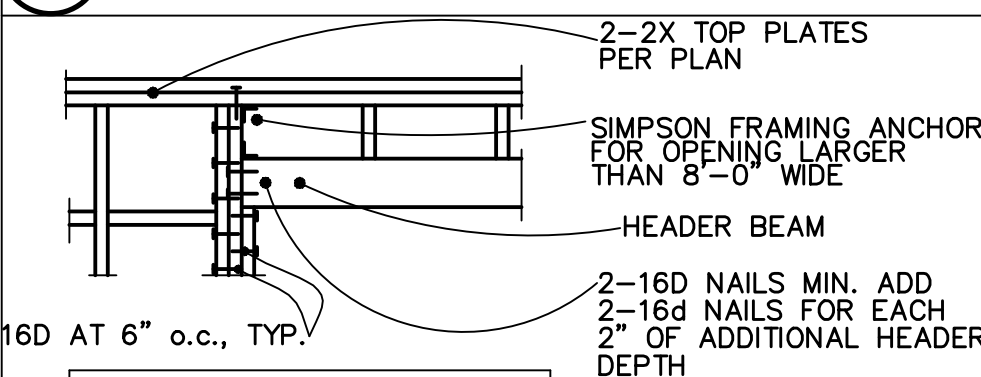


HEADER SCHEDULE			
SIZE	MAX. OPENING	SIZE	MAX. OPENING
6X12	4'-0"	6X12	10'-0"
6X12	6'-0"	6X14	12'-0"
6X12	8'-0"		


NOTE: WHERE 6" STUDS ARE USED, USE 6X HEADER.

NOTE: PROVIDE 2X HORIZ. SOLID BLK'G STUDS @ 8'-0" MAX. ALSO PROVIDE 2X FIRE BLK'G @ CEILING LINE AS REQ'D.


43 TYP. FRAMING AT STUD WALL OPENING  
NOT TO SCALE

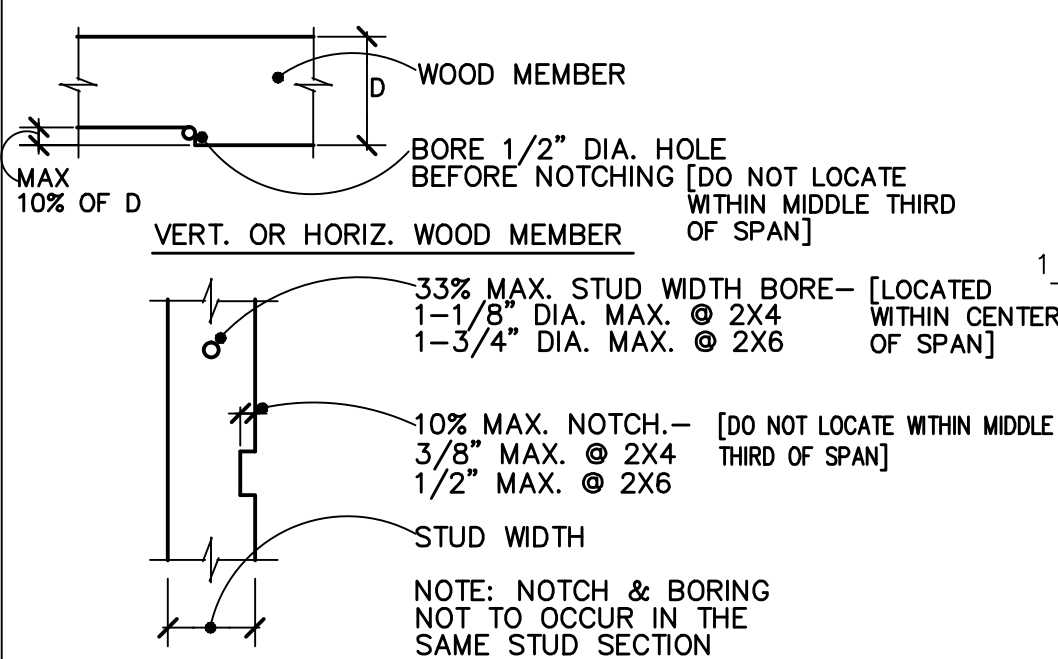

49 NOTCHING & BORING OF STUDS/BEAMS  
NOT TO SCALE

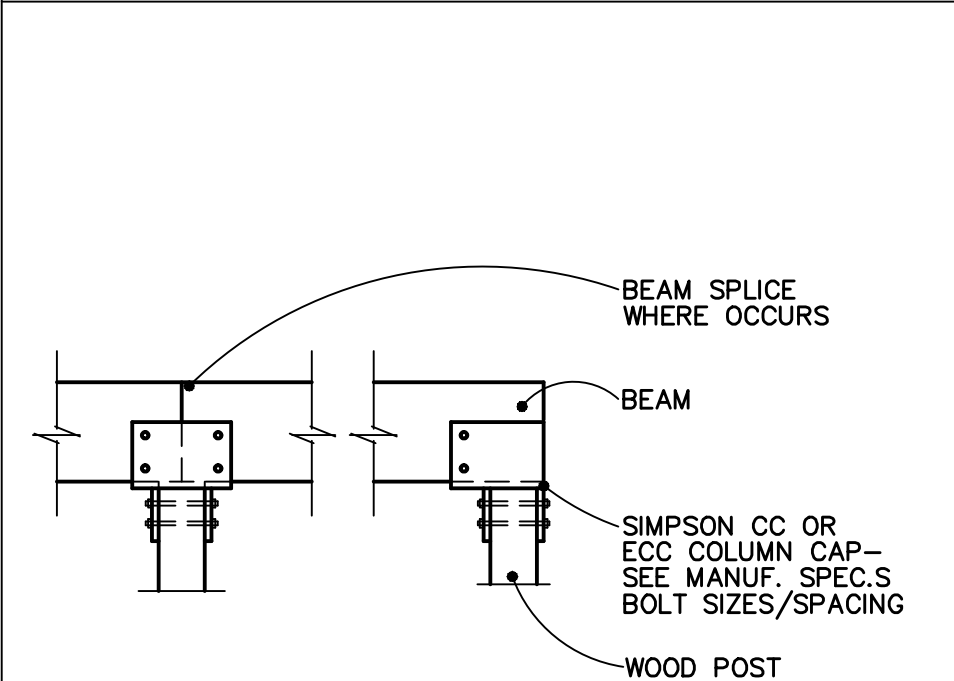


55 TYP. POST TO BEAM  
NOT TO SCALE

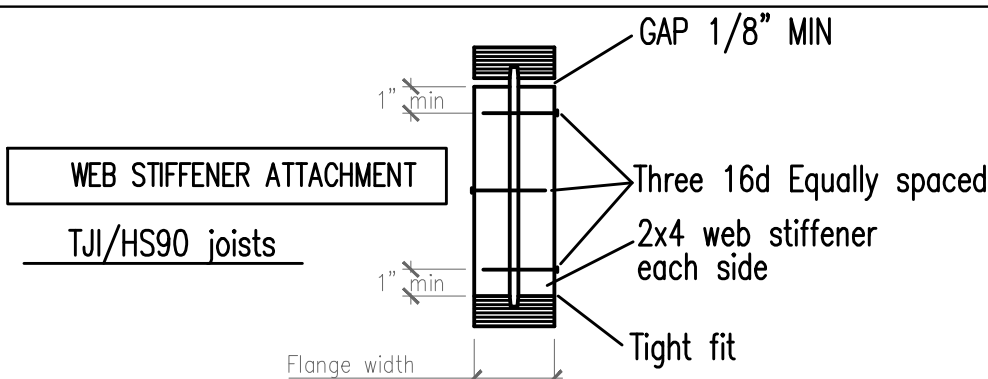


(1) Web stiffener material shall be sheathing meeting the requirements of PS 1 or PS 2 with face grain vertical.  
(2) 2x4 construction grade or better.


30 TJI WEB STIFFENER DETAIL

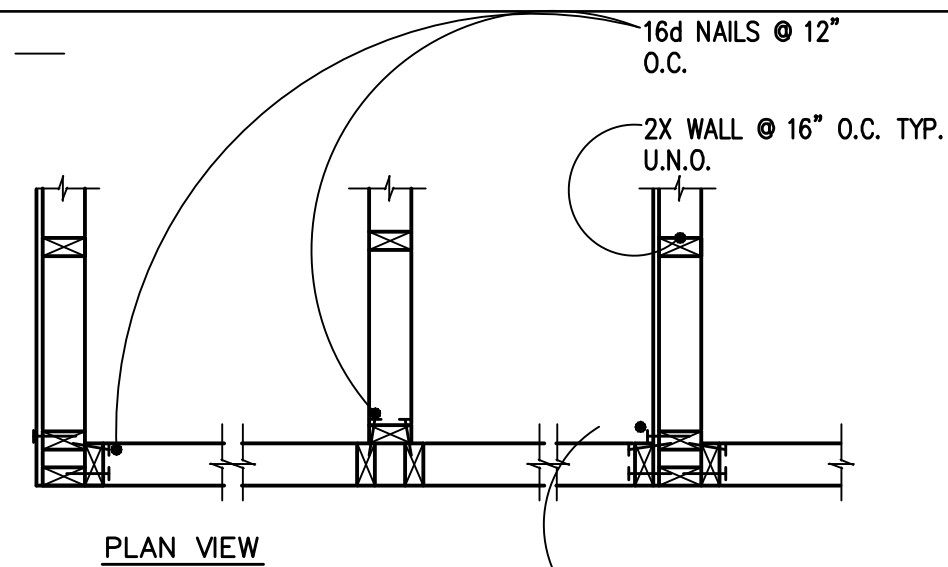


36 TYPICAL STUD WALL CONNECTIONS  
NOT TO SCALE

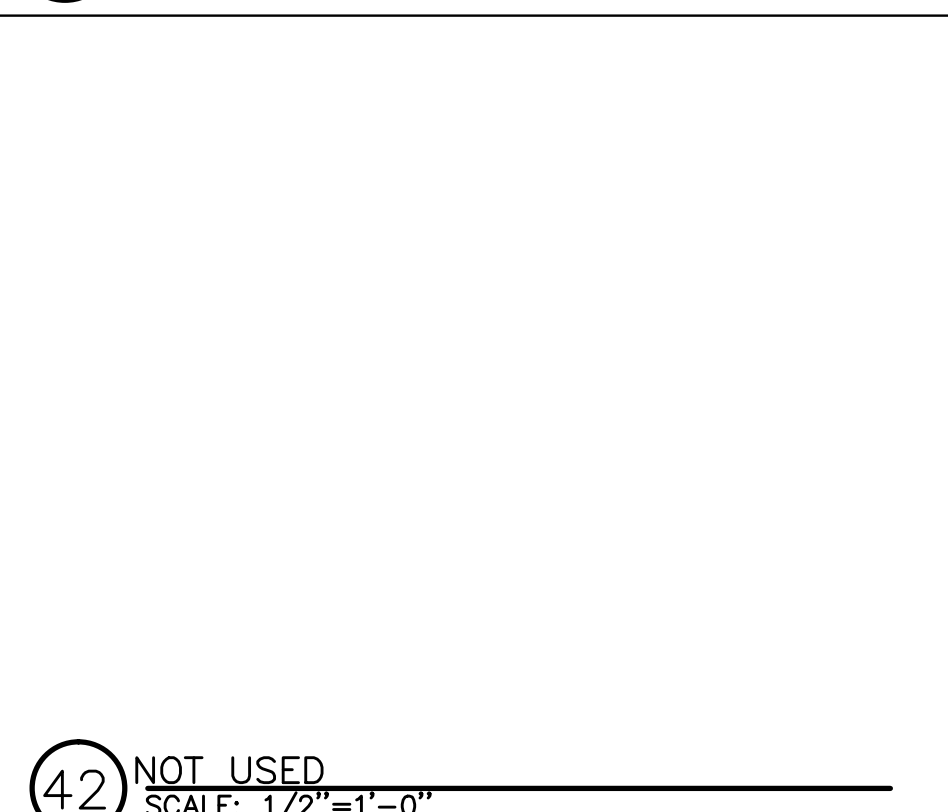

42 NOT USED  
SCALE: 1/2"=1'-0"

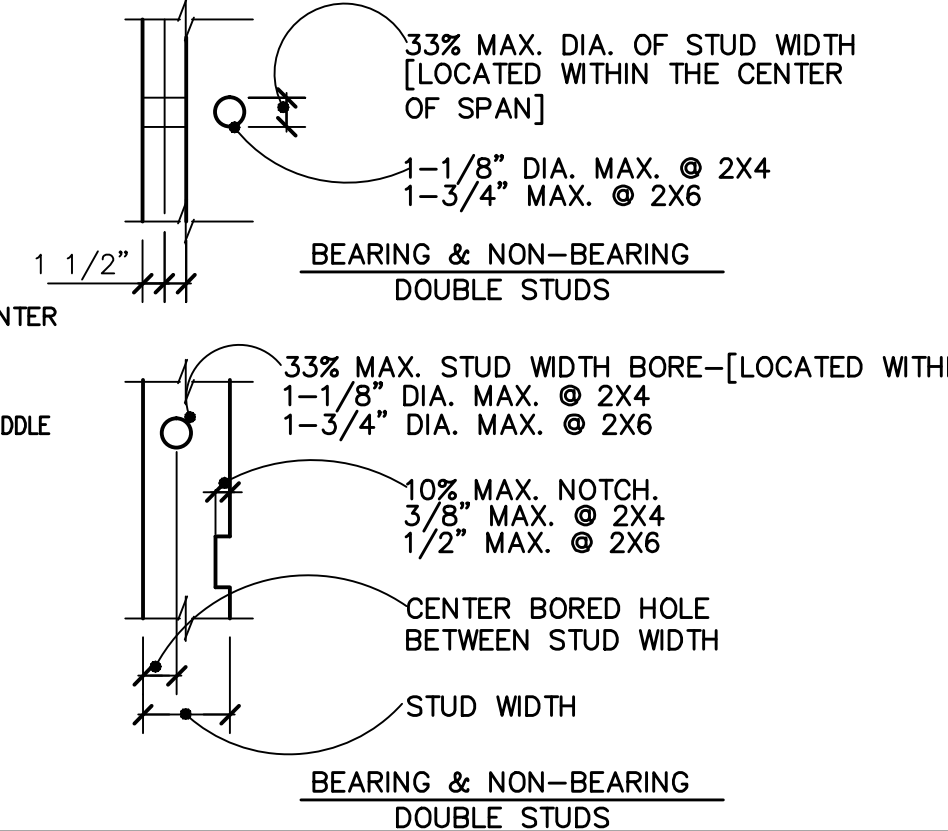


47 HOLDOWN AT DISCONTINUOUS SHEAR WALL  
NOT TO SCALE

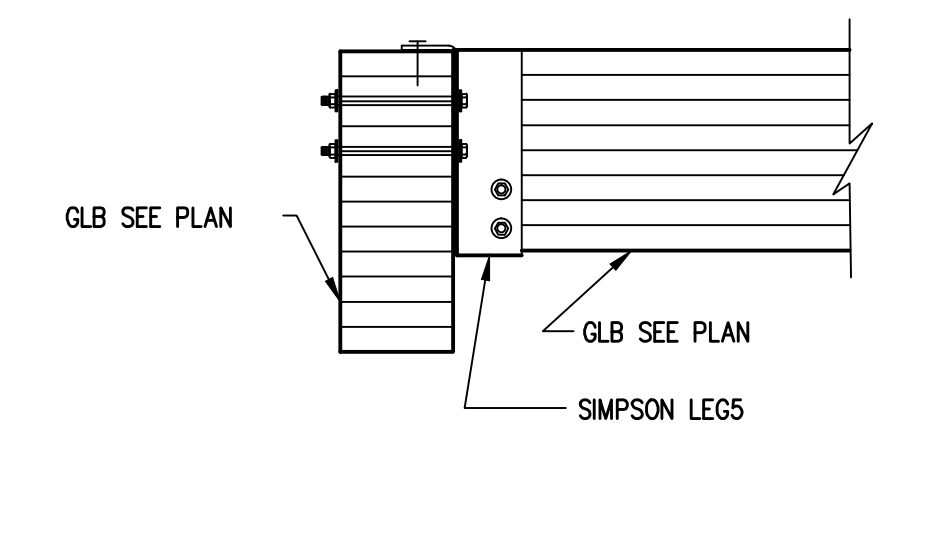


54 GLB TO GLB CONNECTION  
NOT TO SCALE


29 NOT USED  
NOT TO SCALE

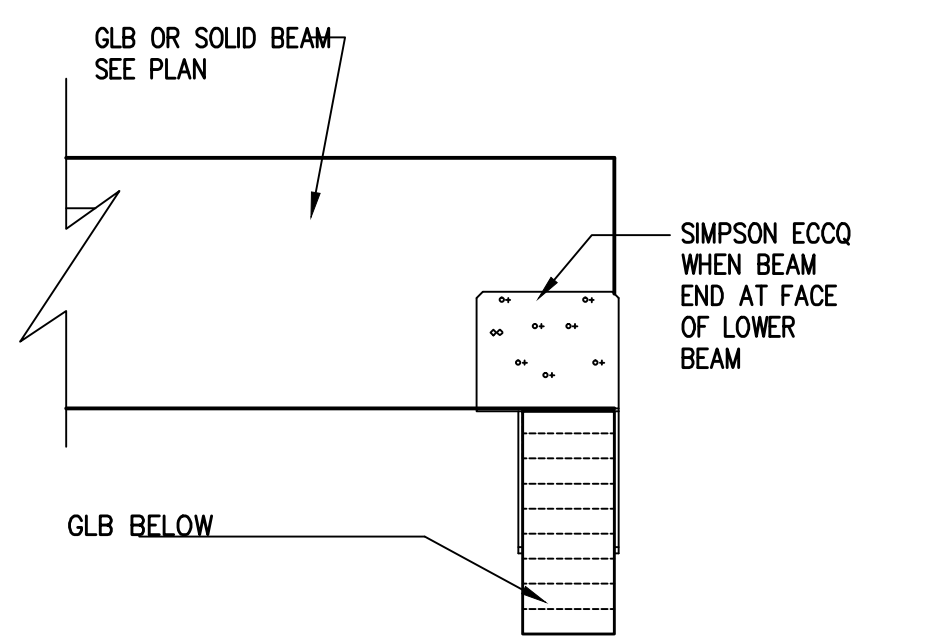


35 TYPICAL BEAM CONNECTIONS  
NOT TO SCALE

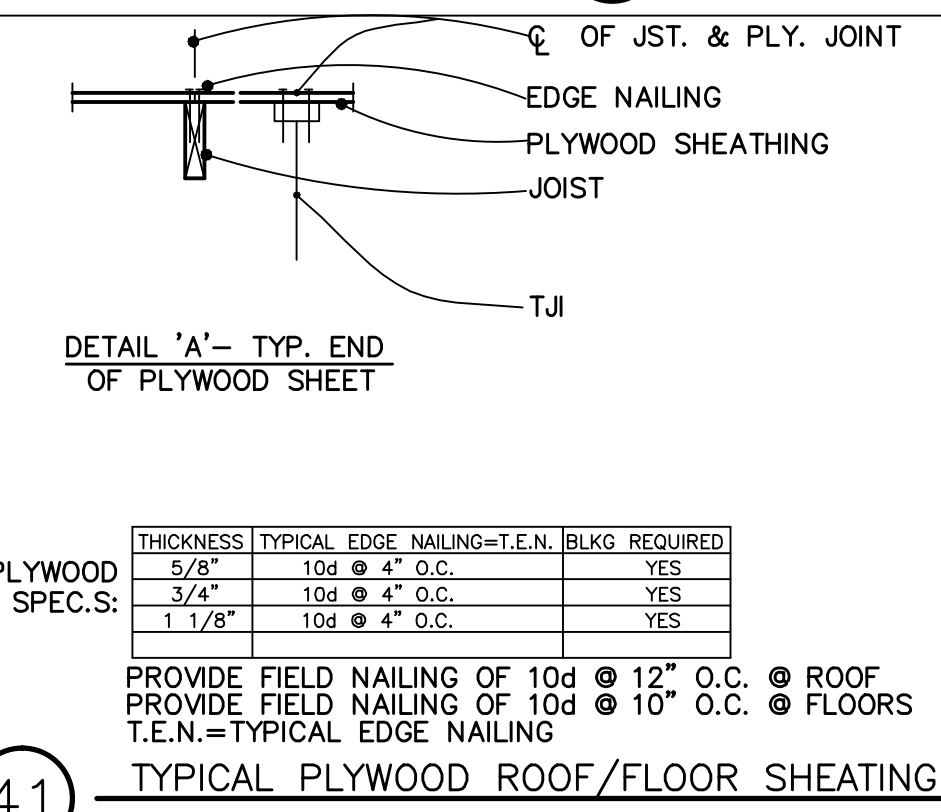

41 TYPICAL PLYWOOD ROOF/FLOOR SHEATING  
NOT TO SCALE

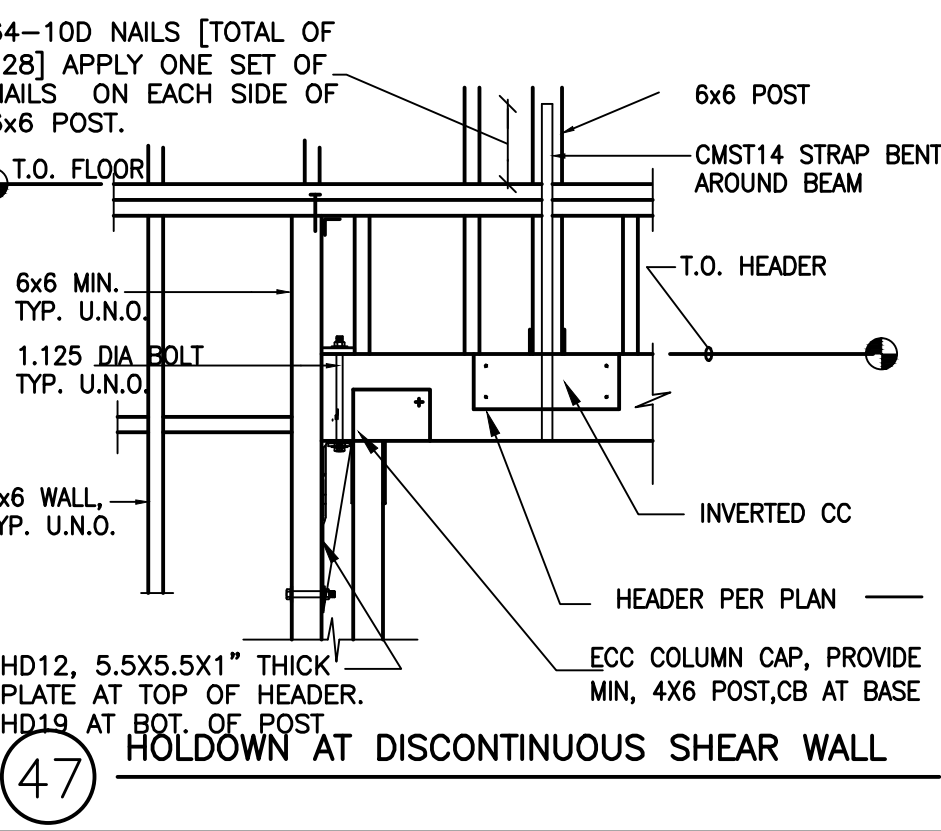


46 TYPICAL GLULAM BEAM LAMINATION DETAIL  
NOT TO SCALE

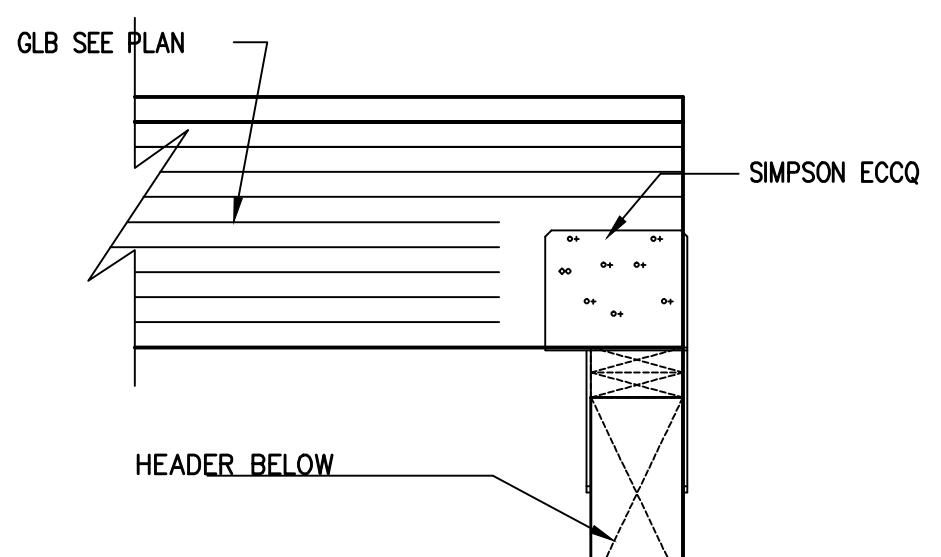


53 GLB TO HEADER  
NOT TO SCALE


28 NOT USED  
NOT TO SCALE

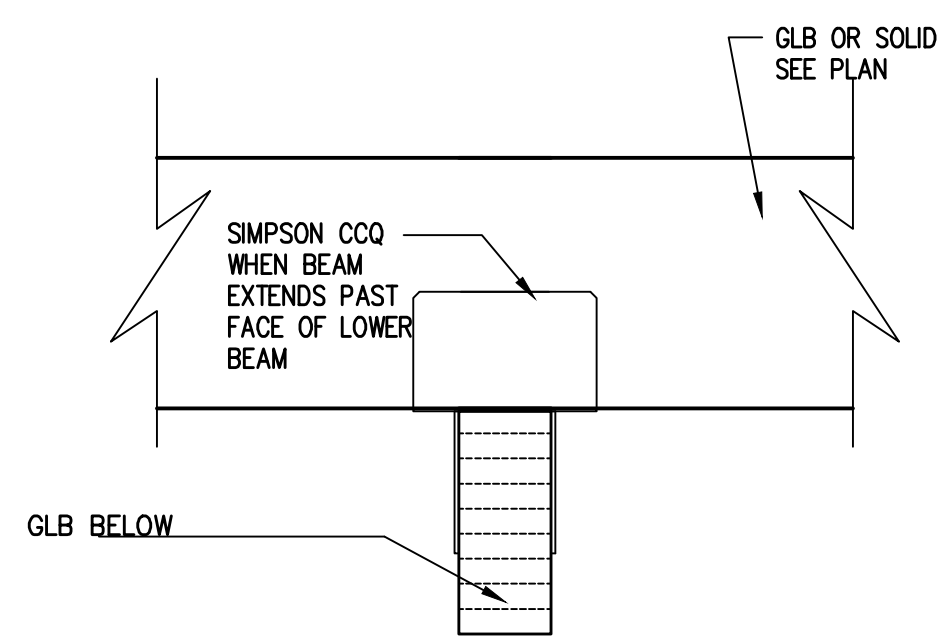


34 CALIFORNIA (OVER) FRAMING  
NOT TO SCALE

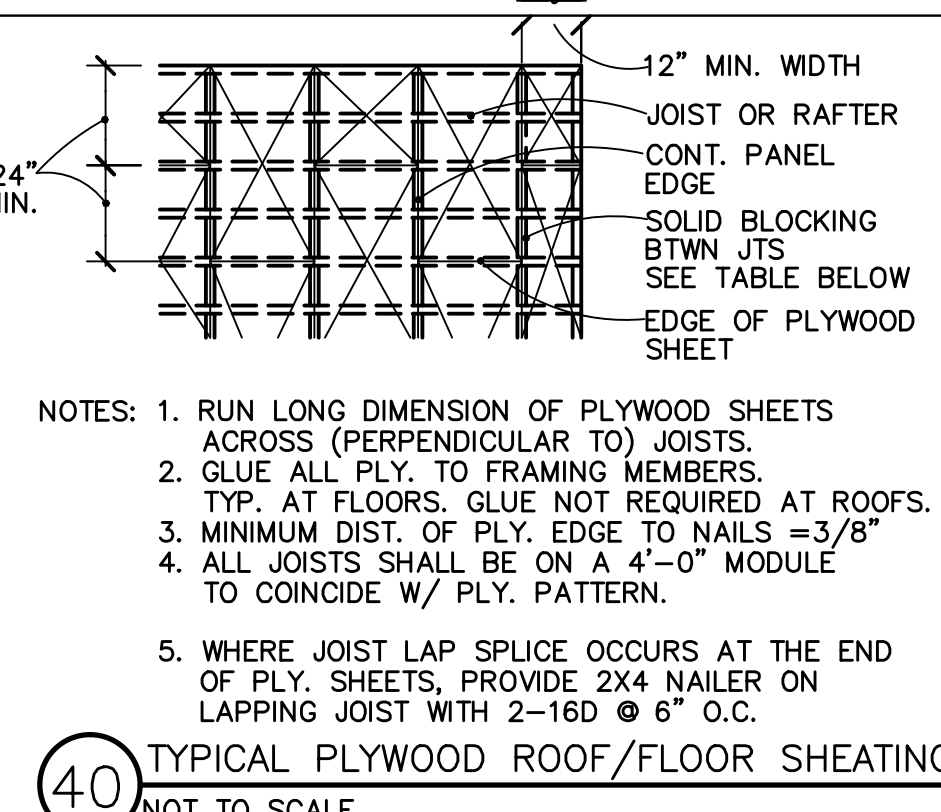


40 TYPICAL PLYWOOD ROOF/FLOOR SHEATING  
NOT TO SCALE

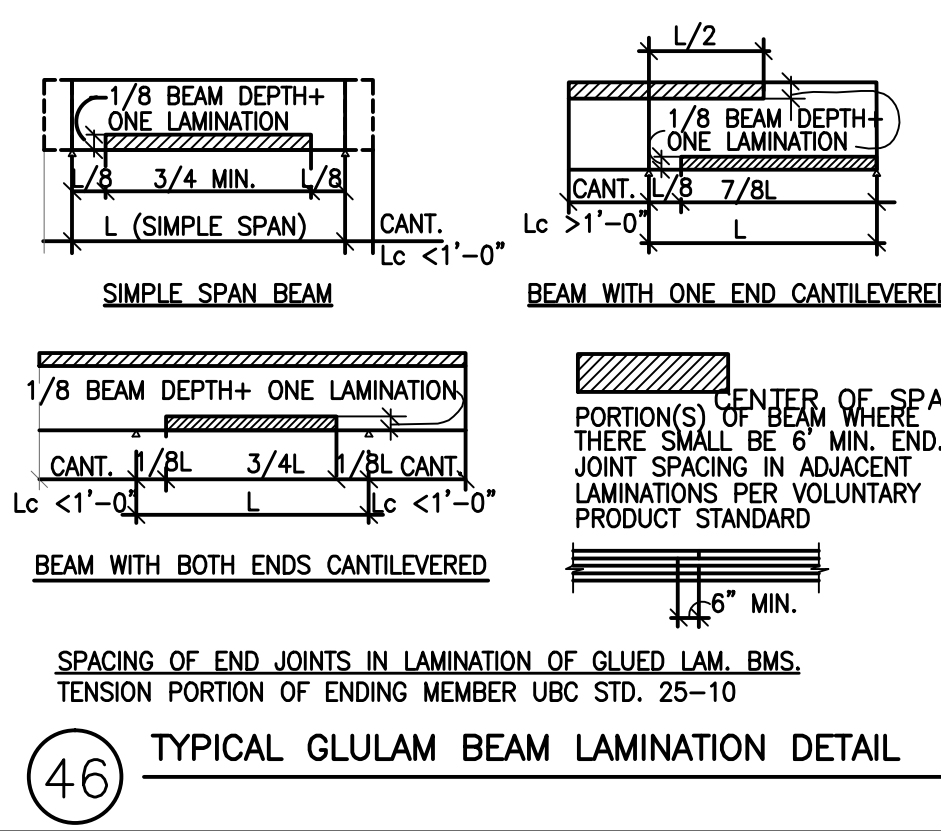


45 SHEAR WALL CONFIGURATIONS  
NOT TO SCALE - SEE 4/SDET6.8

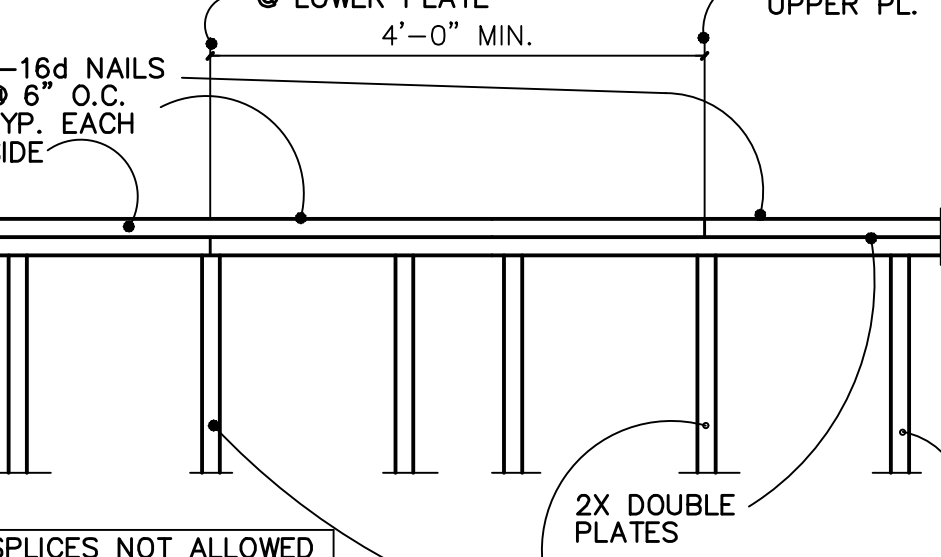


52 TYPICAL MINIMUM PLATE SPLICE (U.N.O.)  
NOT TO SCALE  
SEE DETAIL 1A/S6.2 FOR SPLICES AT PLATES AT SHEAR WALLS

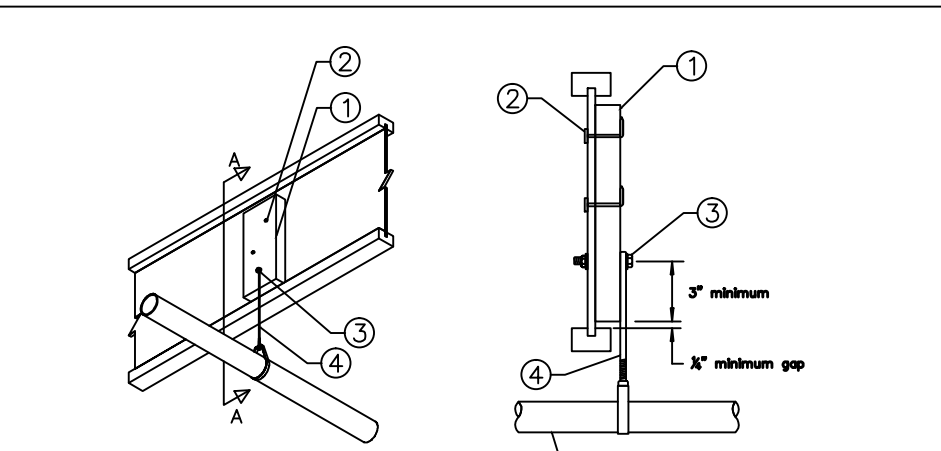


27 Pipe/Duct Support at maximum hanger spacing: 30" o.c.  
NOT TO SCALE

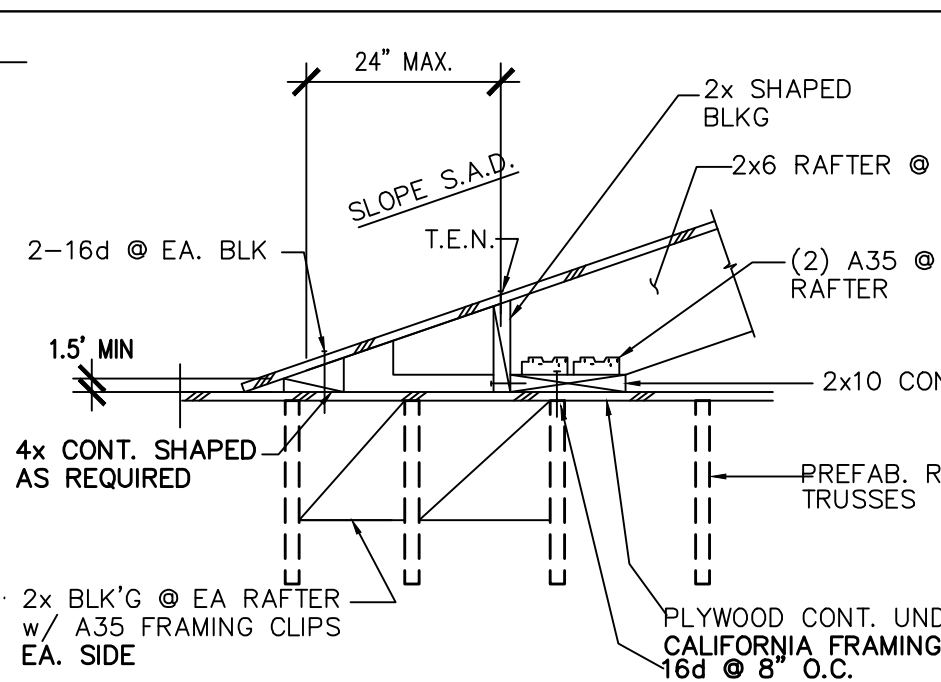


33 HVAC PLATFORM  
NOT TO SCALE

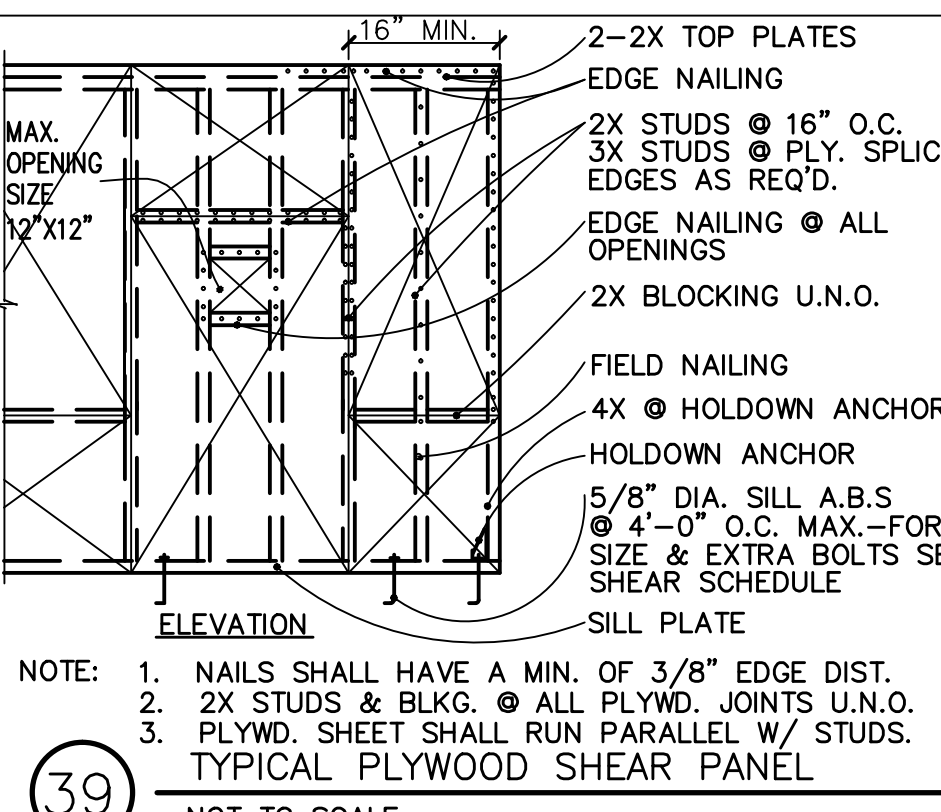


39 TYPICAL PLYWOOD SHEAR PANEL  
NOT TO SCALE

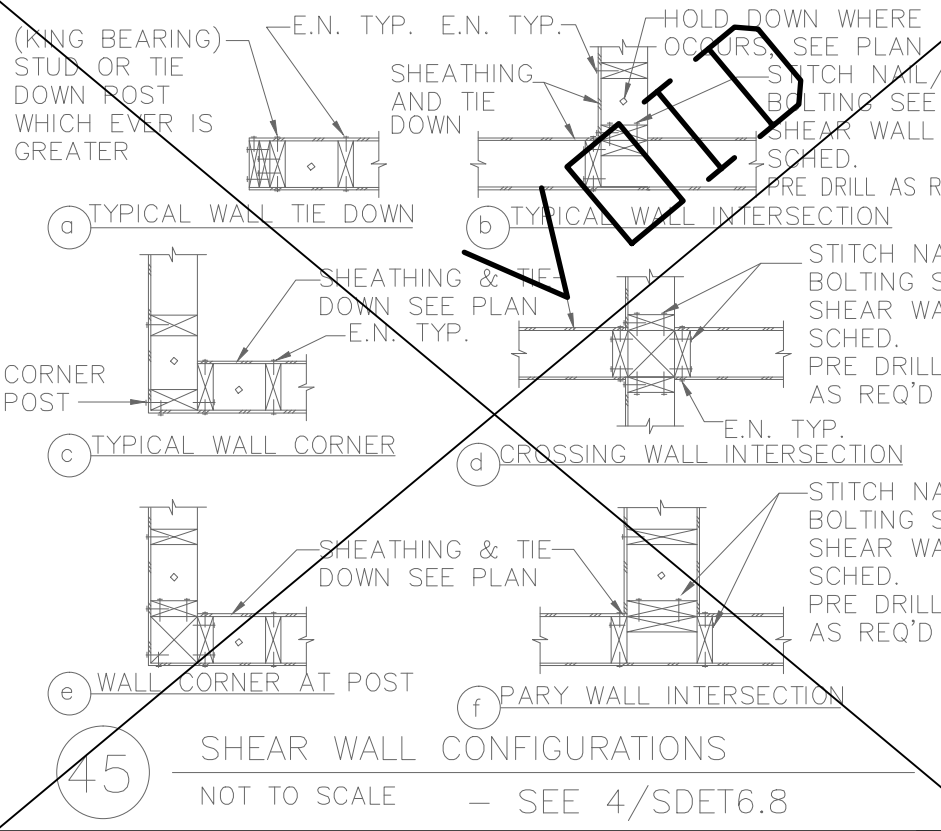


44 TYP. FRAMING AT STUD WALL OPENING  
NOT TO SCALE

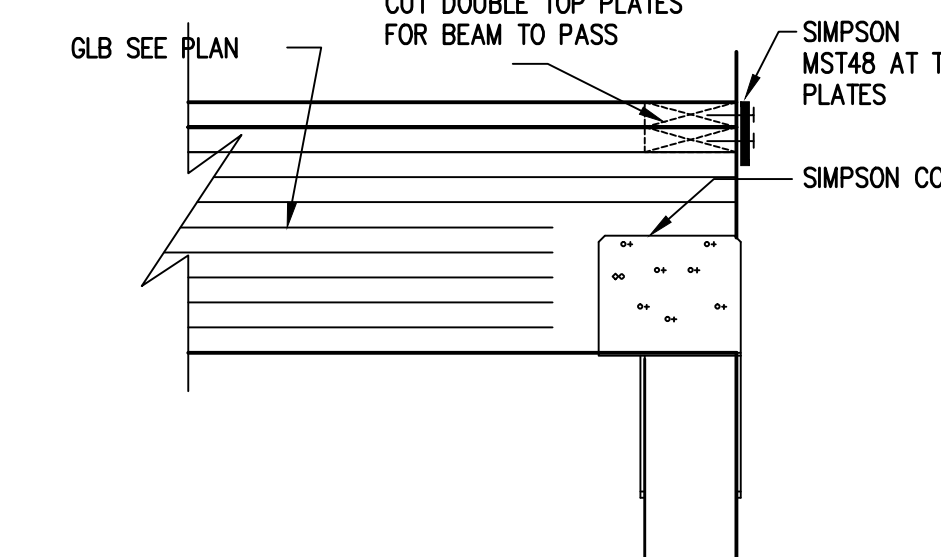


51 TYPICAL GLB TO POST AT WALLS  
NOT TO SCALE

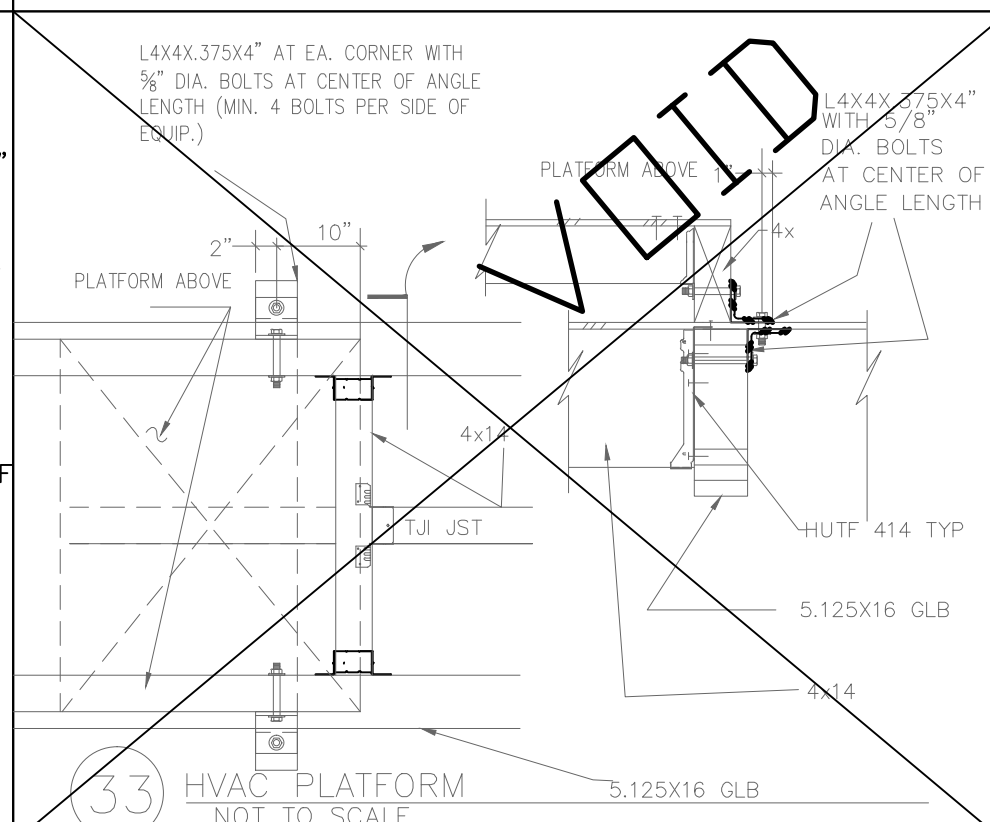


33 HVAC PLATFORM  
NOT TO SCALE

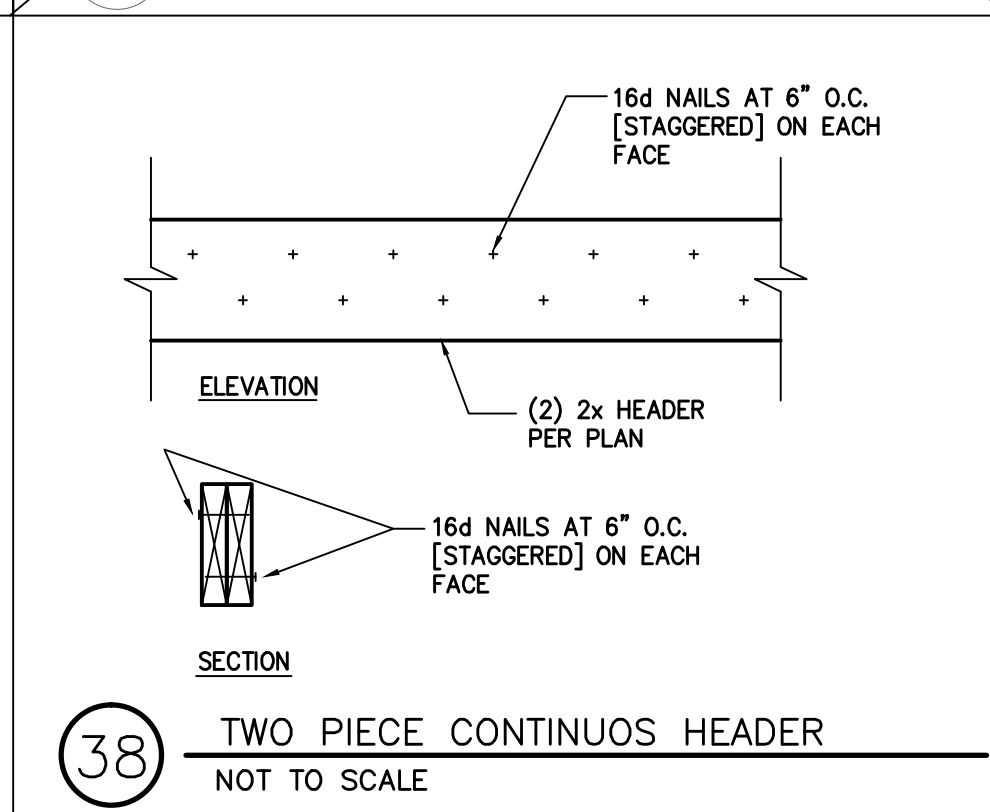

38 TWO PIECE CONTINUOUS HEADER  
NOT TO SCALE

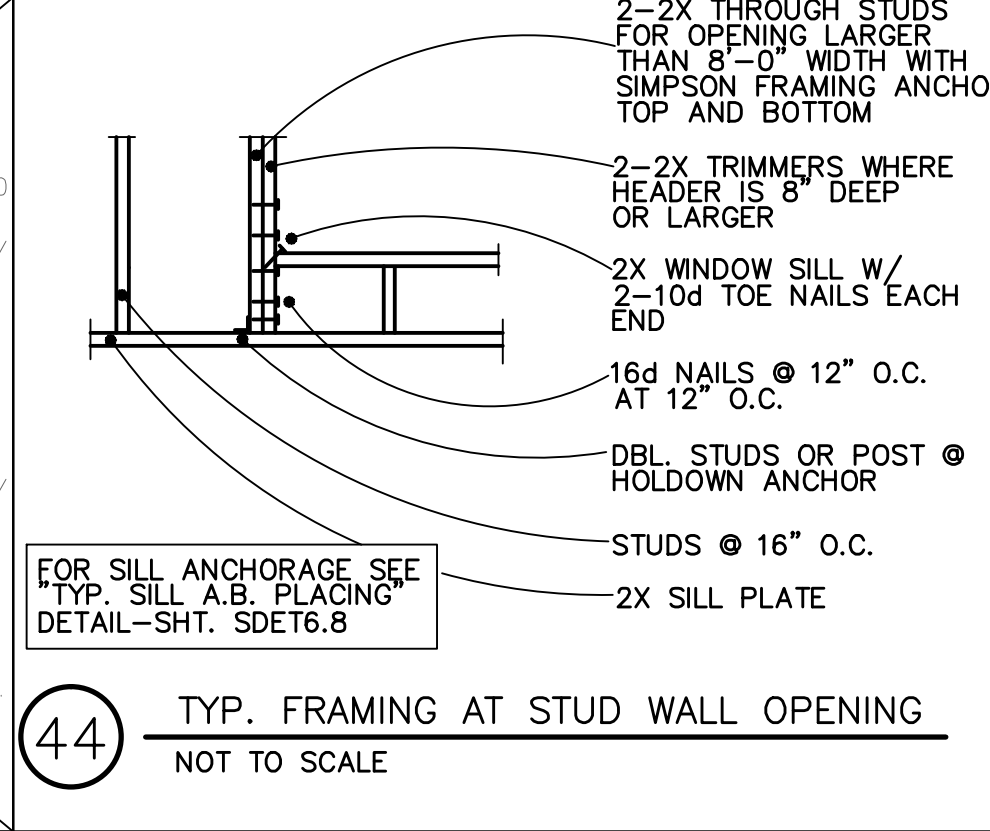


44 TYP. FRAMING AT STUD WALL OPENING  
NOT TO SCALE

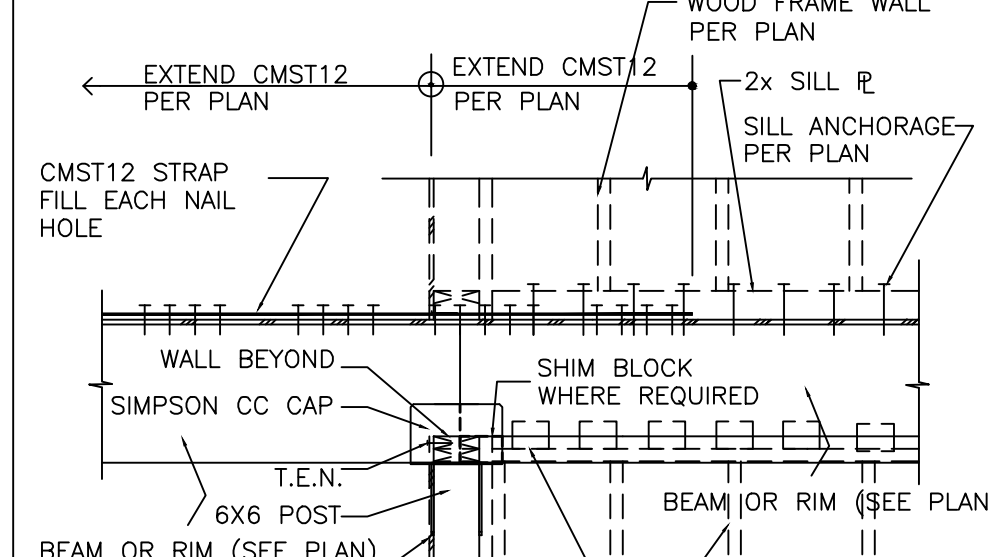

50 SECTION  
NOT TO SCALE-HOLDOWNS NOT SHOWN

REVISIONS	BY
9/26/2011 - PLAN CHECK	G.O.

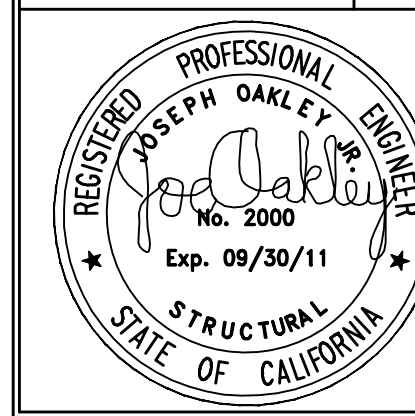


ARCHITECTURAL & STRUCTURAL ENGINEERS  
OAKLEY & OAKLEY  
969 PORTER STREET, VALLEJO, CA 94560  
TEL: 925.936.6043 FAX: 925.936.6043

PROJECT TITLE:  
COMMUNITY CENTER  
HARBOR PARK APARTMENTS  
969 PORTER STREET, VALLEJO, CA 94560  
DRAWING TITLE:  
TYPICAL WOOD FRAMING DETAILS



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Scale:	AS NOTED
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Checked:	RY
Job No.:	2011-09
Sheet:	

S6.1  
Of Sheets



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
3A TYPICAL SHEARWALL DETAIL-WALL PERPENDICULAR TO TRUSSES  
SCALE 3/4"=1'-0"

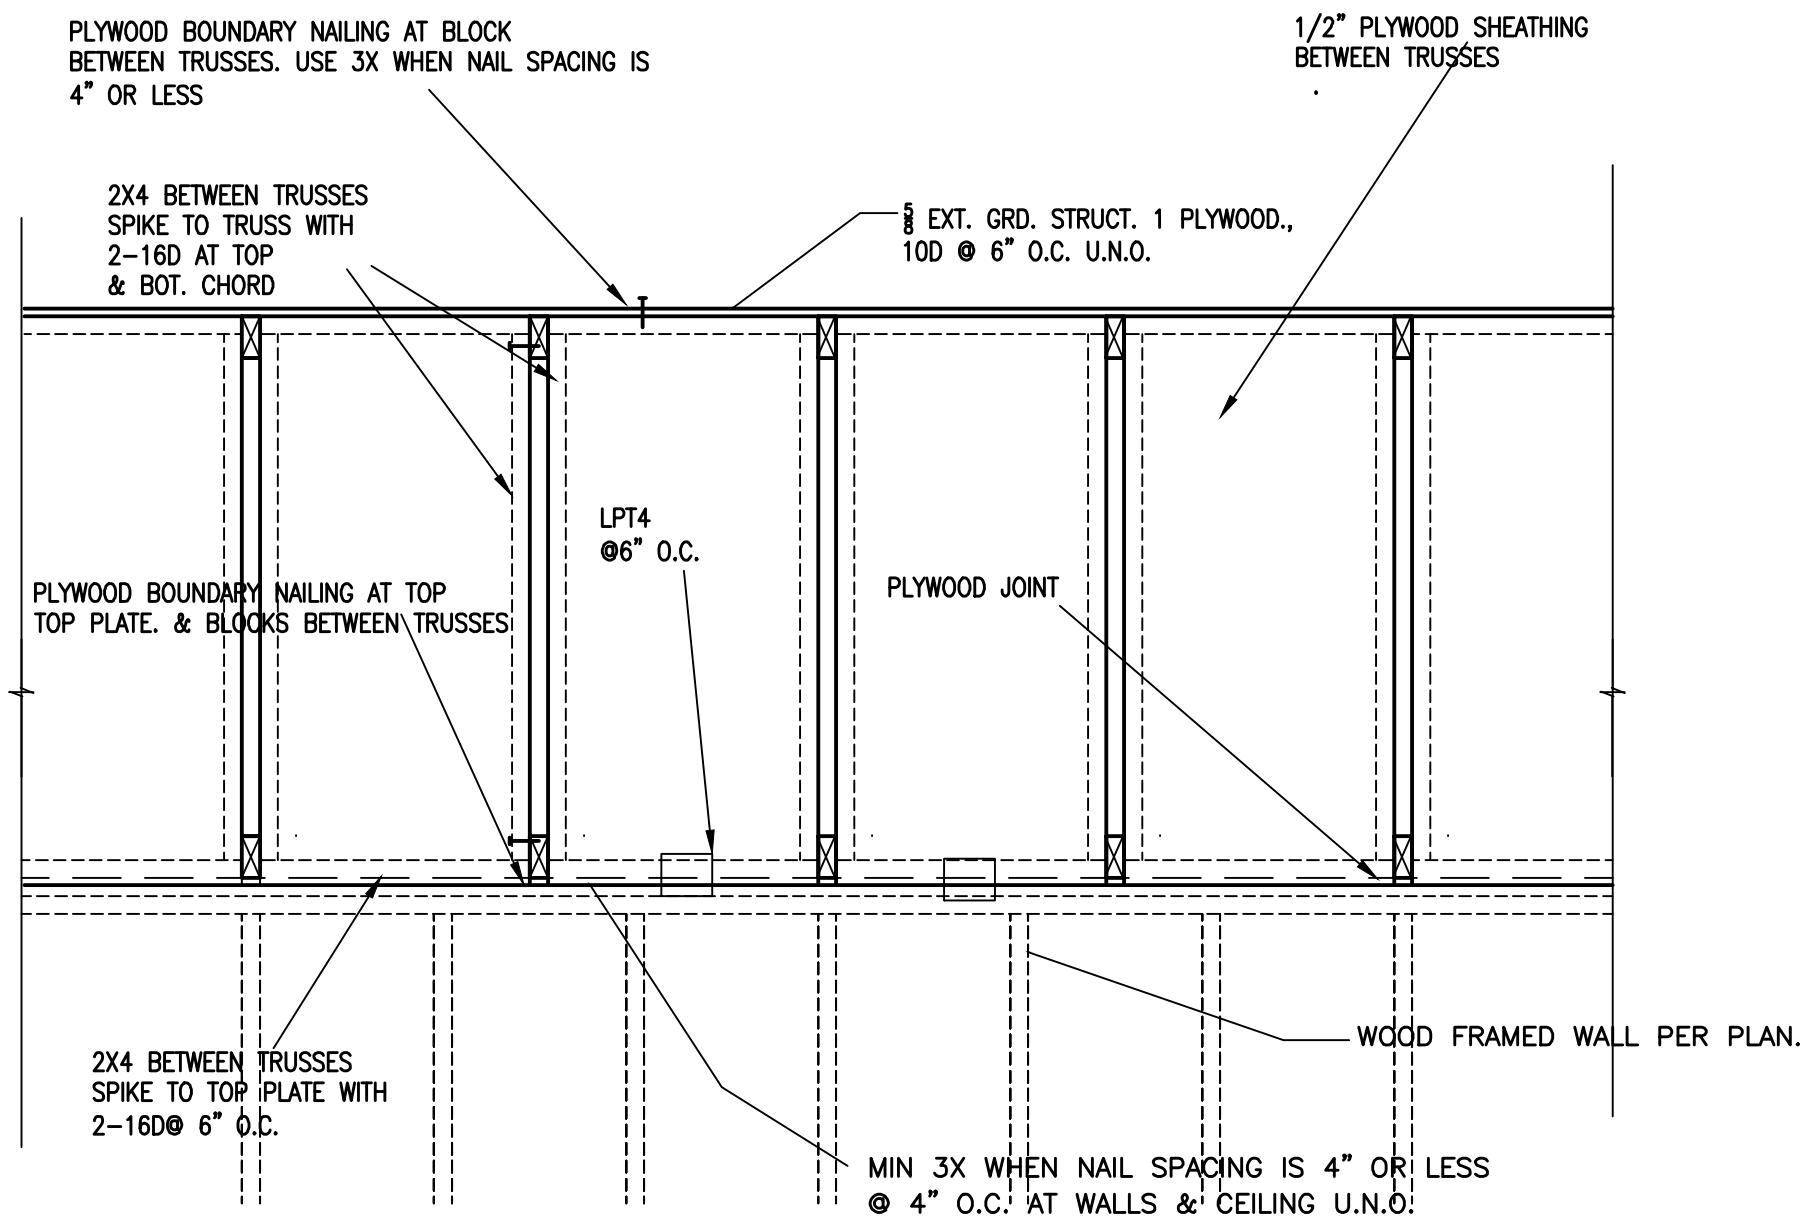

5 TYP SECTIONS - WALL INTERSECTIONS

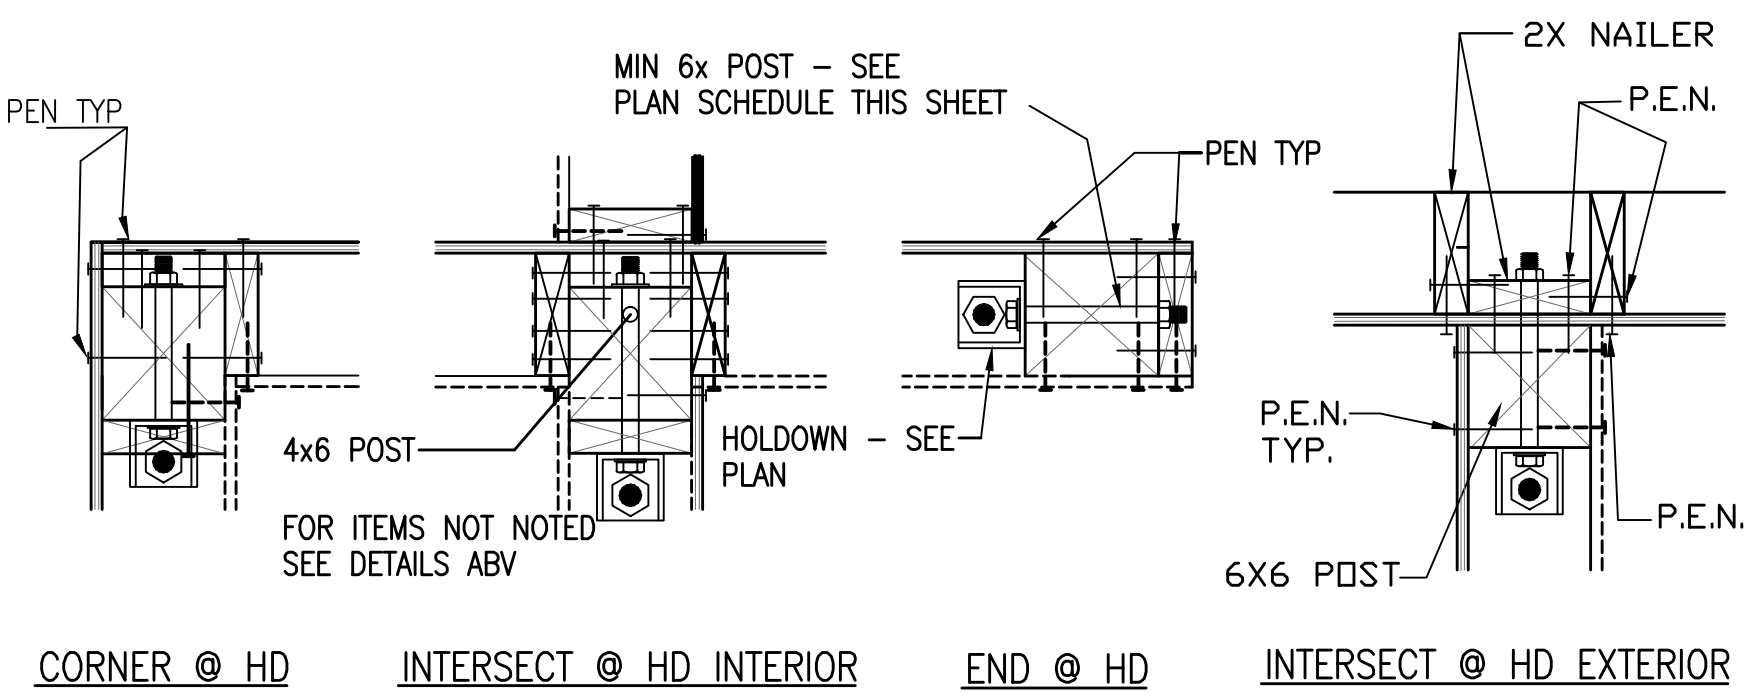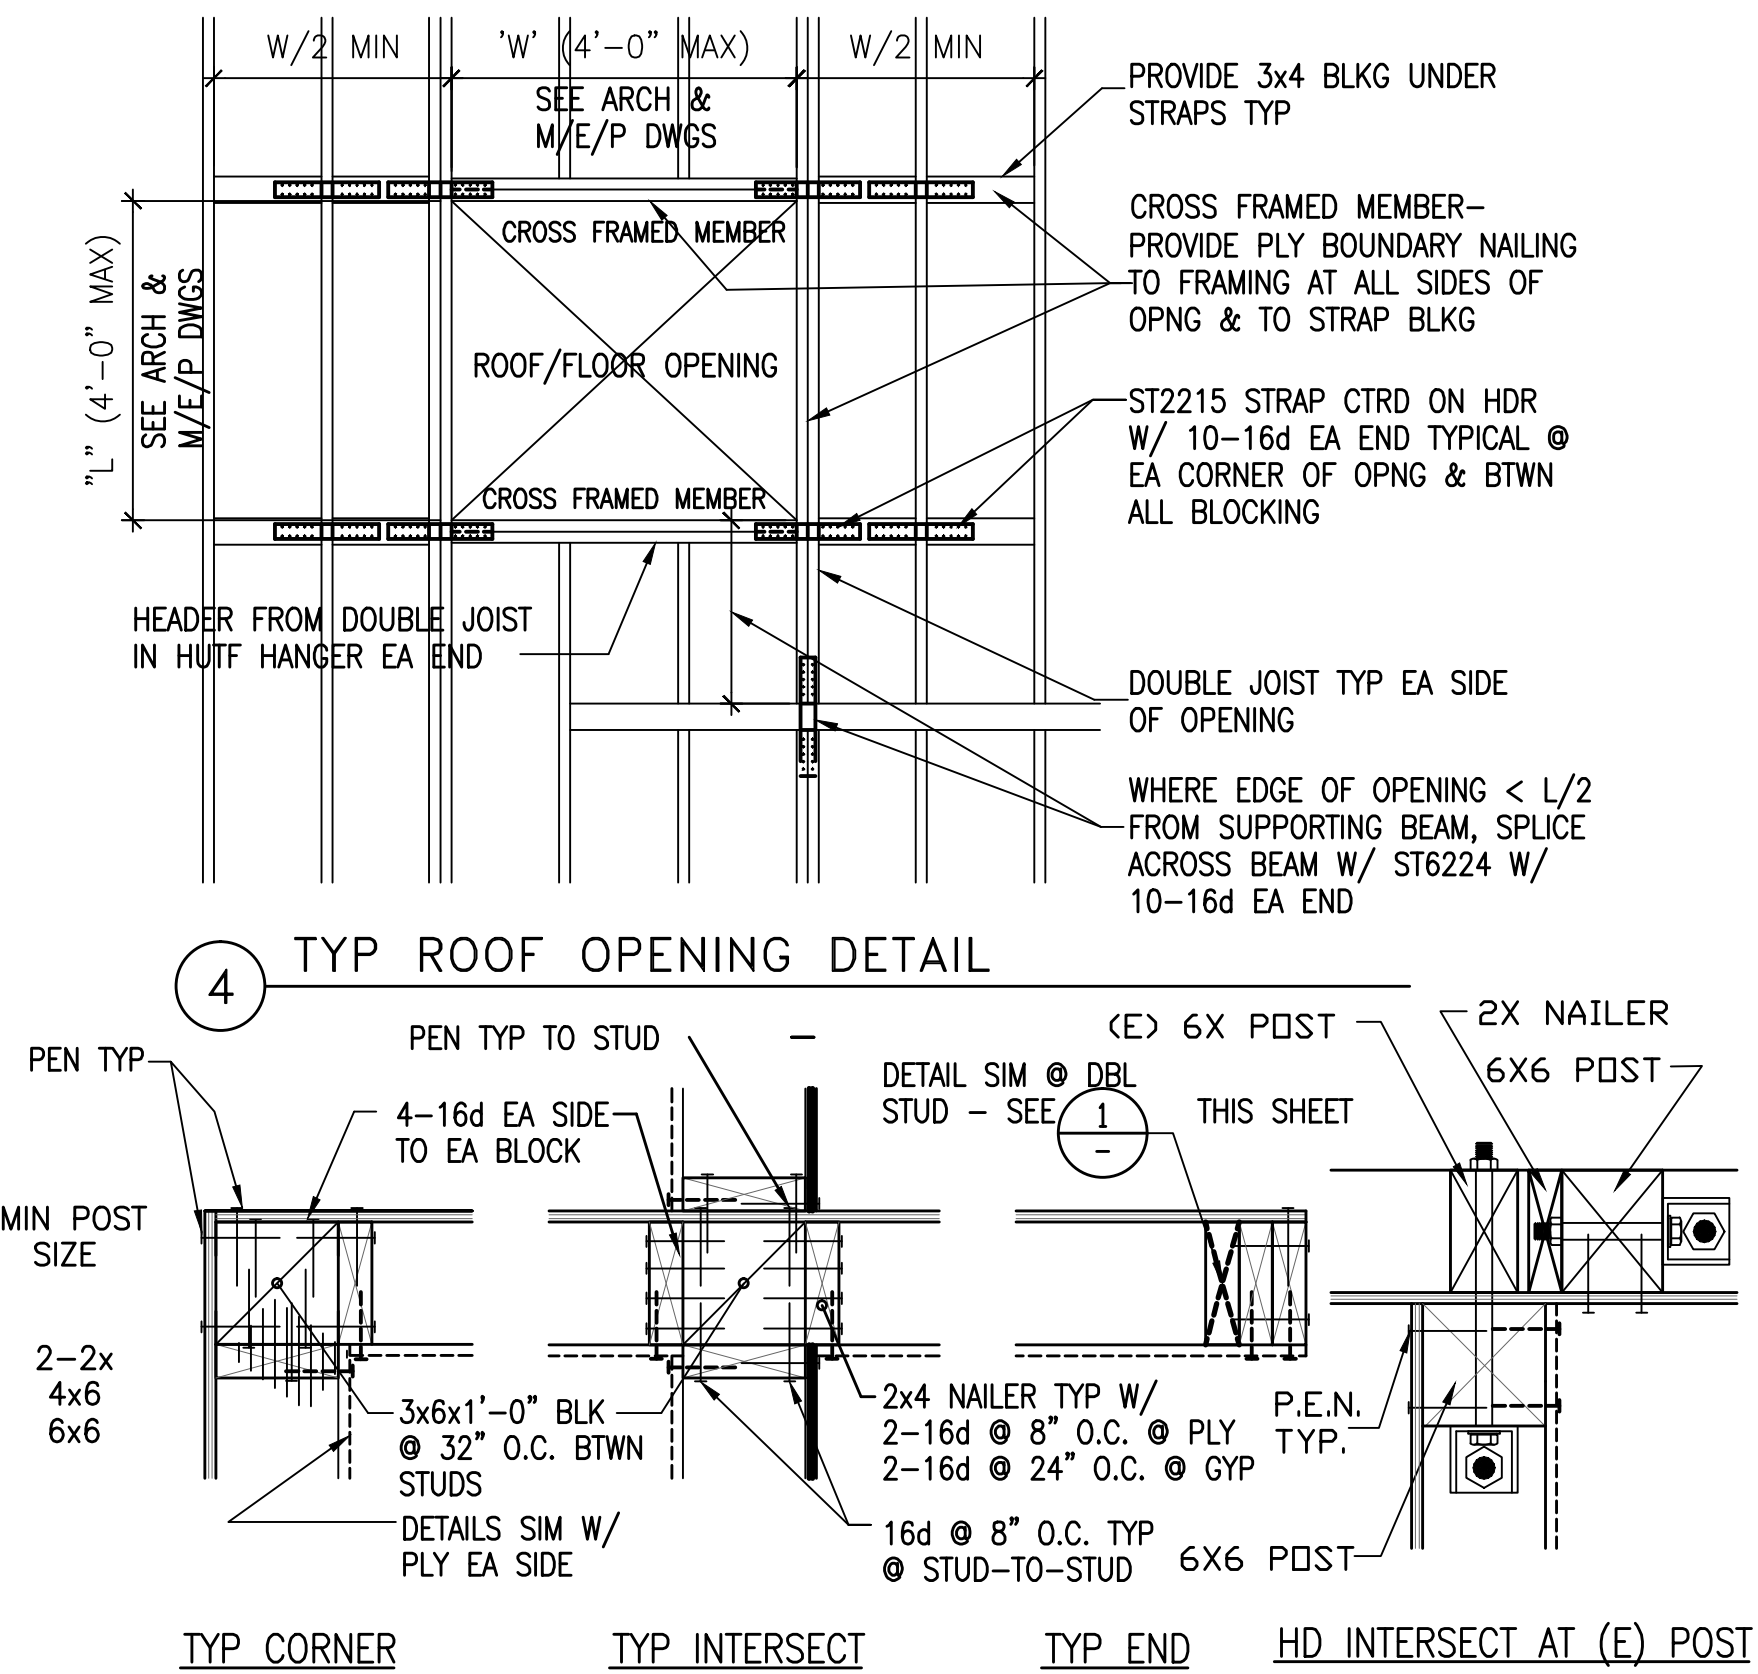

1B SHEAR WALL EXTENSION & COLLECTOR  
DETAIL-TRUSSES/JOIST PERPENDICULAR TO SHEAR WALL  
SCALE 3/4"=1'-0"

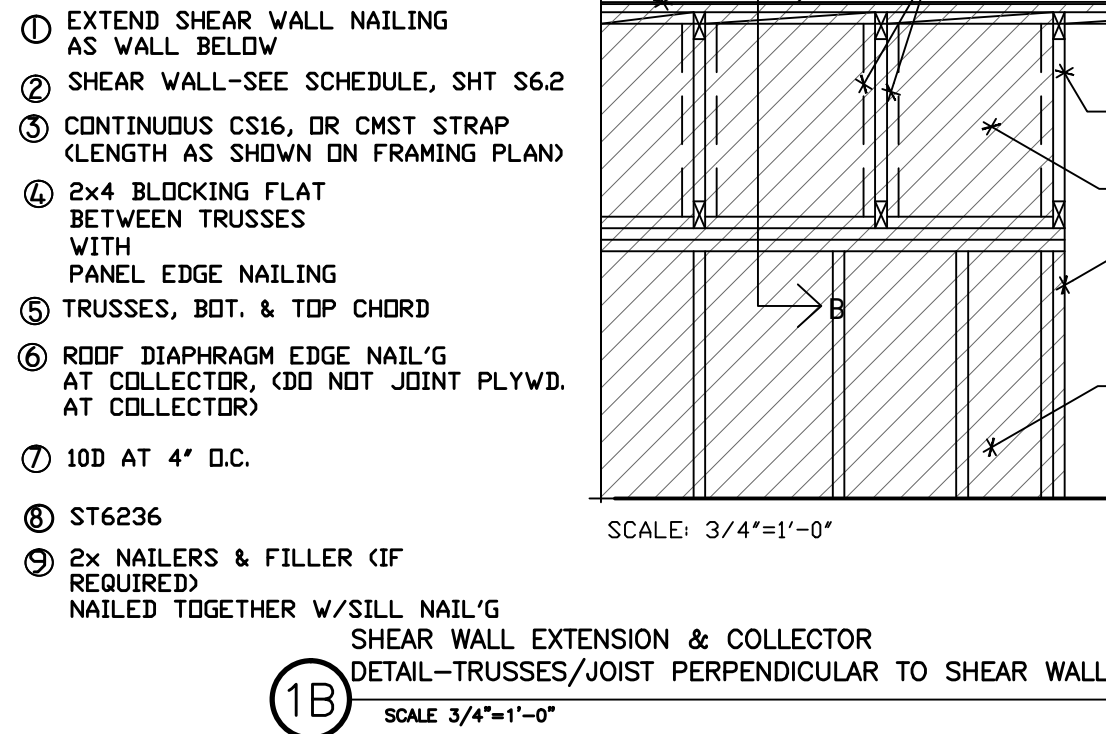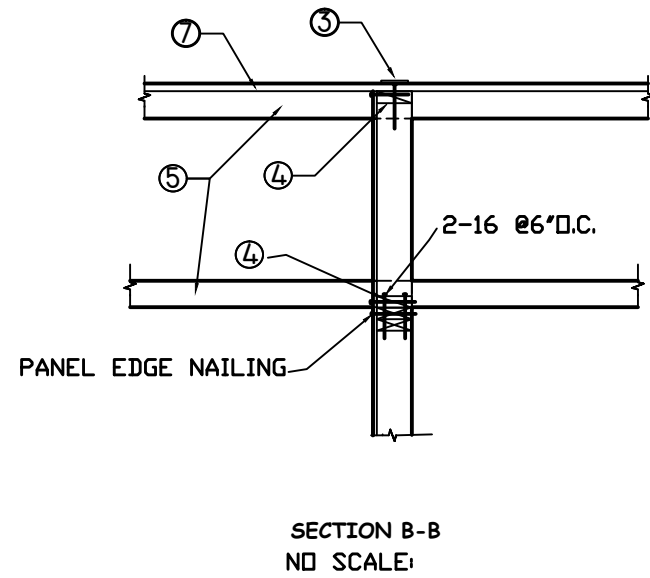SHEAR WALL SCHEDULE					
SYM.	SHEARWALL DESCRIPTION	TOP R SHEAR TRANSFER	SILL PLATE ANCHORAGE		
			ANCHOR BOLTS (SEE NOTE 11)	SILL ATTACH. LAG SCREWS	LPT4 OR LPT5
	AT APA RATED PANELS USE COMMON NAILS OR GALV. BOX NAILS				
1	15/32" CDX PLYWOOD (1) SIDE W/ 10d @ 6" o.c.. USE 2x WALL AND 2x SOLE PLATE.	SEE PLAN	3/4"ø A.B. AT 36" o.c.	*	@ 12" O.C.
2	15/32" CDX PLYWOOD (1) SIDE W/ 10d @ 4" o.c.. USE 3x WALL AND 3x SOLE PLATE.	SEE PLAN	3/4"ø A.B. AT 30" o.c.	*	@ 12" O.C.
3	15/32" CDX PLYWOOD (1) SIDE W/ 10d @ 3" o.c.. USE 3x WALL AND 3x SOLE PLATE.	SEE PLAN	3/4"ø A.B. AT 18" o.c.	3/8"øX5" LONG @ 5" o.c.	@ 12" O.C.
4	15/32" CDX PLYWOOD (1) SIDE W/ 10d @ 2" o.c.. USE 3x WALL AND 3x SOLE PLATE.	SEE PLAN	3/4"ø A.B. AT 12" o.c.	3/8"øX5" LONG @ 4" o.c.	@ 6" O.C.
5	15/32" CDX PLYWOOD (2) SIDE W/ 10d @ 6" o.c.. USE 2x WALL AND 2x SOLE PLATE.	SEE PLAN	3/4"ø A.B. AT 36" o.c.	*	@ 6" O.C.
6	15/32" CDX PLYWOOD (2) SIDE W/ 10d @ 4" o.c.. USE 3x WALL AND 3x SOLE PLATE.	SEE PLAN	3/4"ø A.B. AT 30" o.c.	*	@ 6" O.C. AT EA. SIDE
7	15/32" CDX PLYWOOD (2) SIDE W/ 10d @ 3" o.c.. USE 3x WALL AND 3x SOLE PLATE.	SEE PLAN	3/4"ø A.B. AT 18" o.c.	3/8"øX5" LONG @ 5" o.c.	@ 6" O.C. AT EA. SIDE
8	15/32" CDX PLYWOOD (2) SIDE W/ 10d @ 2" o.c.. USE 3x WALL AND 3x SOLE PLATE.	SEE PLAN	3/4"ø A.B. AT 12" o.c.	3/8"øX5" LONG @ 4" o.c.	@ 6" O.C. AT EA. SIDE
9	12" WIDE HARDY PANEL	SEE PLAN	SEE PLAN	SEE PLAN	
10	24" WIDE HARDY PANEL	SEE PLAN	SEE PLAN	SEE PLAN	
NOTES.		7. FURNISH 3x MEMBERS AT ALL SHEAR WALLS, TYP. U.N.O.			
1. NOT USED.		8. NAILS SHALL BE STAGGERED ON EACH SIDE OF SIDE OF STUD WHERE PLYWOOD PANELS ARE APPLIED ON BOTH SIDES OF WALL			
2. APA RATED PANELS SHALL BE CDX OF THE FOLLOWING MATERIALS: PLYWOOD (NER-108) ORIENTED STRAND BOARD (NER-Q397) WAFFERBOARD (NER-124)		9. * = NOT APPLICABLE			
3. NAILING INDICATED IS TYP. EDGE NAILING, FOR FIELD NAILING 10d @ 12" O.C.		10. NOT USED			
4. ALL HOLDDOWNS EXCEPT MA4 ARE PLACED ON 6x6 POSTS TYP. U.N.O.		11. AT ALL ANCHOR BOLTS AT SILL PLATES PROVIDE A MINIMUM 3X3X0.229 THK PLATE WAASHER WITH NUT.			
5. STAGGER JOINT AND SILL & NAILING.					
6. NOT USED					

NOTE:

UNDERDRIVEN NAILS ARE REQUIRED TO BE DRIVEN BY HAMMER SO THAT THE HEAD OF THE NAIL IS FLUSH WITH THE TOP SURFACE OF THE PLYWOOD.


MACHINE NAILING SHALL BE USED ONLY WHERE THE BACK SIDE CAN BE INSPECTED FOR "SHINERS".

"SHINERS" OR NAILS WHICH DO NOT PENETRATE FULLY INTO FRAMING OR BLOCKING SHALL BE REMOVED AND REPLACED. ALL REMEDIAL NAILING SHALL BE BY HAND.

IF ANY FRAMING MEMBERS, BLOCKING OR JOISTS RECEIVING THE POINTS OF NAILS, ARE DAMAGED (SPLIT, NAILS HIT TO CLOSE, ETC.) THEY SHALL BE REMOVED AND REPLACED.

GUN NAILING FOR TOE NAIL, END NAIL AND SLANT DRIVEN NAIL ARE NOT PERMITTED.

2 SHEAR WALL SCHEDULE & NOTES

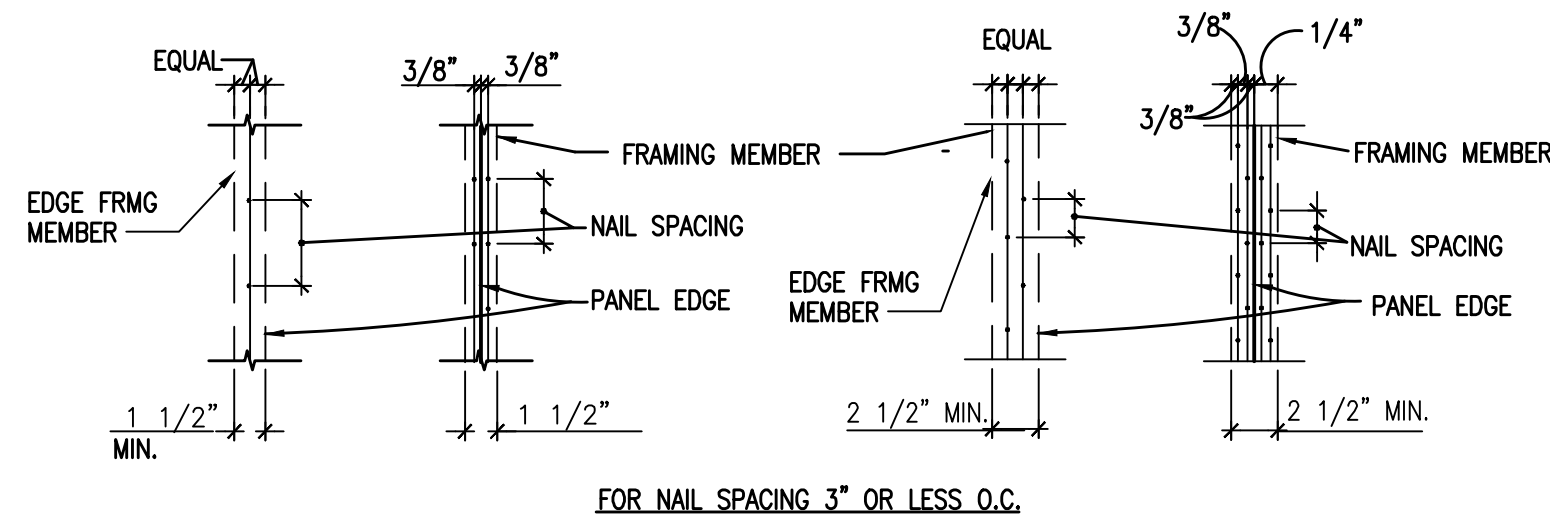

3 TYP. PLYWOOD EDGE NAILING

NO SCALE

#### TYPICAL WALL FRAMING NOTES:

- LOCATE MECH OPENINGS IN NON-SHEAR WALLS WHERE POSSIBLE.
- MECH OPENINGS IN SHEAR WALLS TO BE LOCATED 1'-6" MIN. FROM HOLD DOWN ANCHOR LOCATIONS.
- ALL NAILING NOT SHOWN IS PER NAILING SCHEDULE ON S0.1 OR AS DETAILED ELSEWHERE.
- PROVIDE STRAPS @ T&B CORNERS OF ALL SHEAR WALL OPENINGS PER THE FOLLOWING SCHEDULE:
  - OPNG < 4'-0" WIDE: CS20 STRAP W/ MIN 10-8d EA SIDE OF SPLICE PT
  - OPNG > 4'-0" WIDE: CS16 STRAP W/ MIN 16-8d EA SIDE OF SPLICE PTDISTRIBUTE NAILING EVENLY ALONG BLKG W/ 6-8d MINIMUM TO EA BLOCK FACE. SEE DETAIL 1.
- CONNECT JAMB POSTS T&B AS FOLLOWS:
  - W<4'-0" WIDE: TOENAIL PER SCHED
  - W<8'-0" WIDE: A23 CLIP T&BSEE DRAWINGS FOR OTHER CONDITIONS
- CONNECT HDRS & SILLS TO FULL HEIGHT JAMB POSTS (SOLID POST & BUILT-UP POSTS USING 2X6'S OR 3X6'S) EA SIDE AS FOLLOWS:
  - W<4'-0" WIDE: NAIL PER SCHED
  - W<6'-0" WIDE: A23 CLIP 1 SIDE OF HDRS/SILL
  - W<8'-0" WIDE: A23 CLIP EA SIDE OF HDRS/SILLSEE DRAWINGS FOR OTHER CONDITIONS
- UNLESS OTHERWISE SHOWN ON PLAN, PROVIDE HEADERS @ T.O. OPNGS AS FOLLOWS:
  - W<4'-0" WIDE: HDR DEPTH = 6" NOM
  - W<6'-0" WIDE: HDR DEPTH = 8" NOM
  - W<8'-0" WIDE: HDR DEPTH = 10" NOMHEADERS TO BE SOLID TIMBERS W/ THICKNESS SAME AS WALL STUDS. SEE 43 FOR ADDITIONAL INFORMATION.

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COMMUNITY CENTER  
HARBOR PARK APARTMENTS  
969 PORTER STREET, VALLEJO, CA 94560  
DRAWING TITLE:  
TYPICAL SHEAR WALL  
DETAILS












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Job No.: 2011-09  
Sheet:

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Of Sheets


REVISIONS BY  
9/26/2011 - PLAN CHECK G.O.

REGISTERED PROFESSIONAL ENGINEER  
JOSEPH OAKLEY JR.  
No. 2000  
Exp. 09/30/11  
STRUCTURAL  
STATE OF CALIFORNIA

Jan 27, 2014 - 11:33pm \\SERVER\Server Drive D\Year 2011 Jobs\2011-09-3 - Community Bldg\REVISED DRAWINGS FOR NEGOTIATED CONTRACT WITH VE LYONS\STRUCTURAL\S6.3.dwg

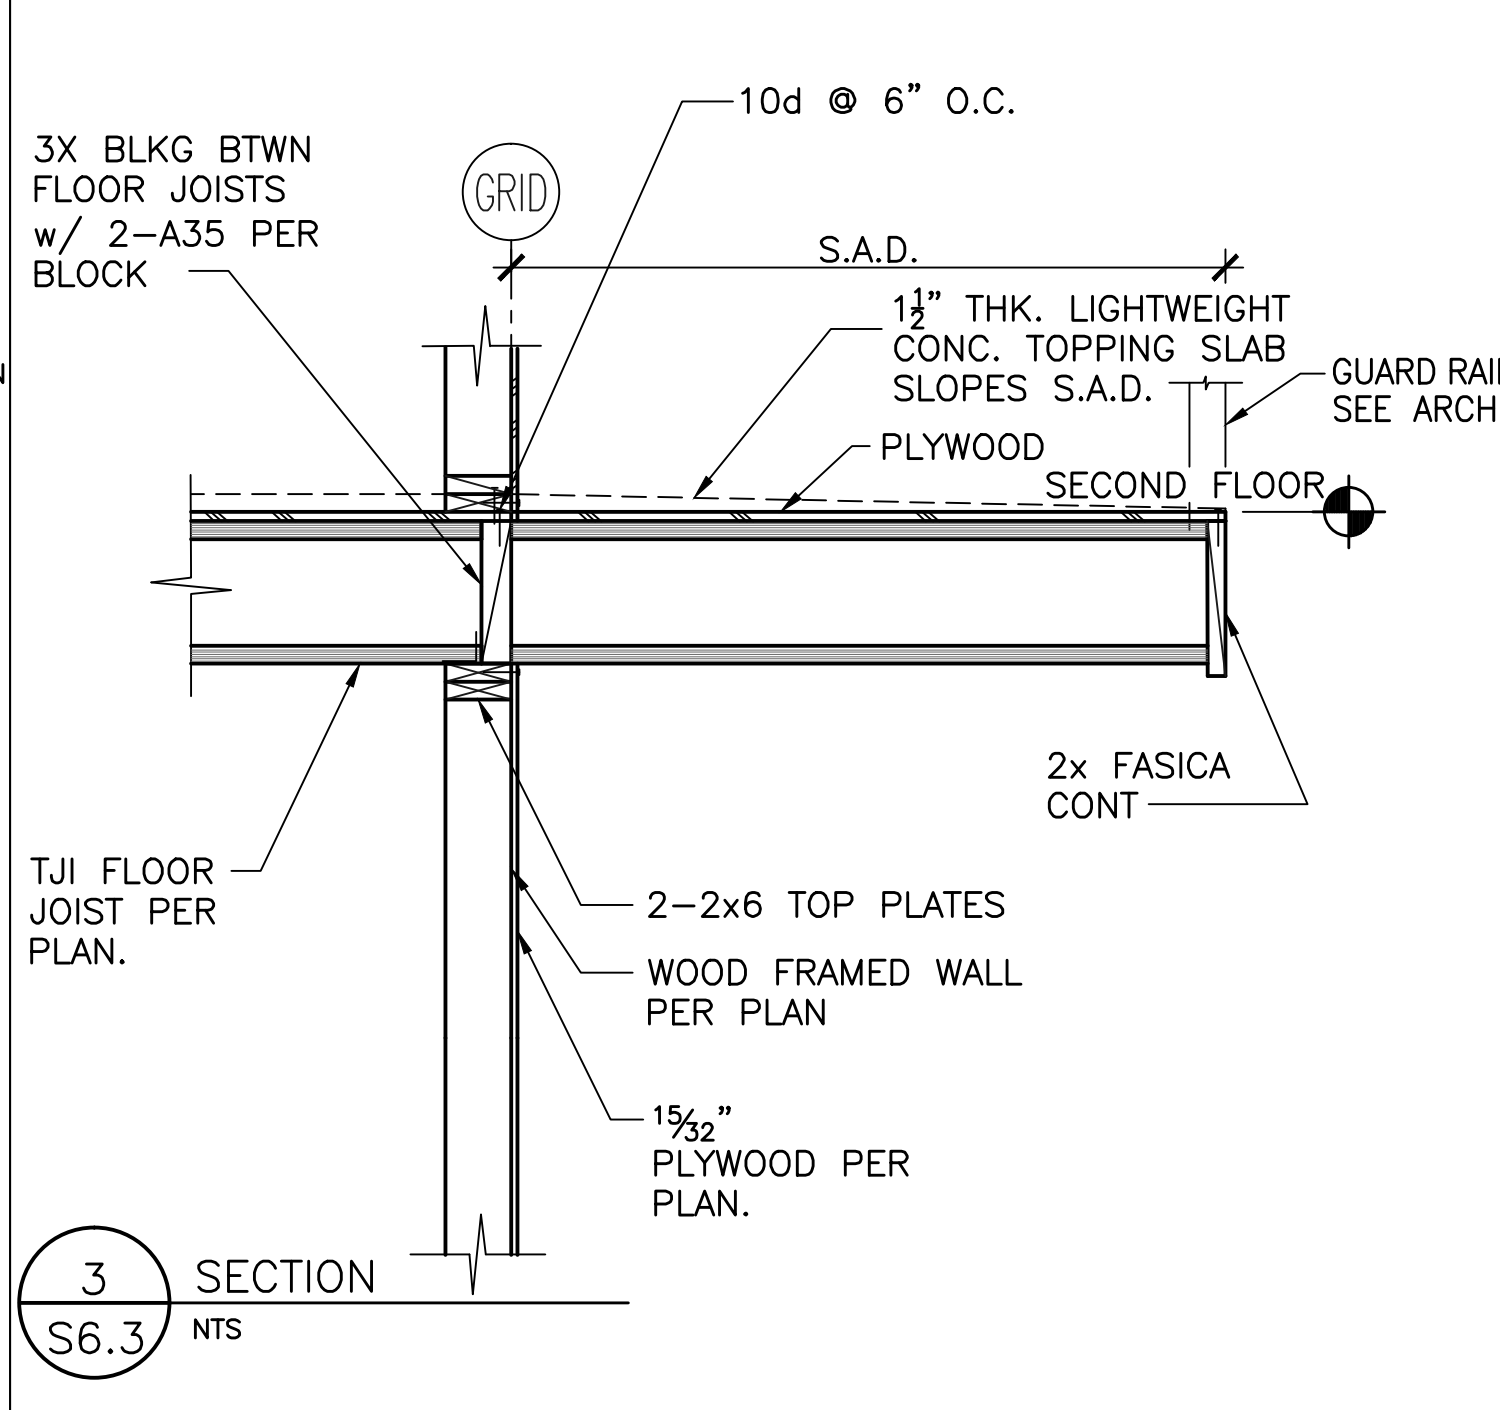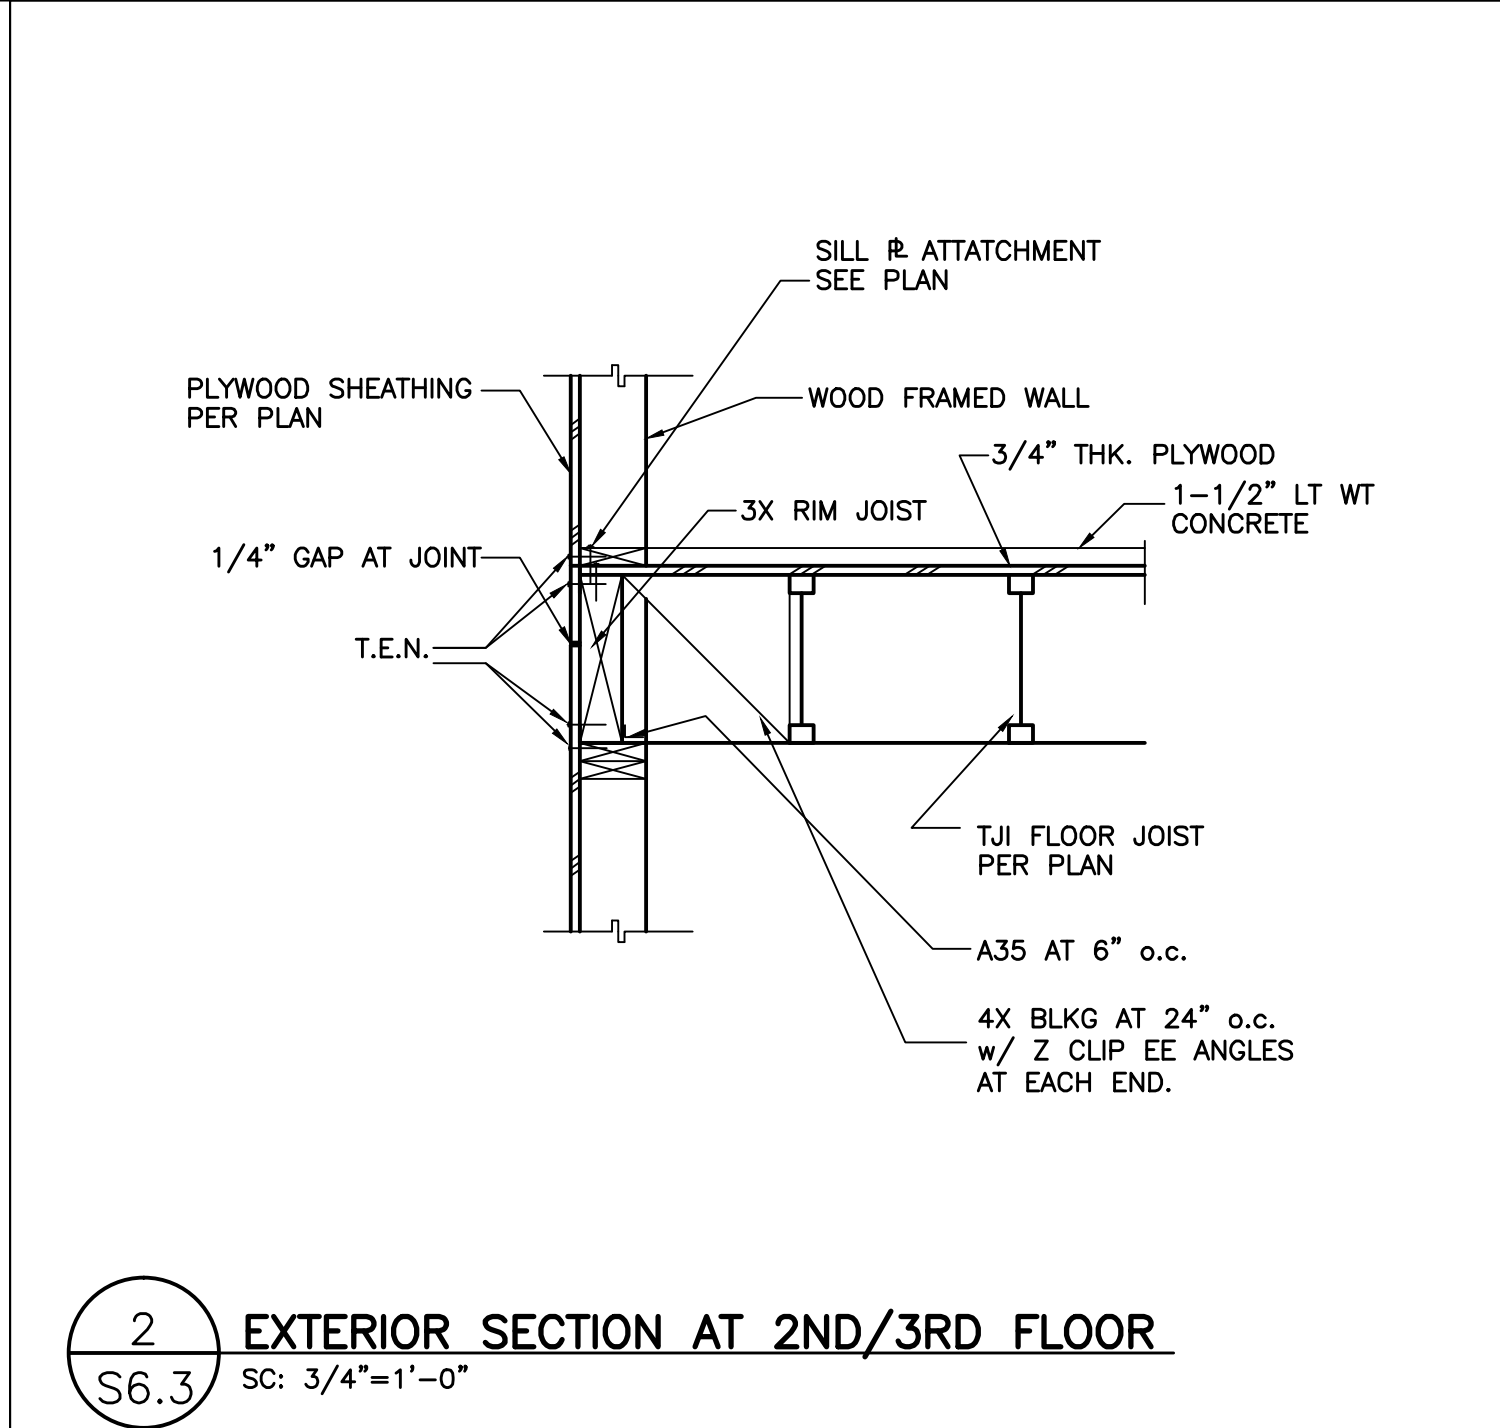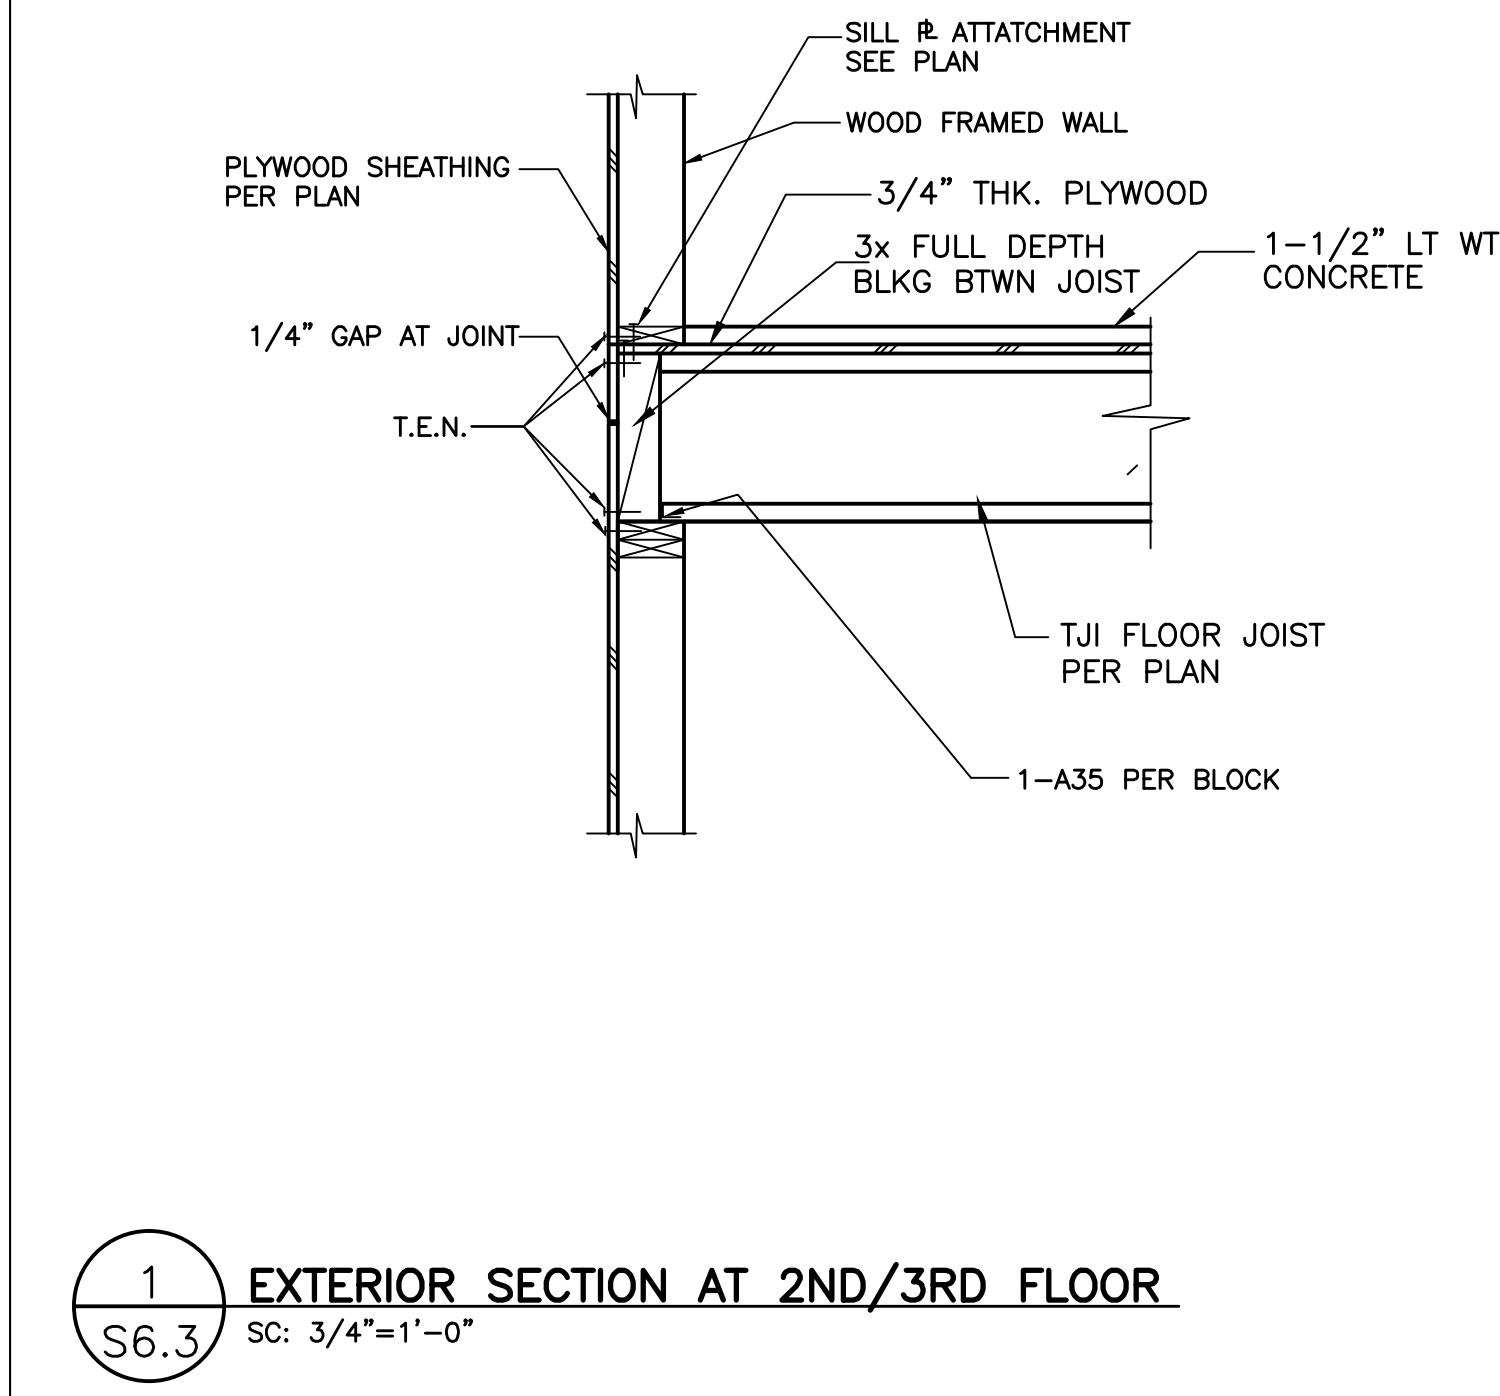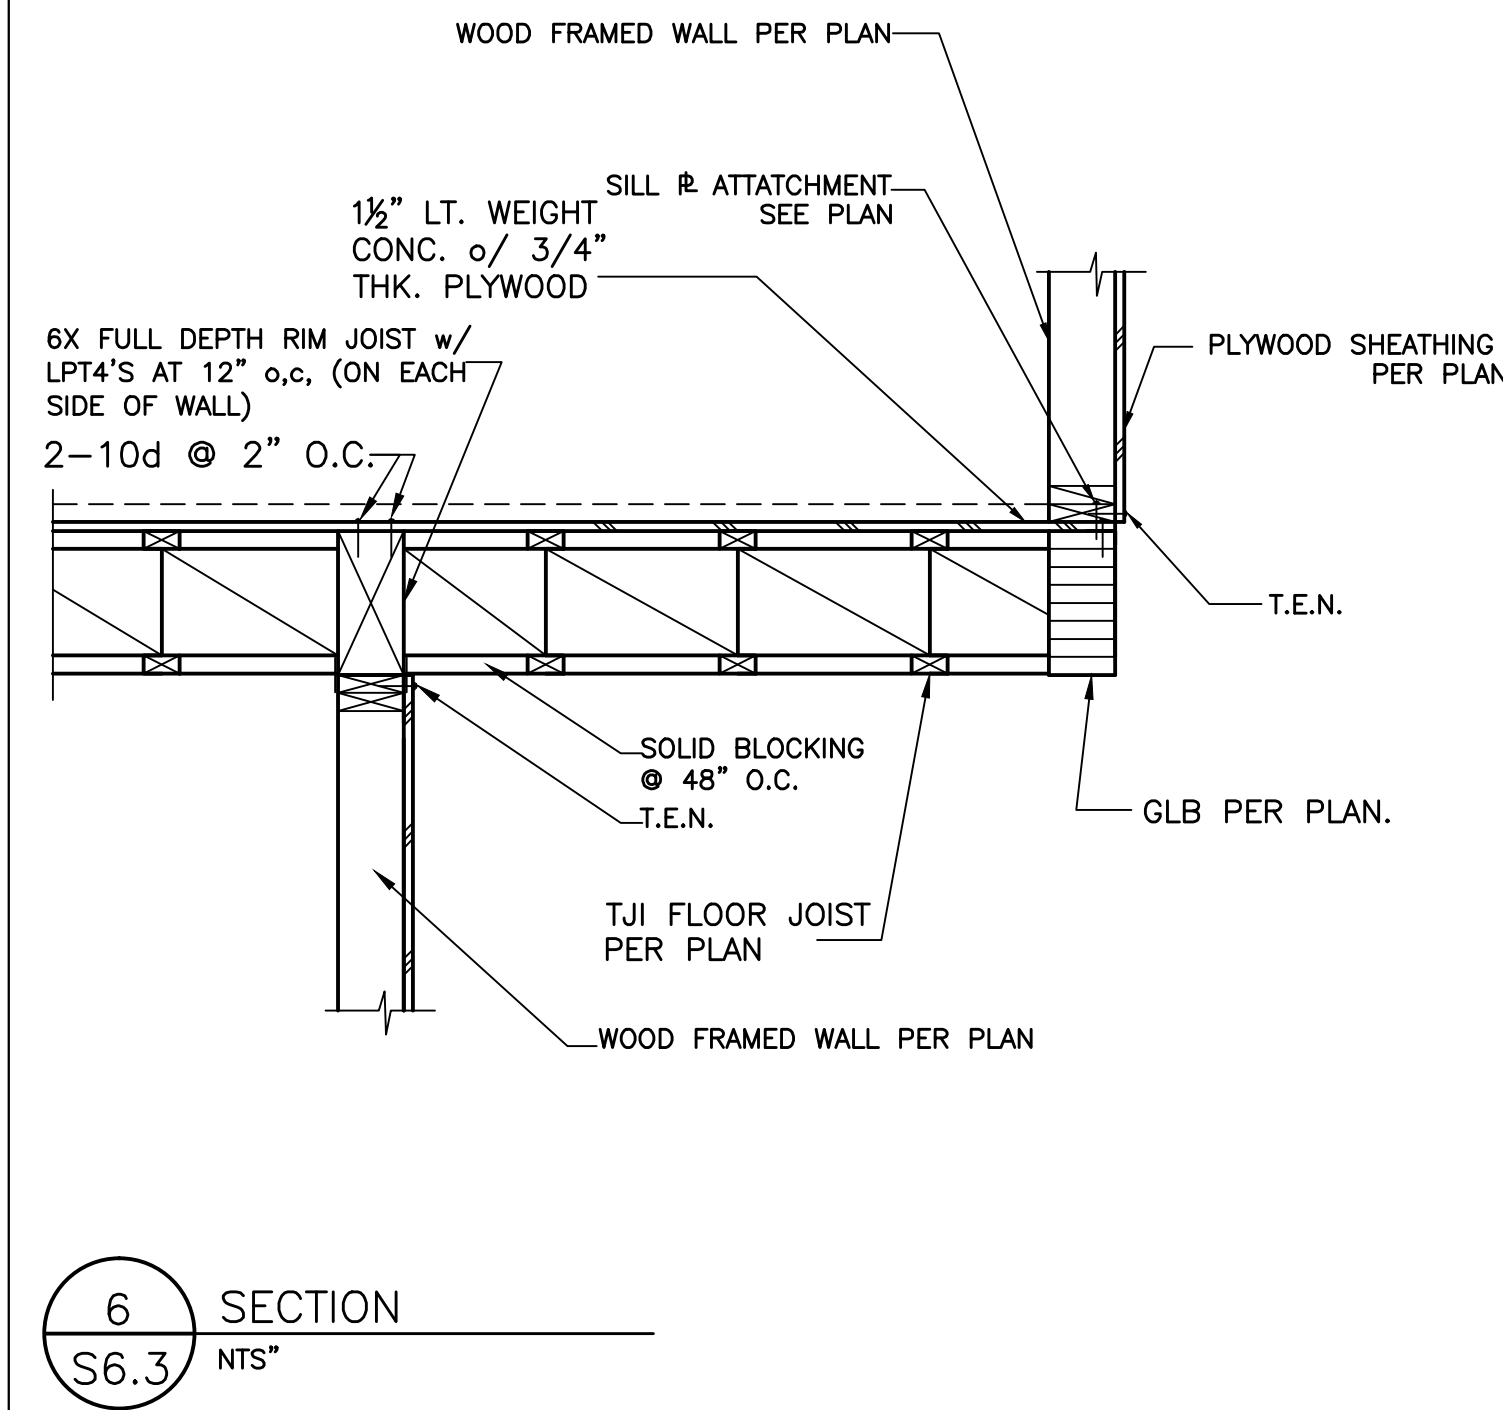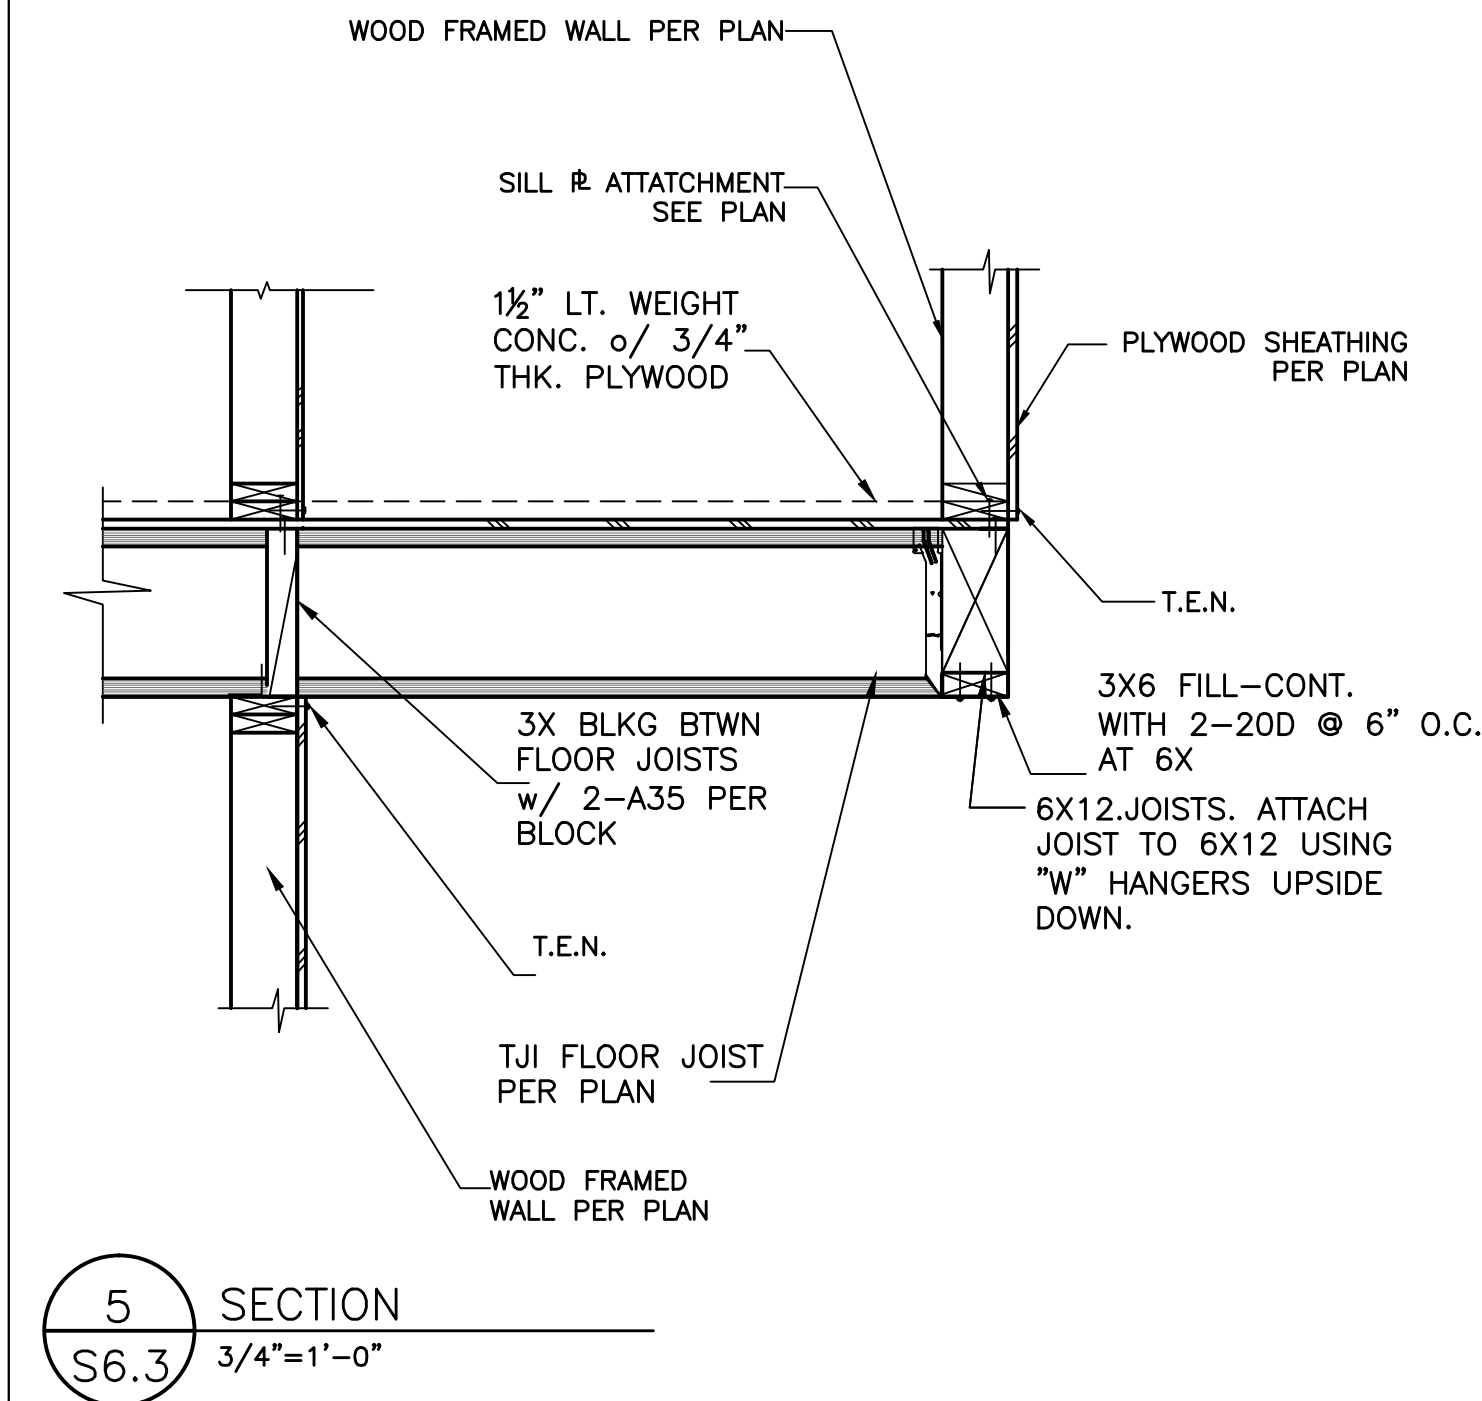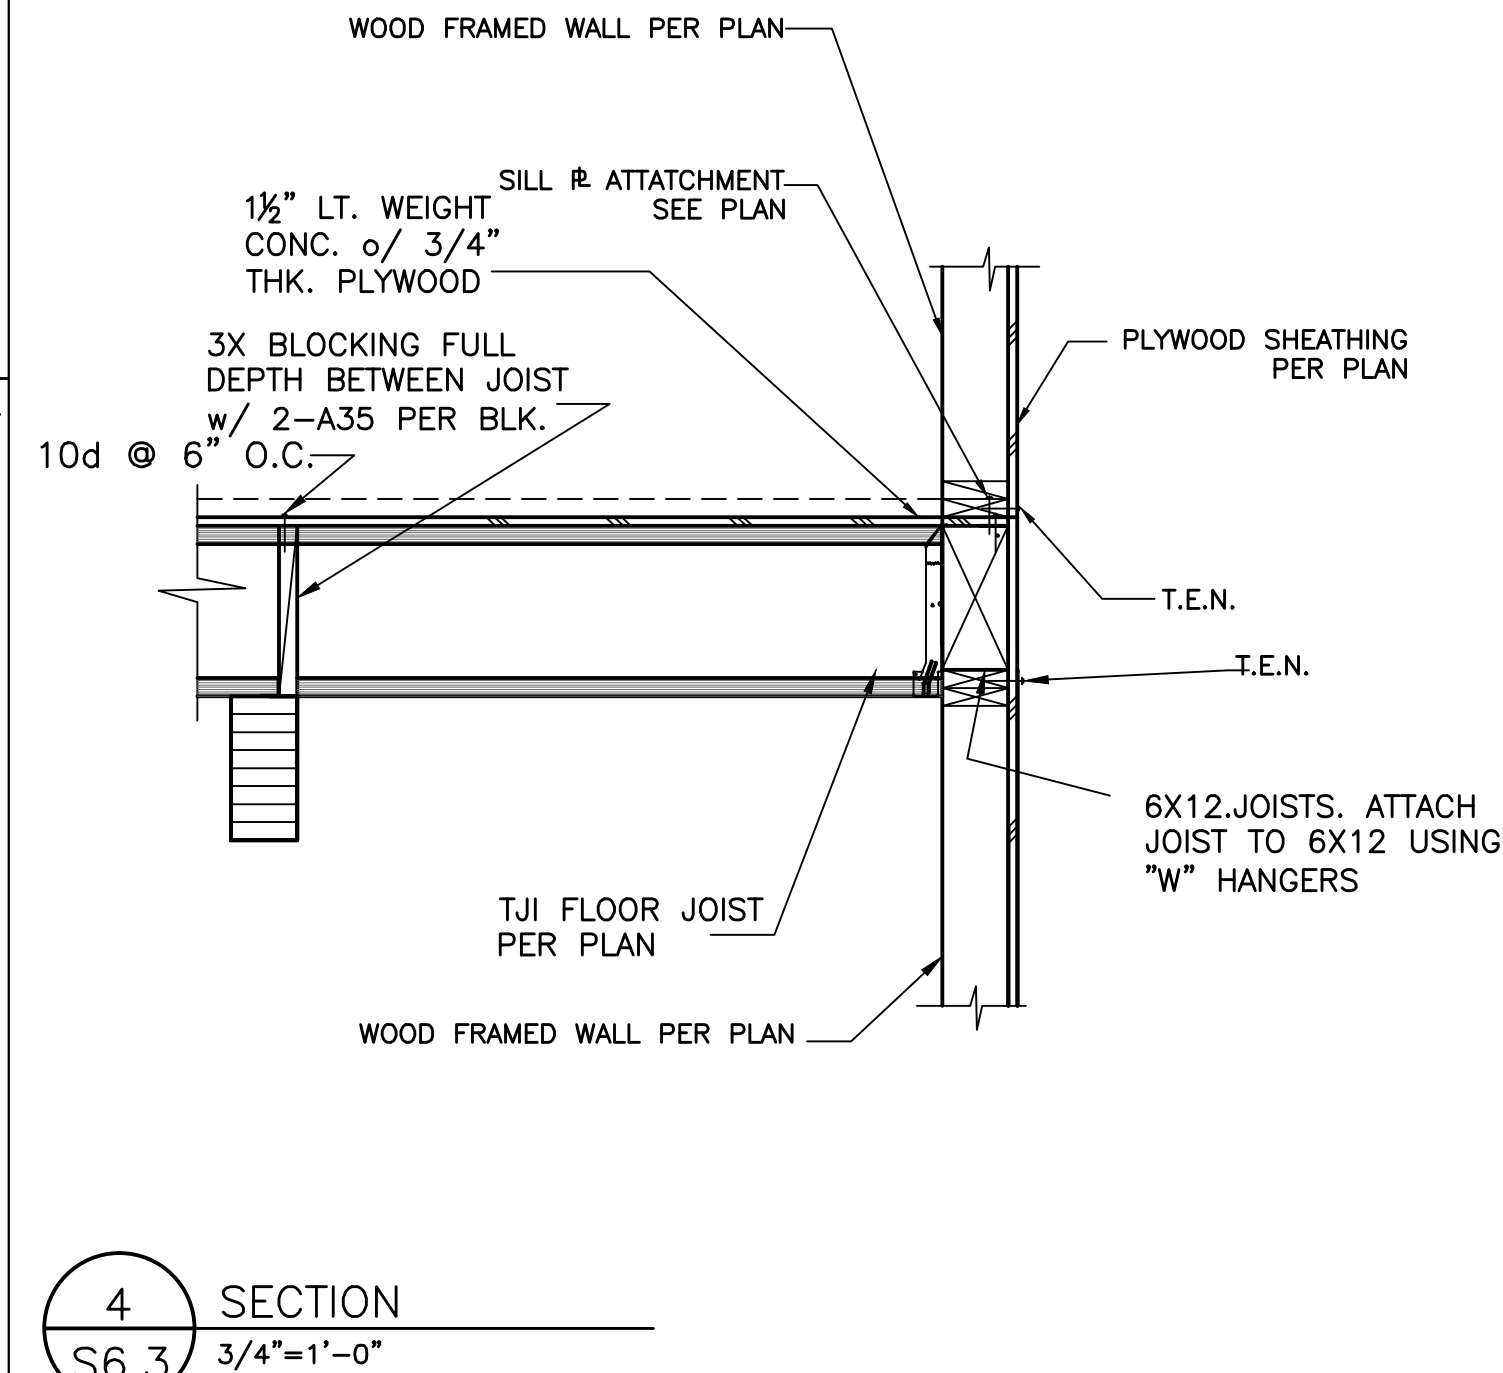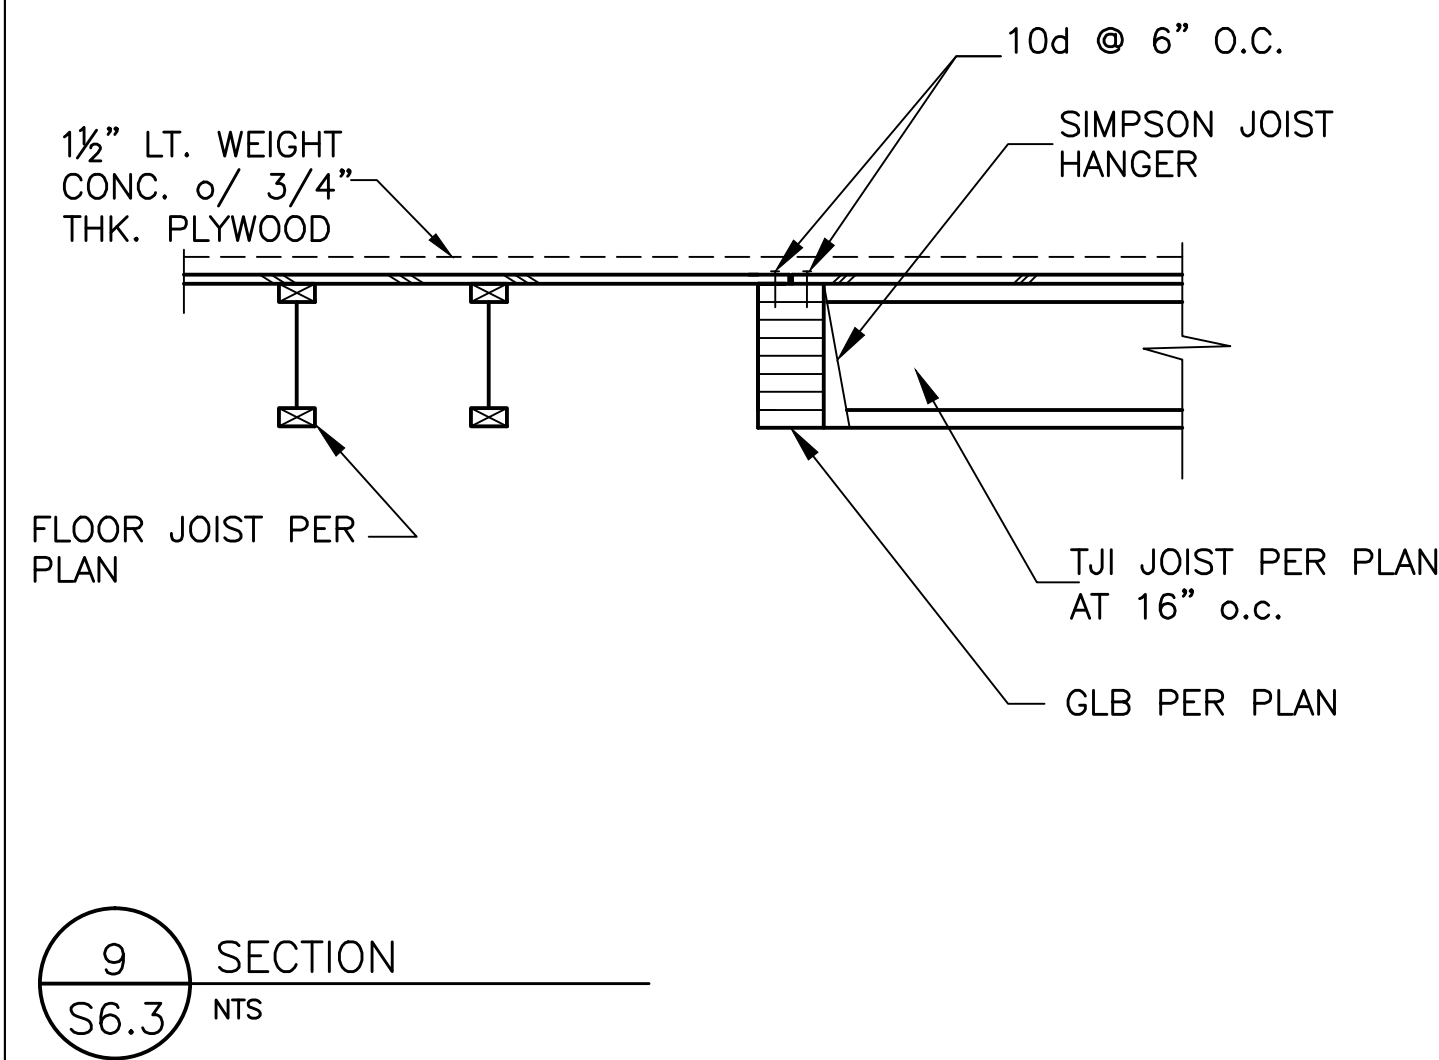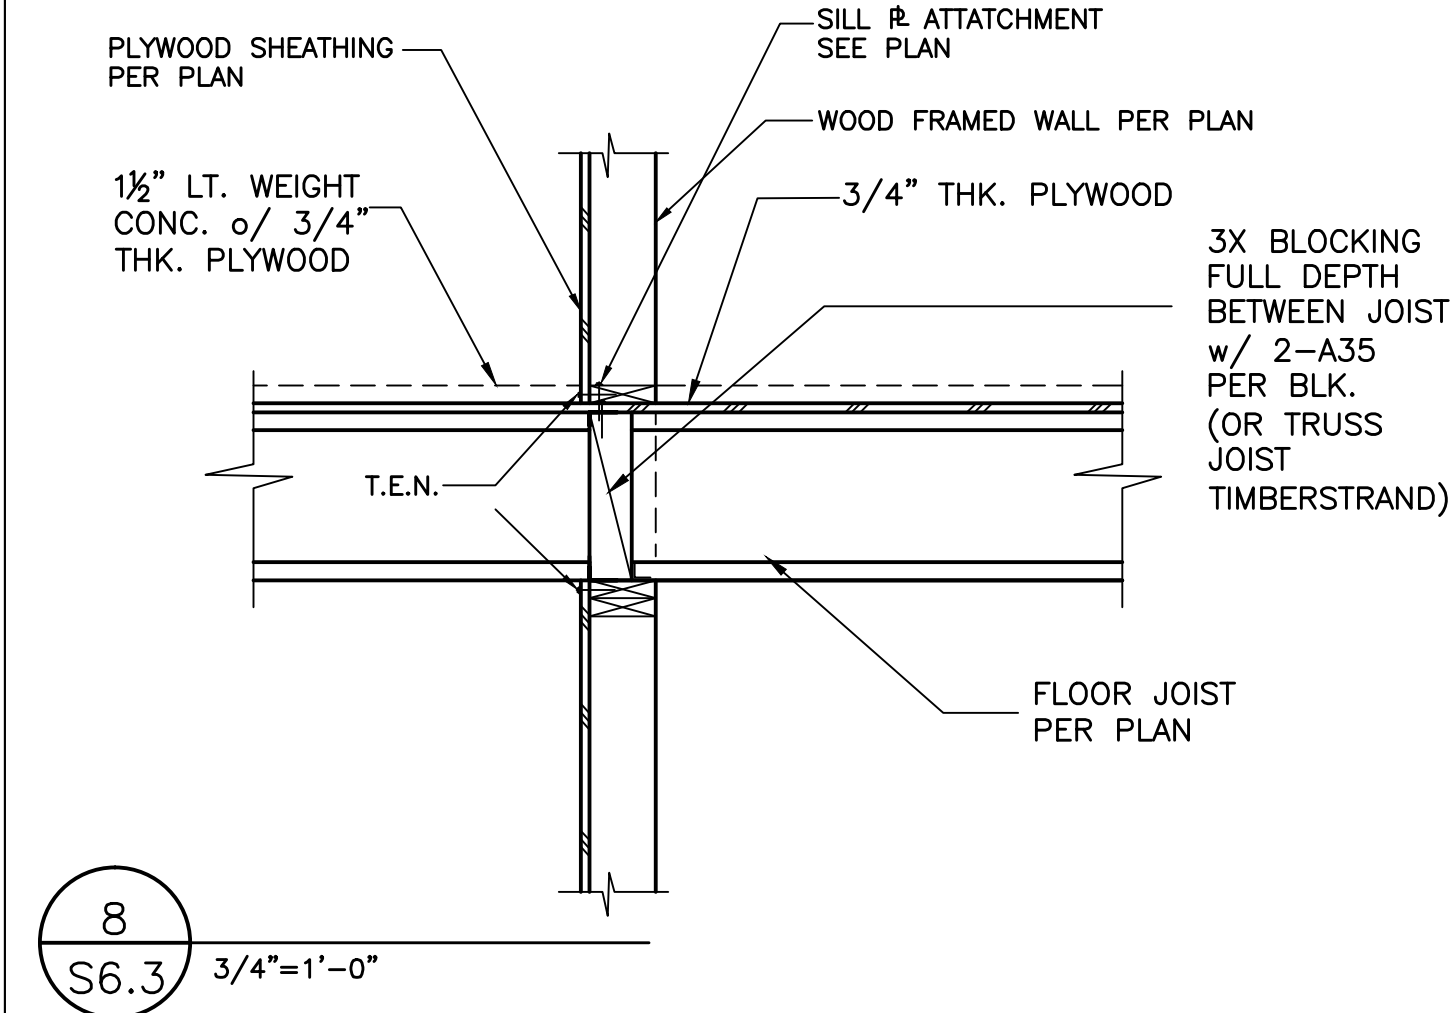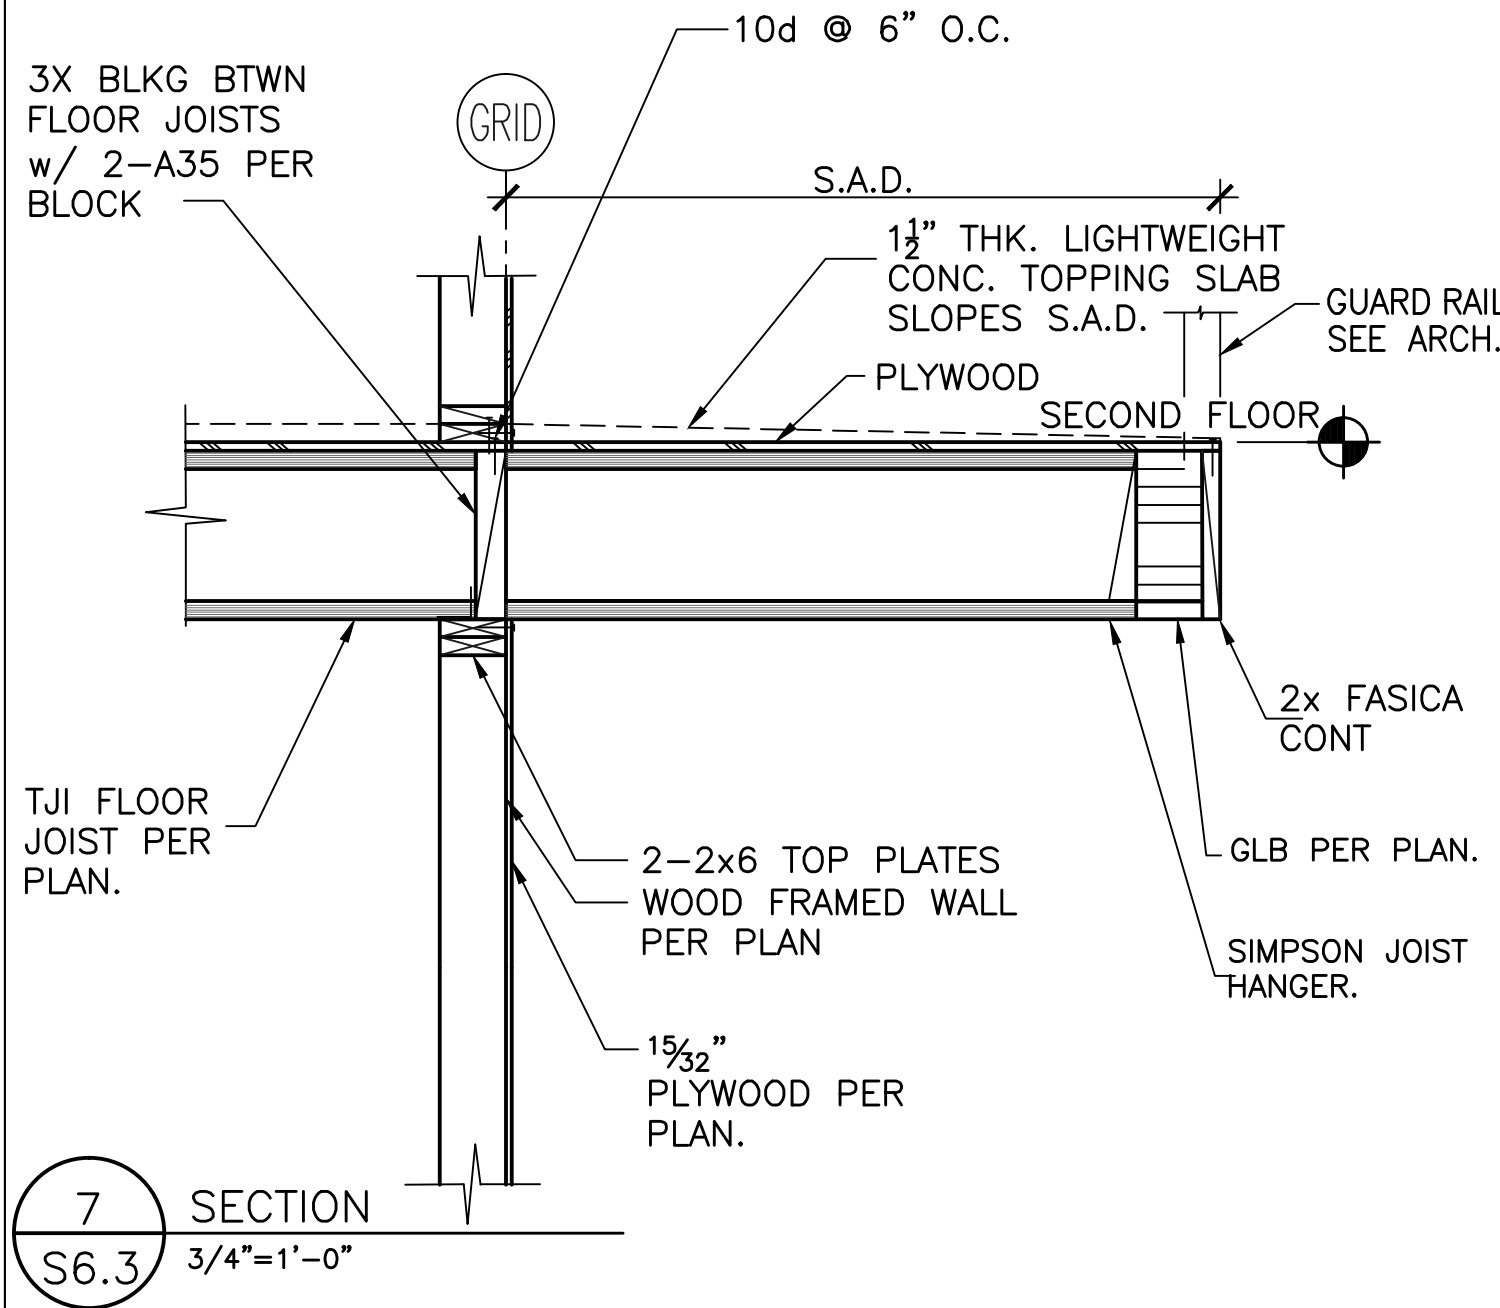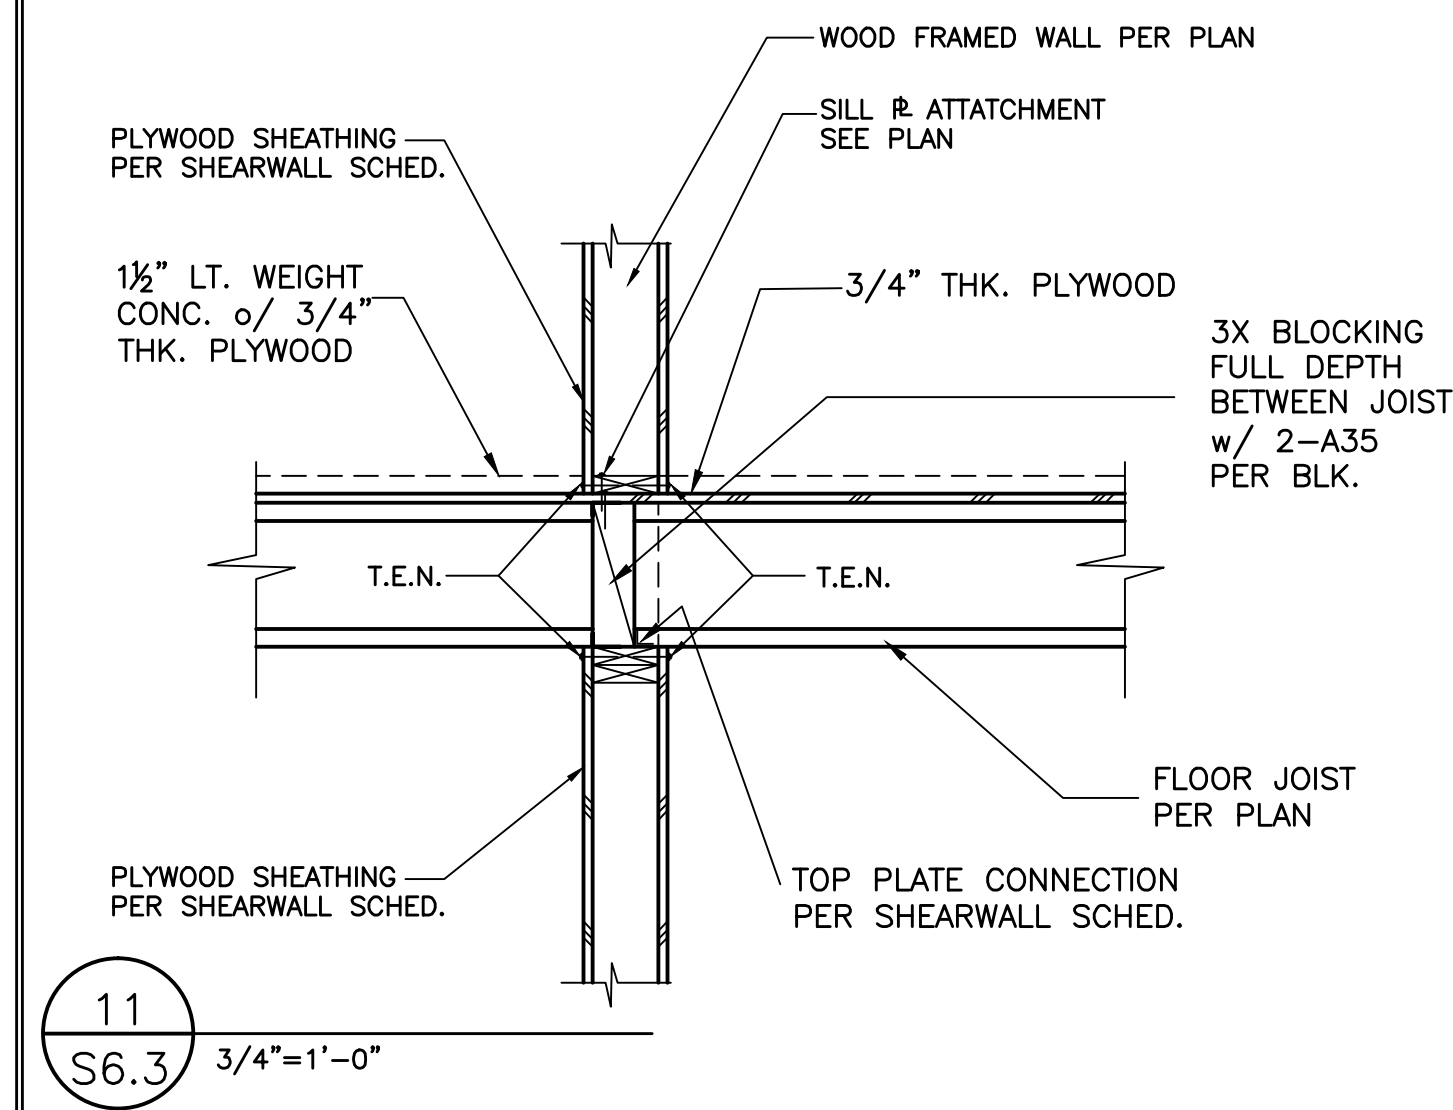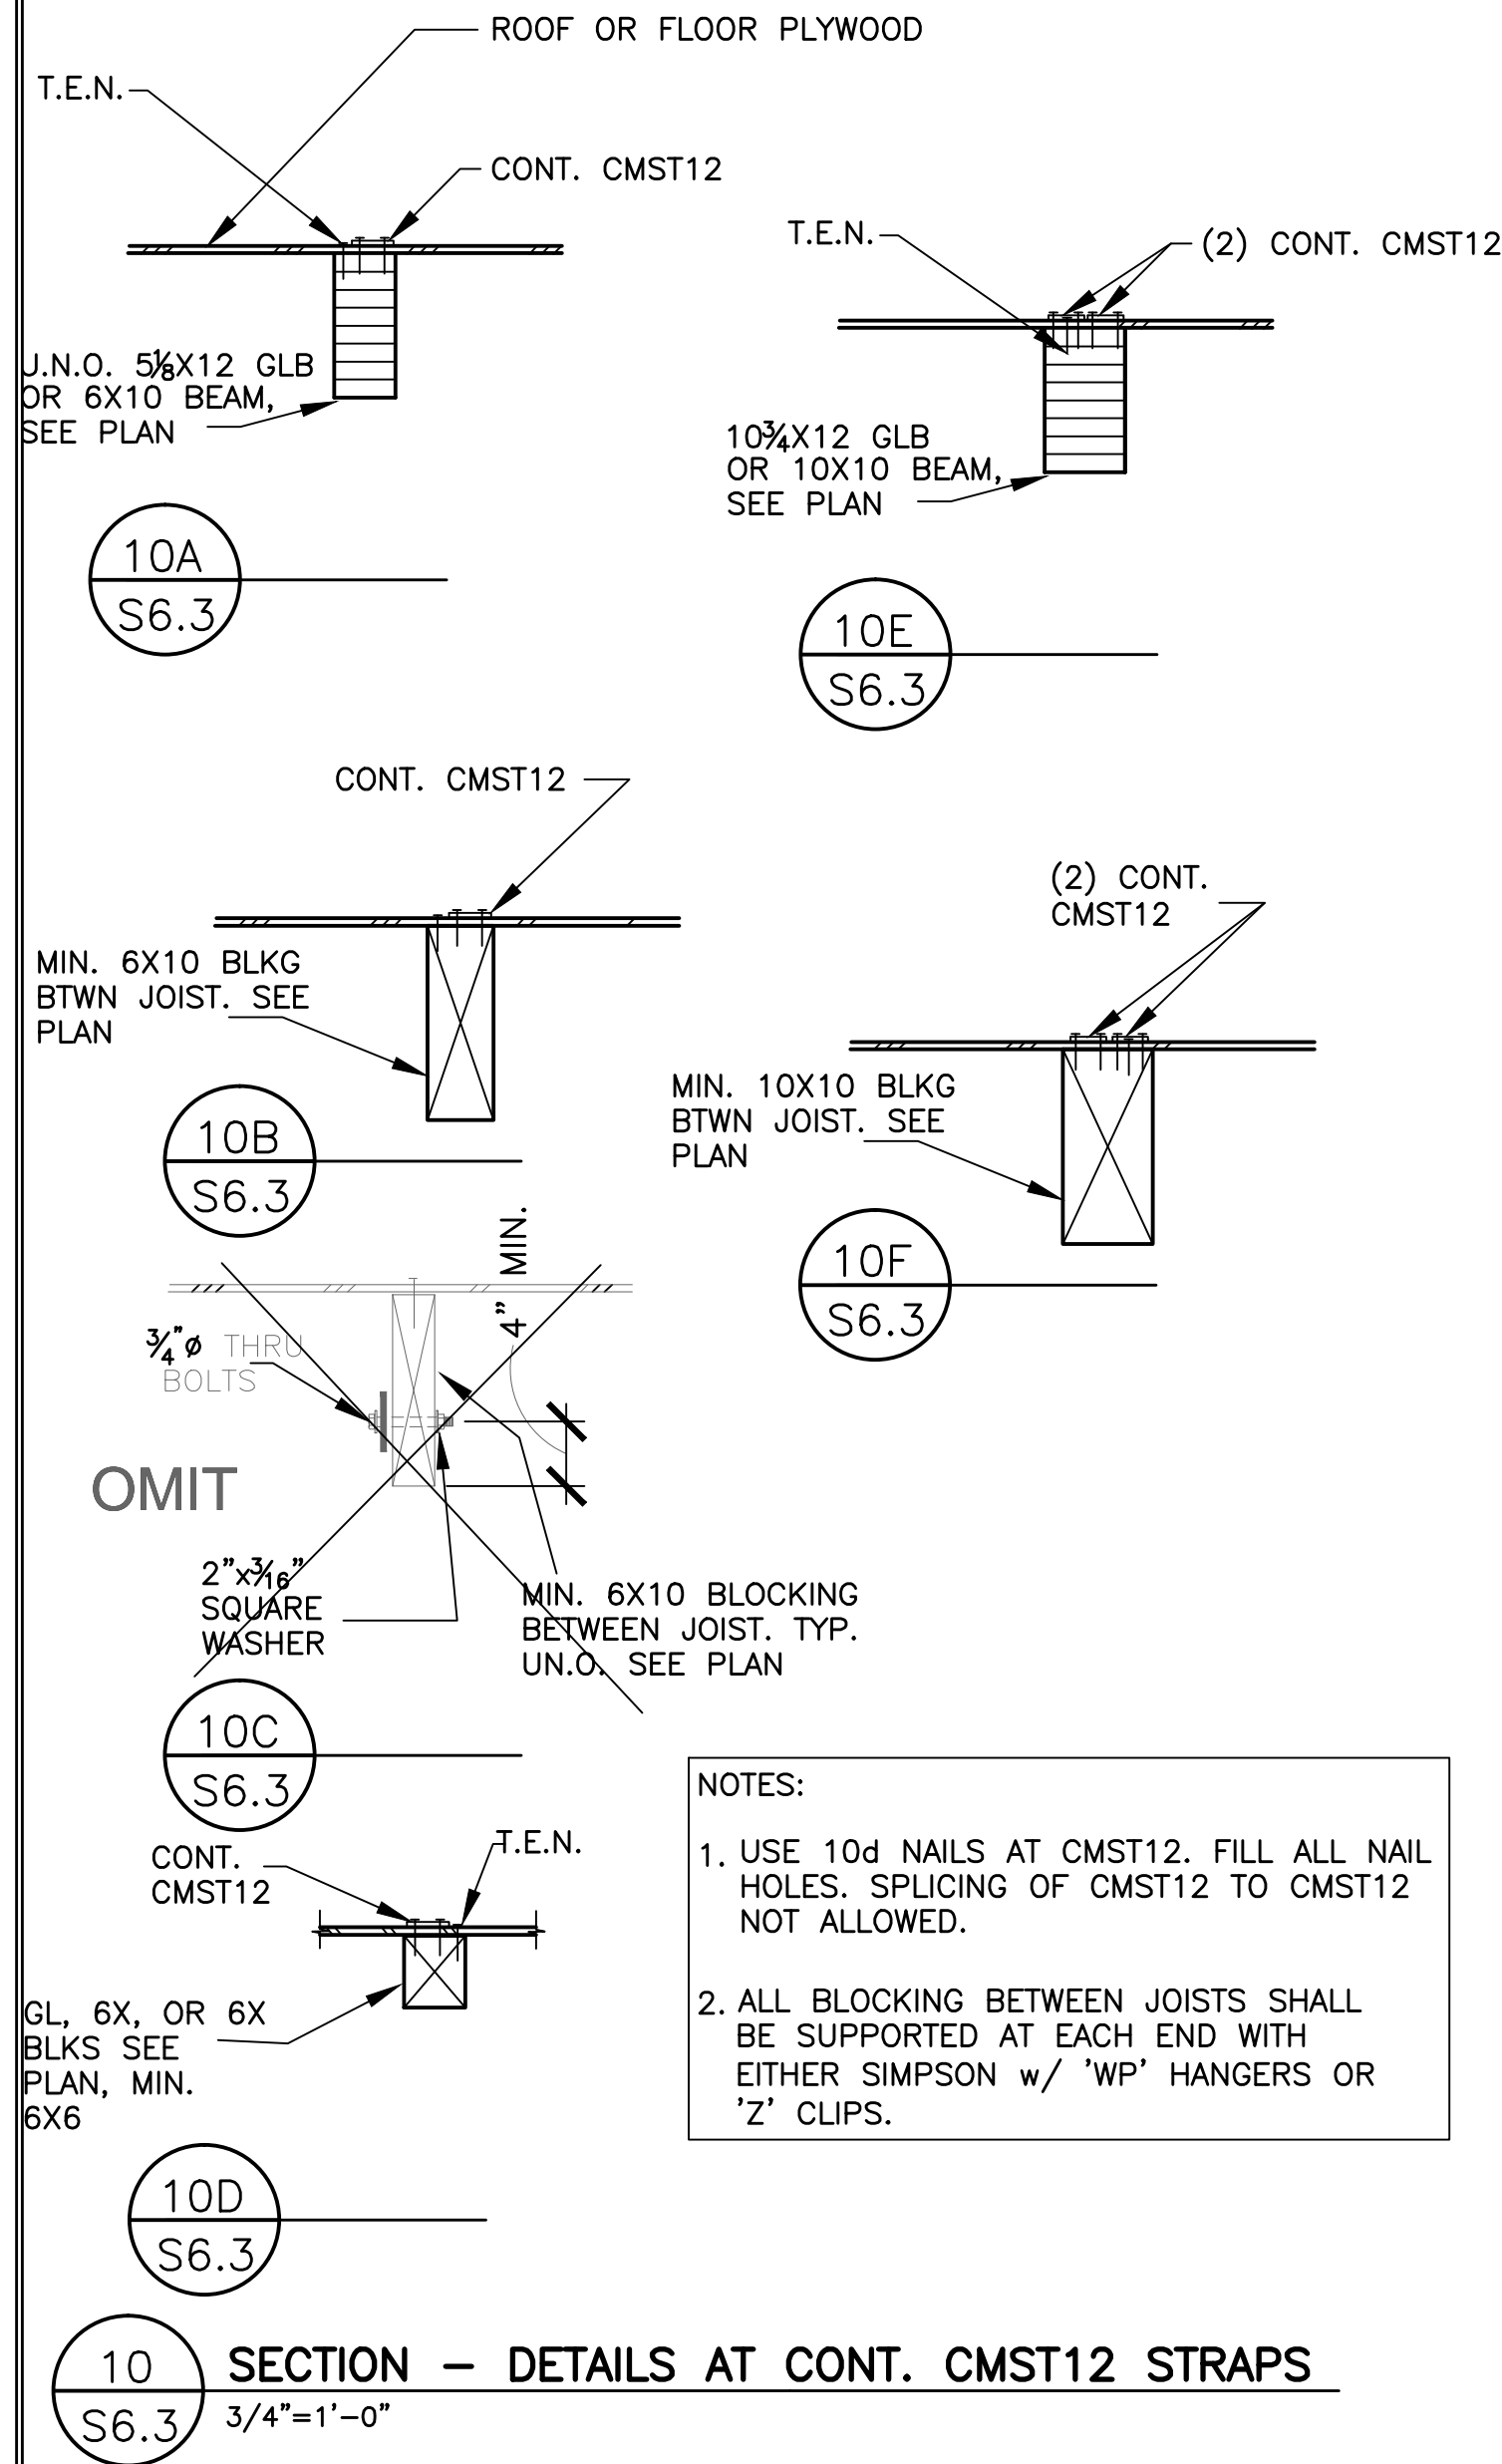

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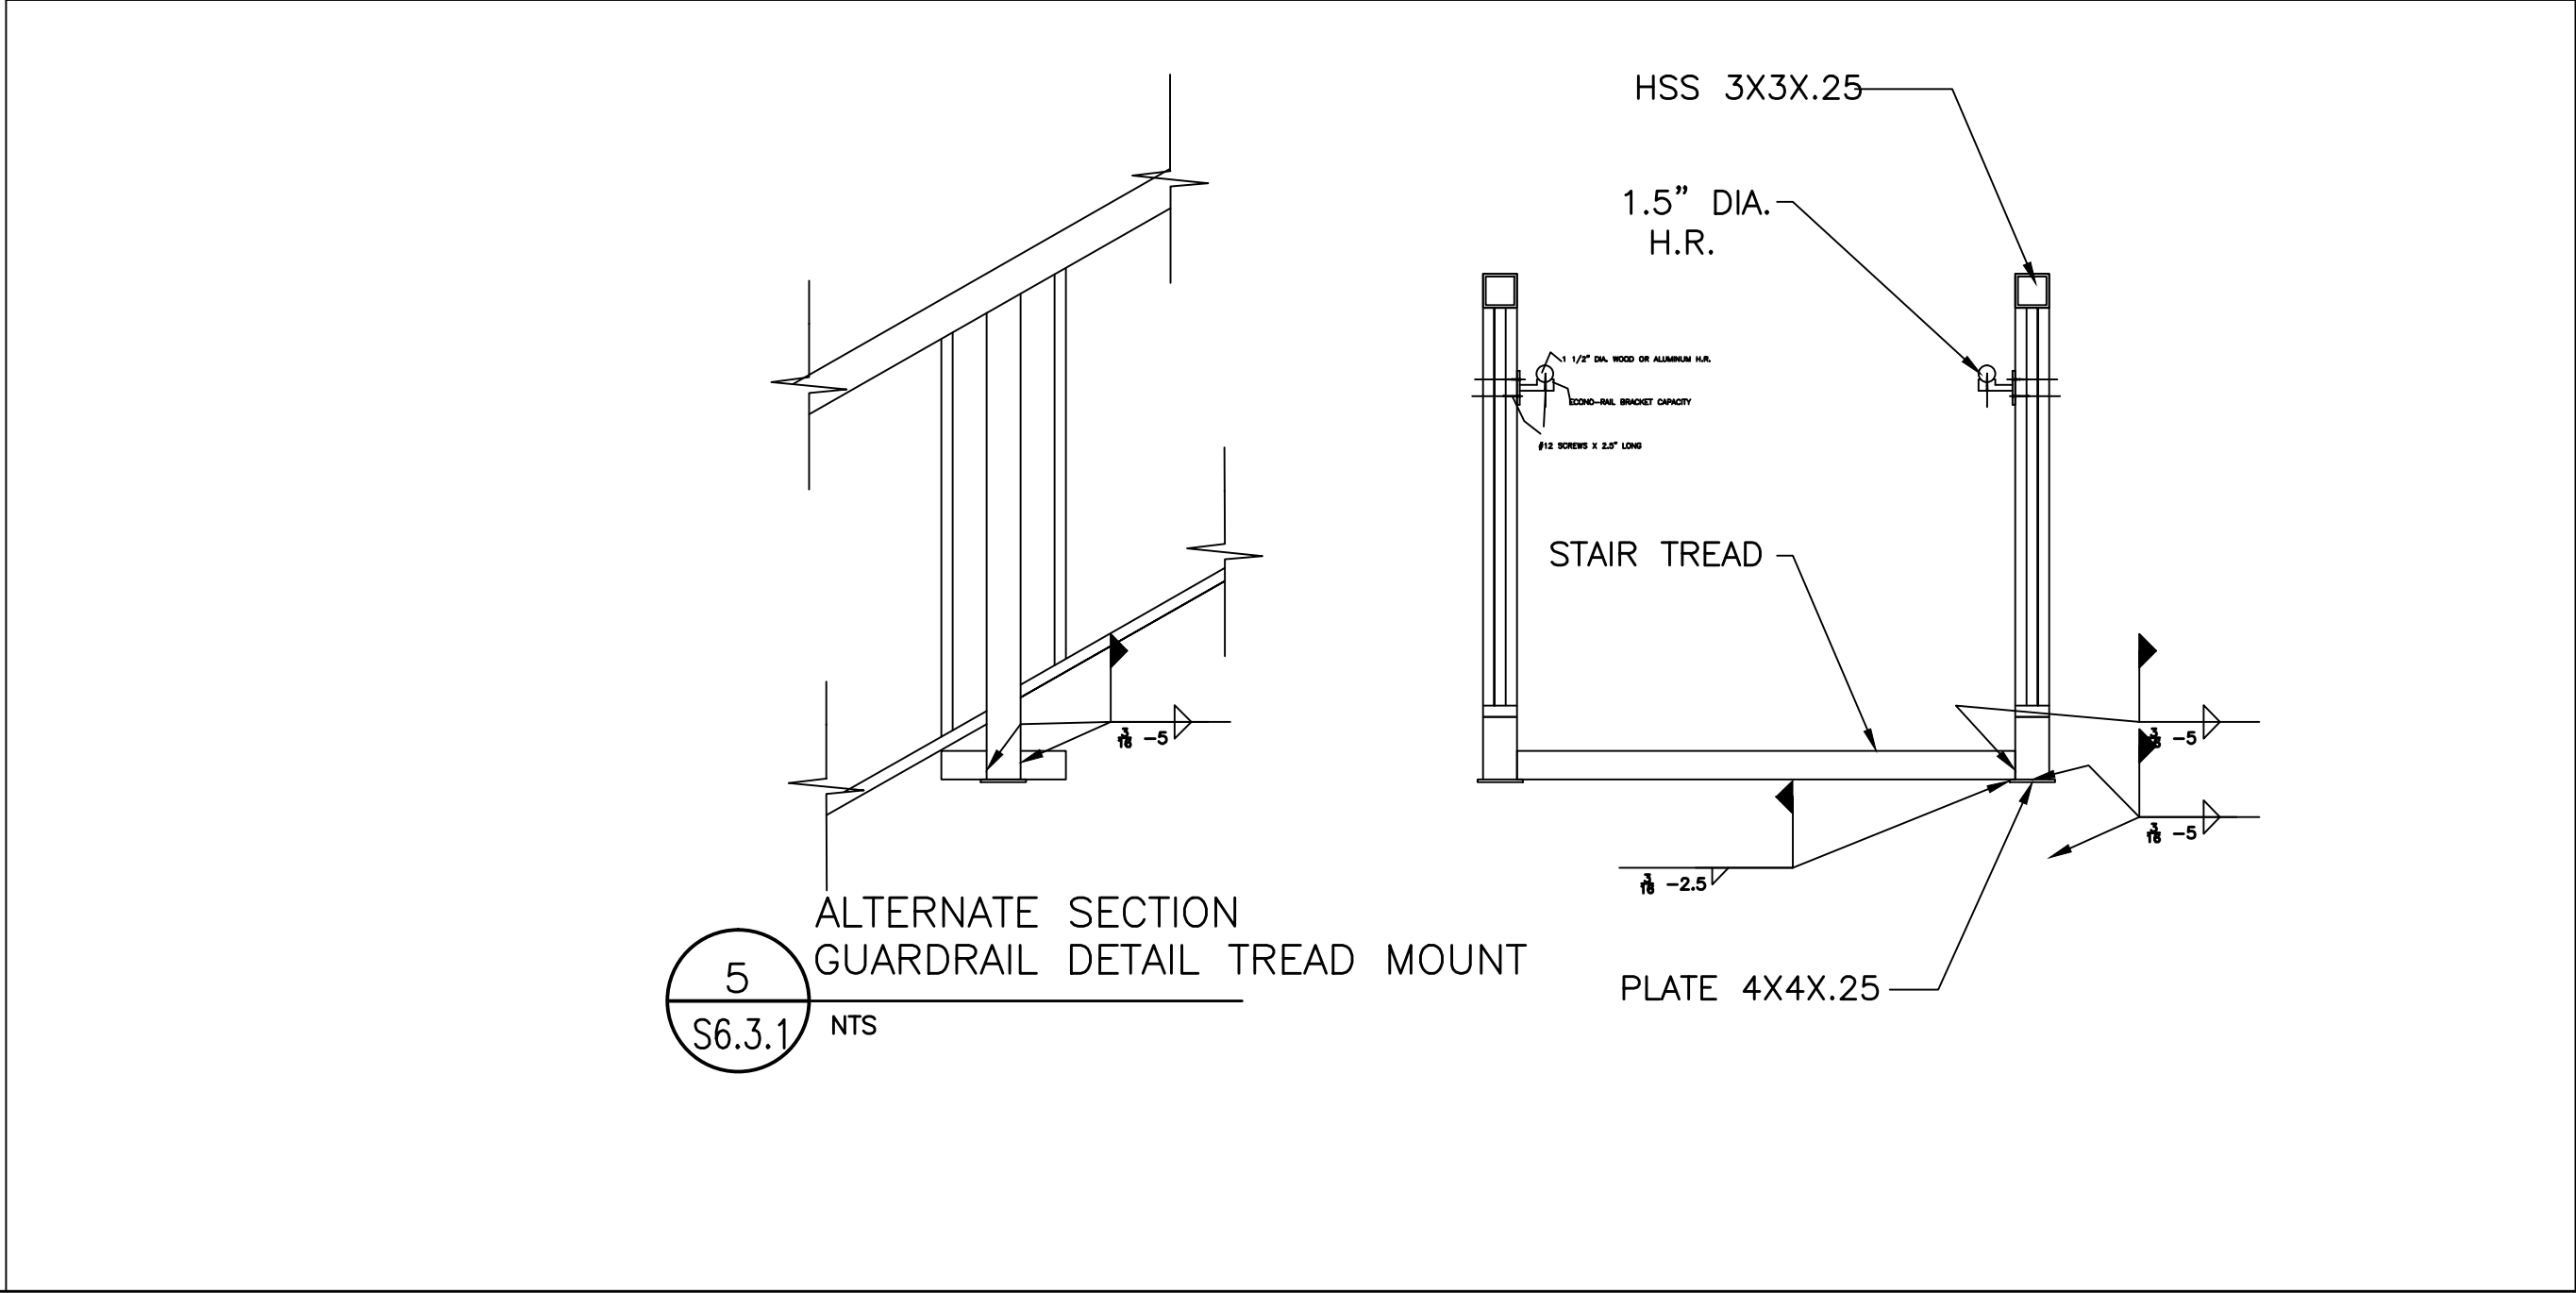
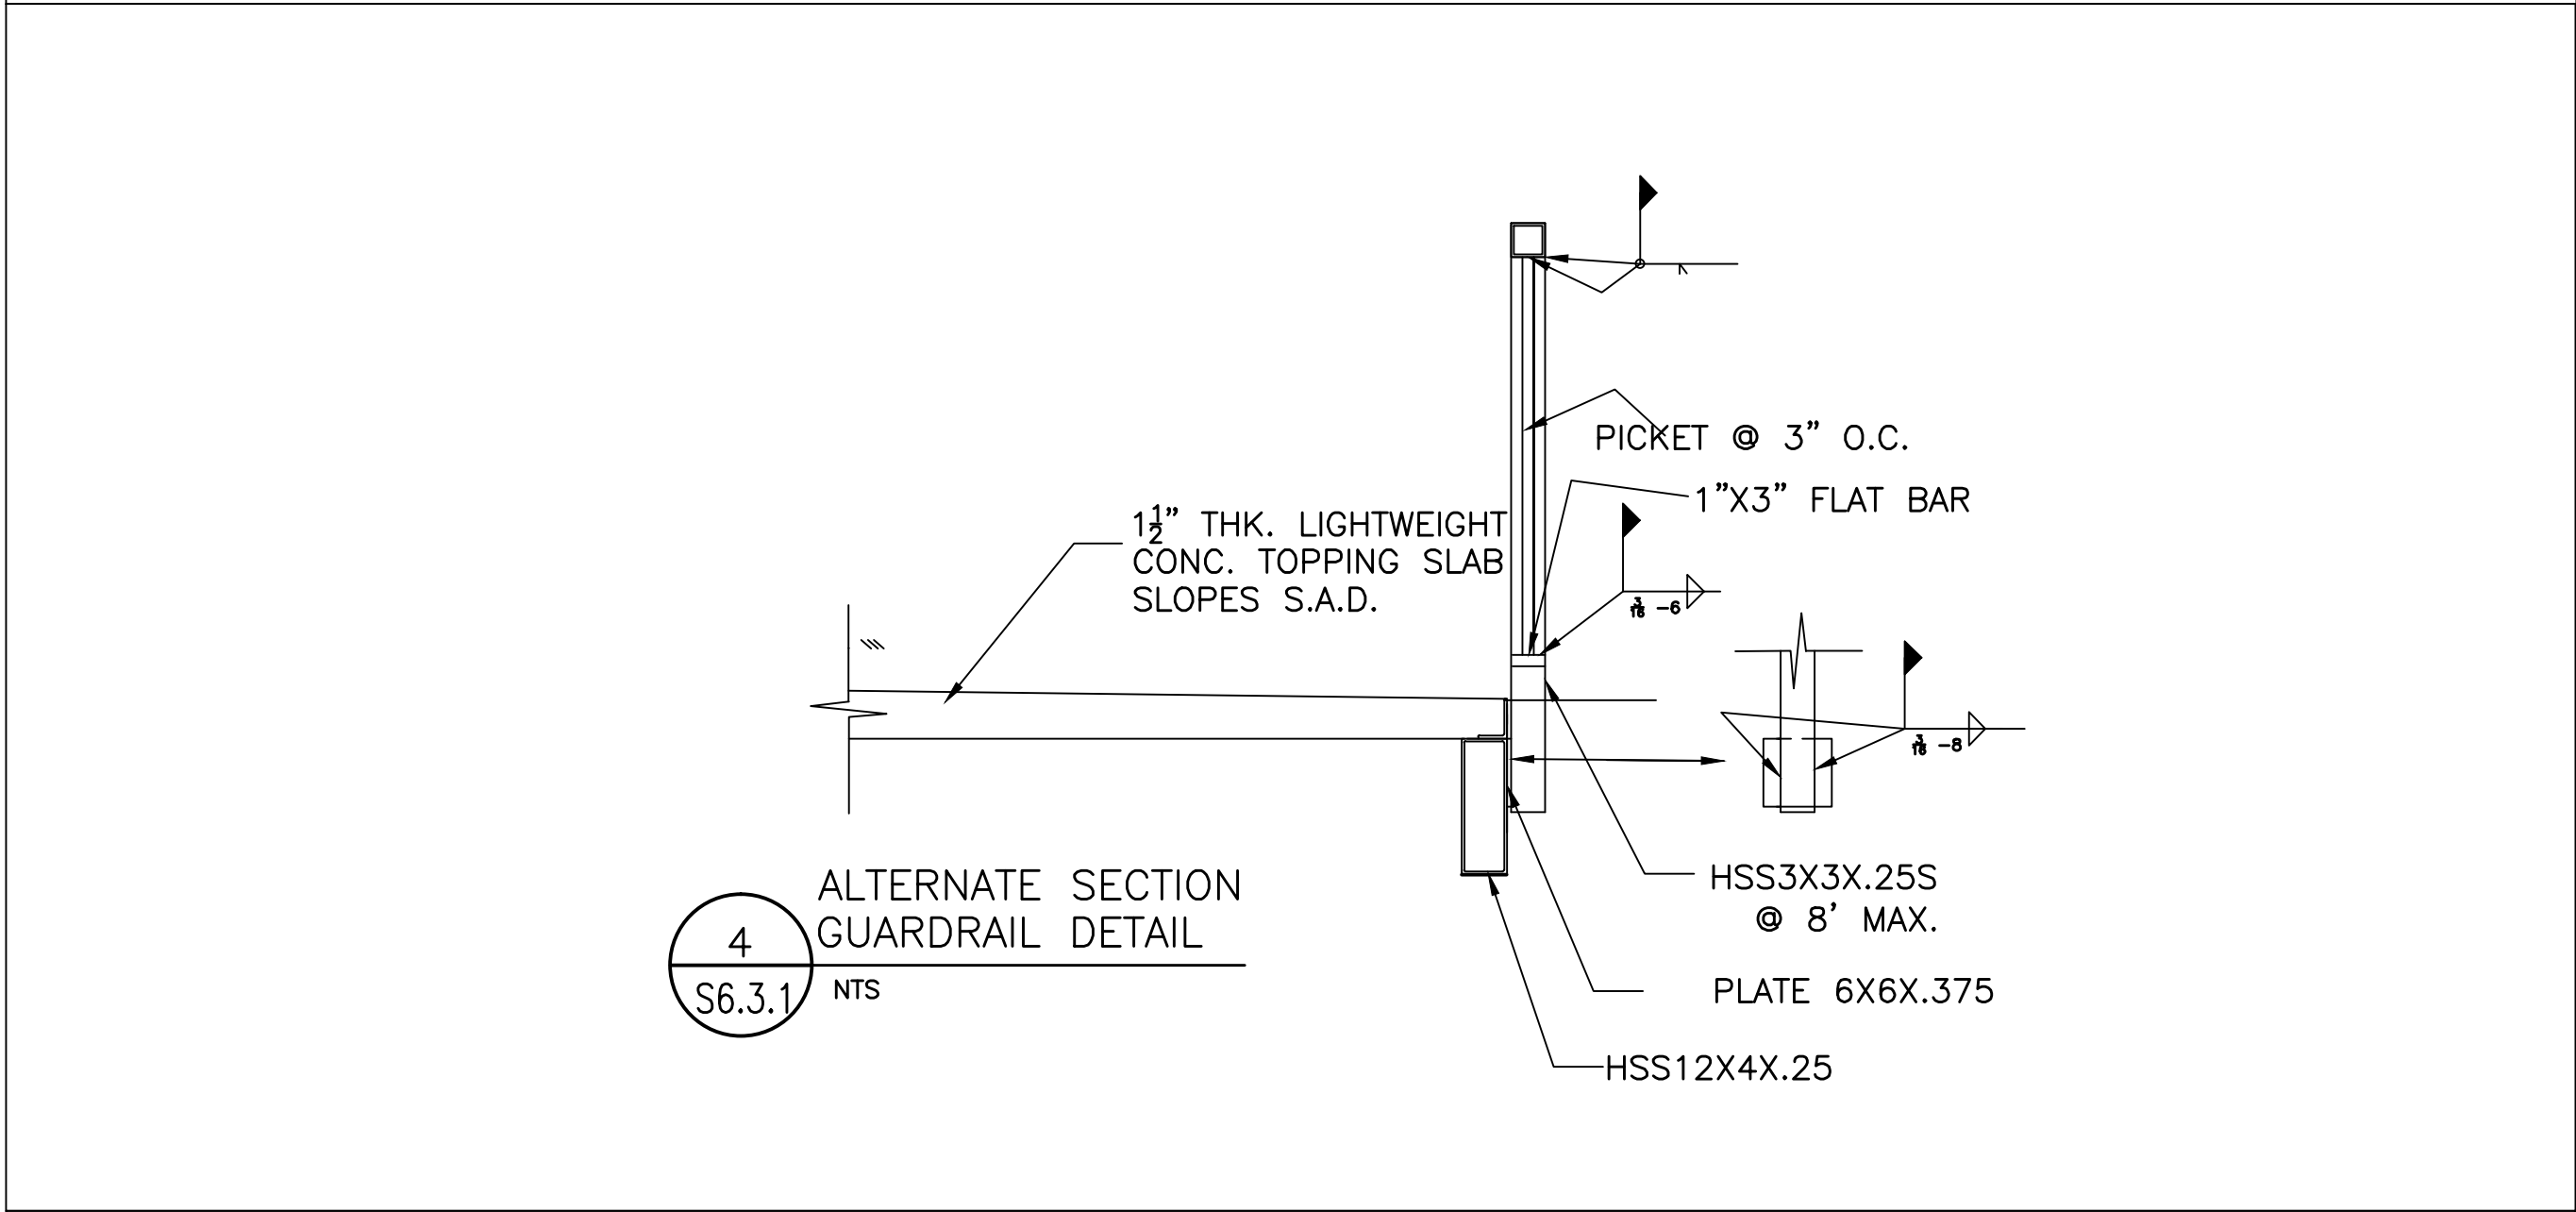
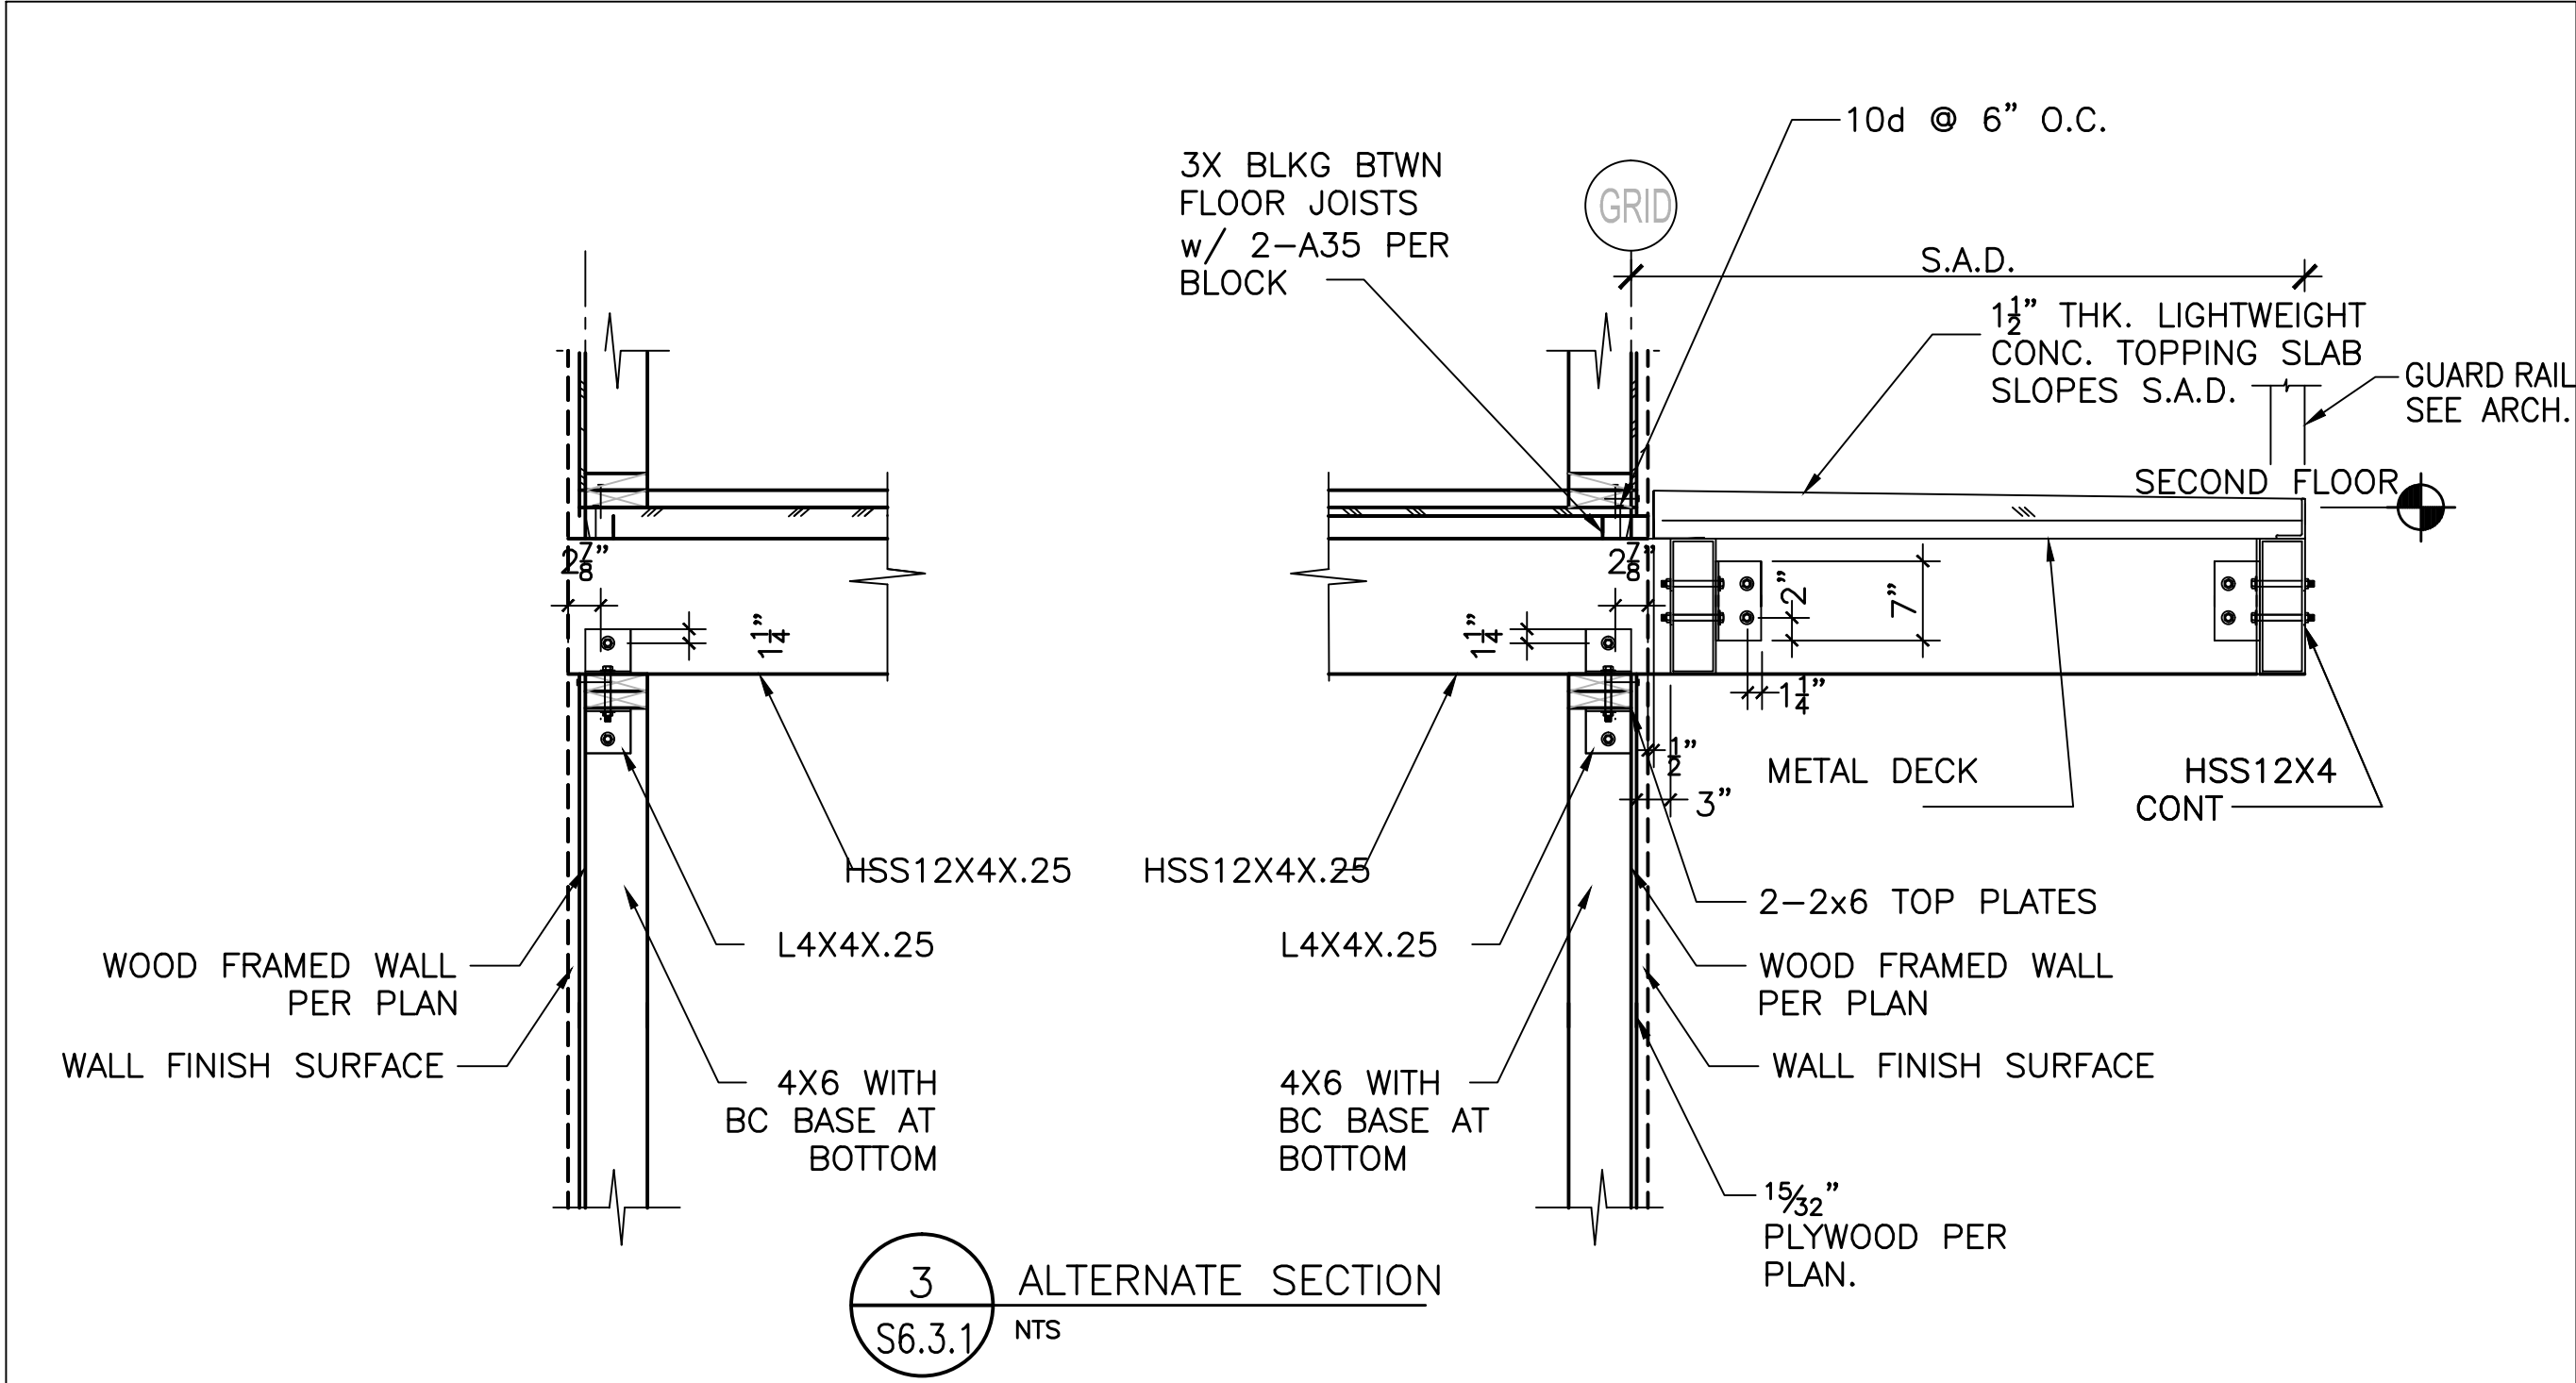
REGISTERED PROFESSIONAL ENGINEER  
JOSEPH OAKLEY  
No. 2000  
Exp. 09/30/11  
STRUCTURAL  
STATE OF CALIFORNIA

PROJECT TITLE:  
**COMMUNITY CENTER**  
HARBOR PARK APARTMENTS  
969 PORTER STREET, VALLEJO, CA 94560  
DRAWING TITLE:  
**WOOD FRAMING DETAILS**

OAKLEY & OAKLEY  
REGISTERED PROFESSIONAL ENGINEERS  
1000 CALIFORNIA DRIVE, SUITE 615  
OAKLAND, CA 94612  
TEL: 510.566.6043  
FAX: 510.566.6043

Date:	08/30/2011
Scale:	AS NOTED
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Job No.:	2011-09
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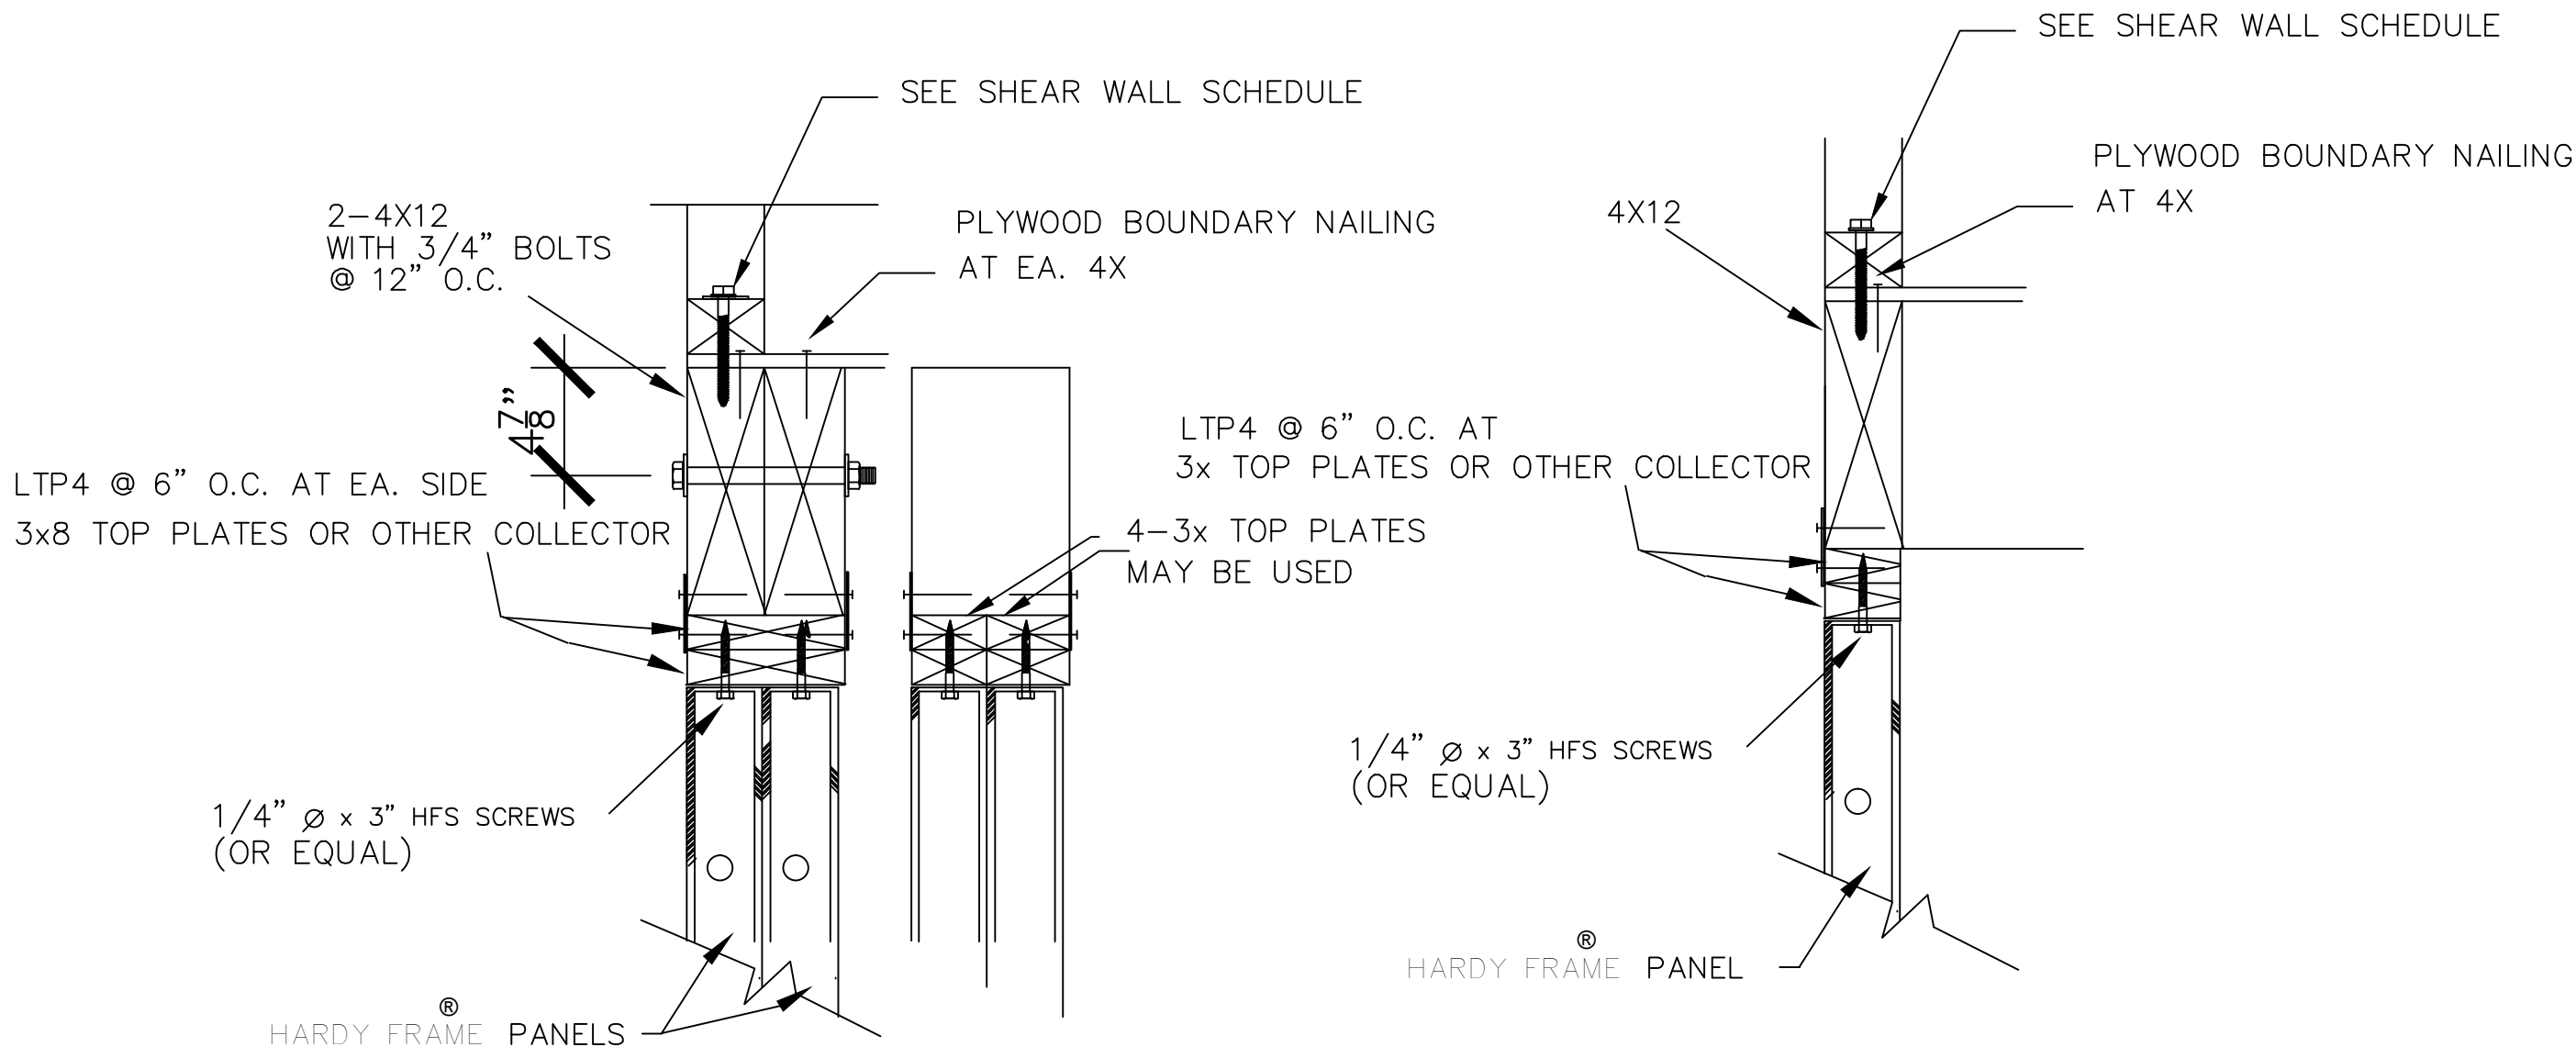
REGISTERED PROFESSIONAL ENGINEER  
JOSEPH OAKLEY  
No. 2000  
Exp. 09/30/11  
STRUCTURAL  
STATE OF CALIFORNIA

OAKLEY & OAKLEY  
ARCHITECTS & STRUCTURAL ENGINEERS  
1000 CALIFORNIA DRIVE, SUITE 615  
OAKLAND, CA 94612  
TEL: 510.566.2600  
FAX: 510.566.2604

PROJECT TITLE  
COMMUNITY CENTER  
HARBOR PARK APARTMENTS  
969 PORTER STREET, VALLEJO, CA 94580


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WOOD FRAMING DETAILS

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Of: 1 Sheets



## HARDY FRAME® SECTION AT TOP PLATES

### SINGLE FACE INSTALLATION











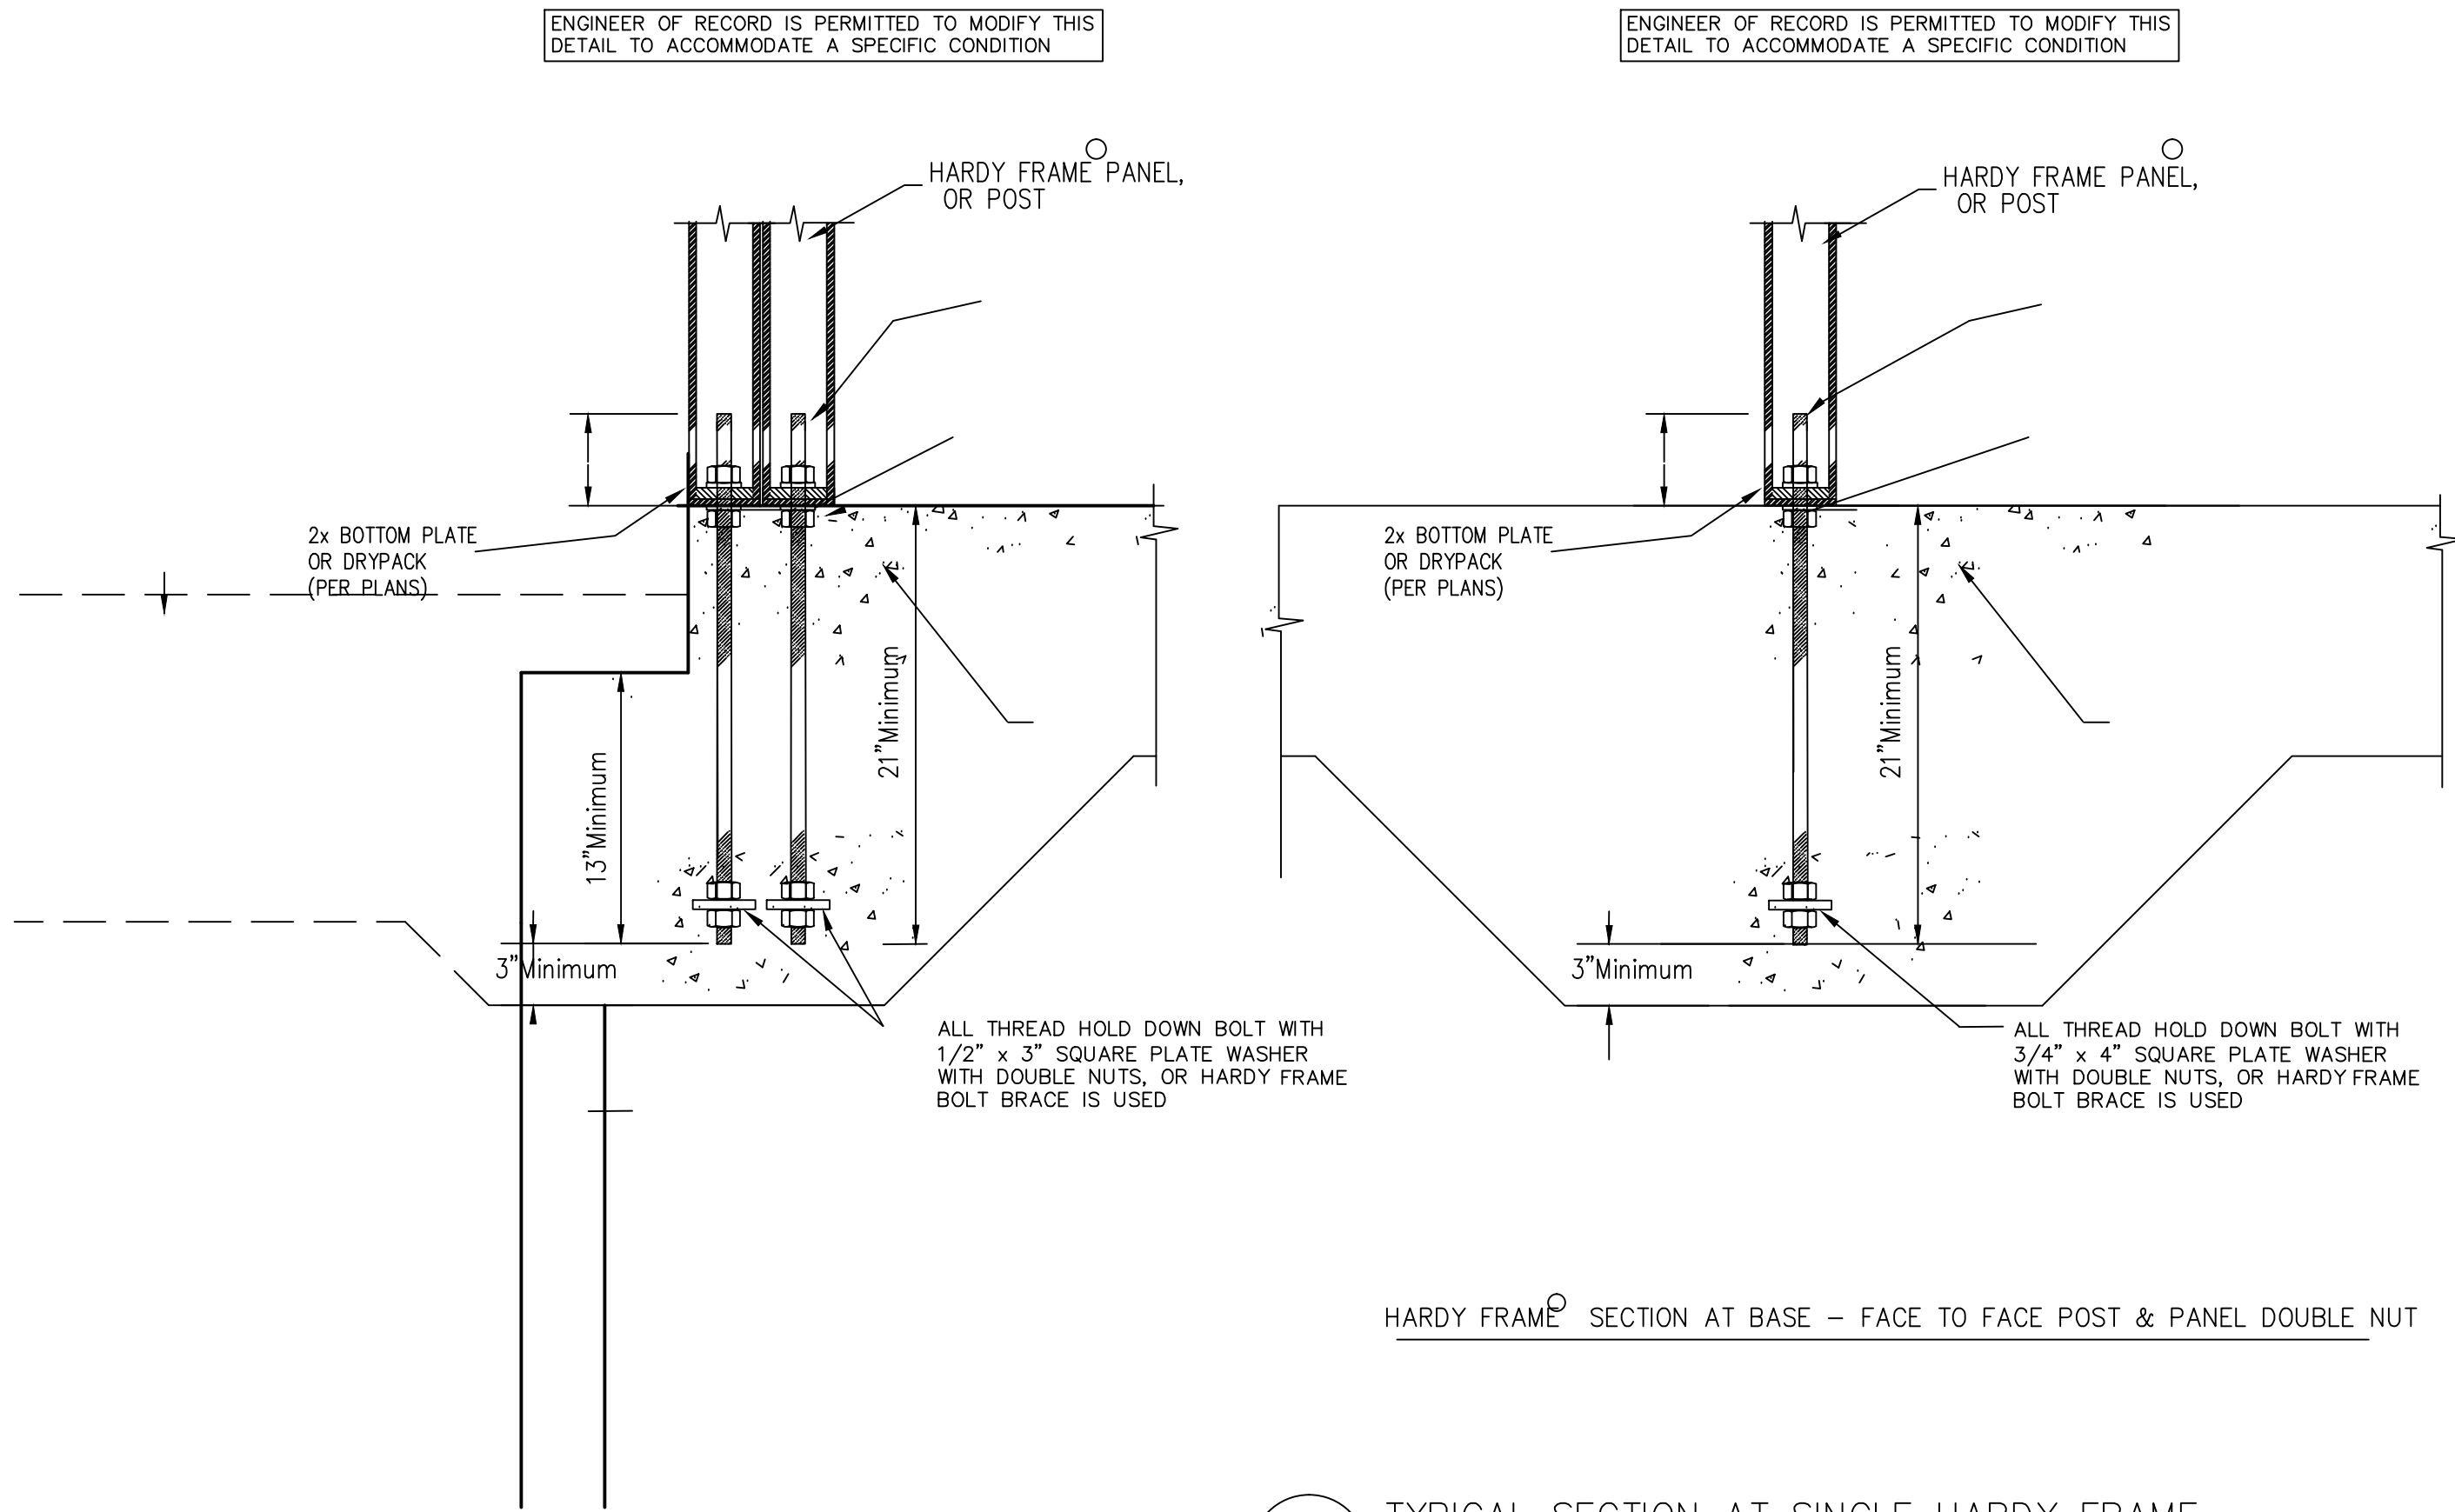


HARDY FRAME SECTION AT BASE - FACE TO FACE POST & PANEL DOUBLE NUT

3 TYPICAL SECTION AT SIDE BY SIDE HARDY FRAMES  
NO SCALE

**S3.21**  
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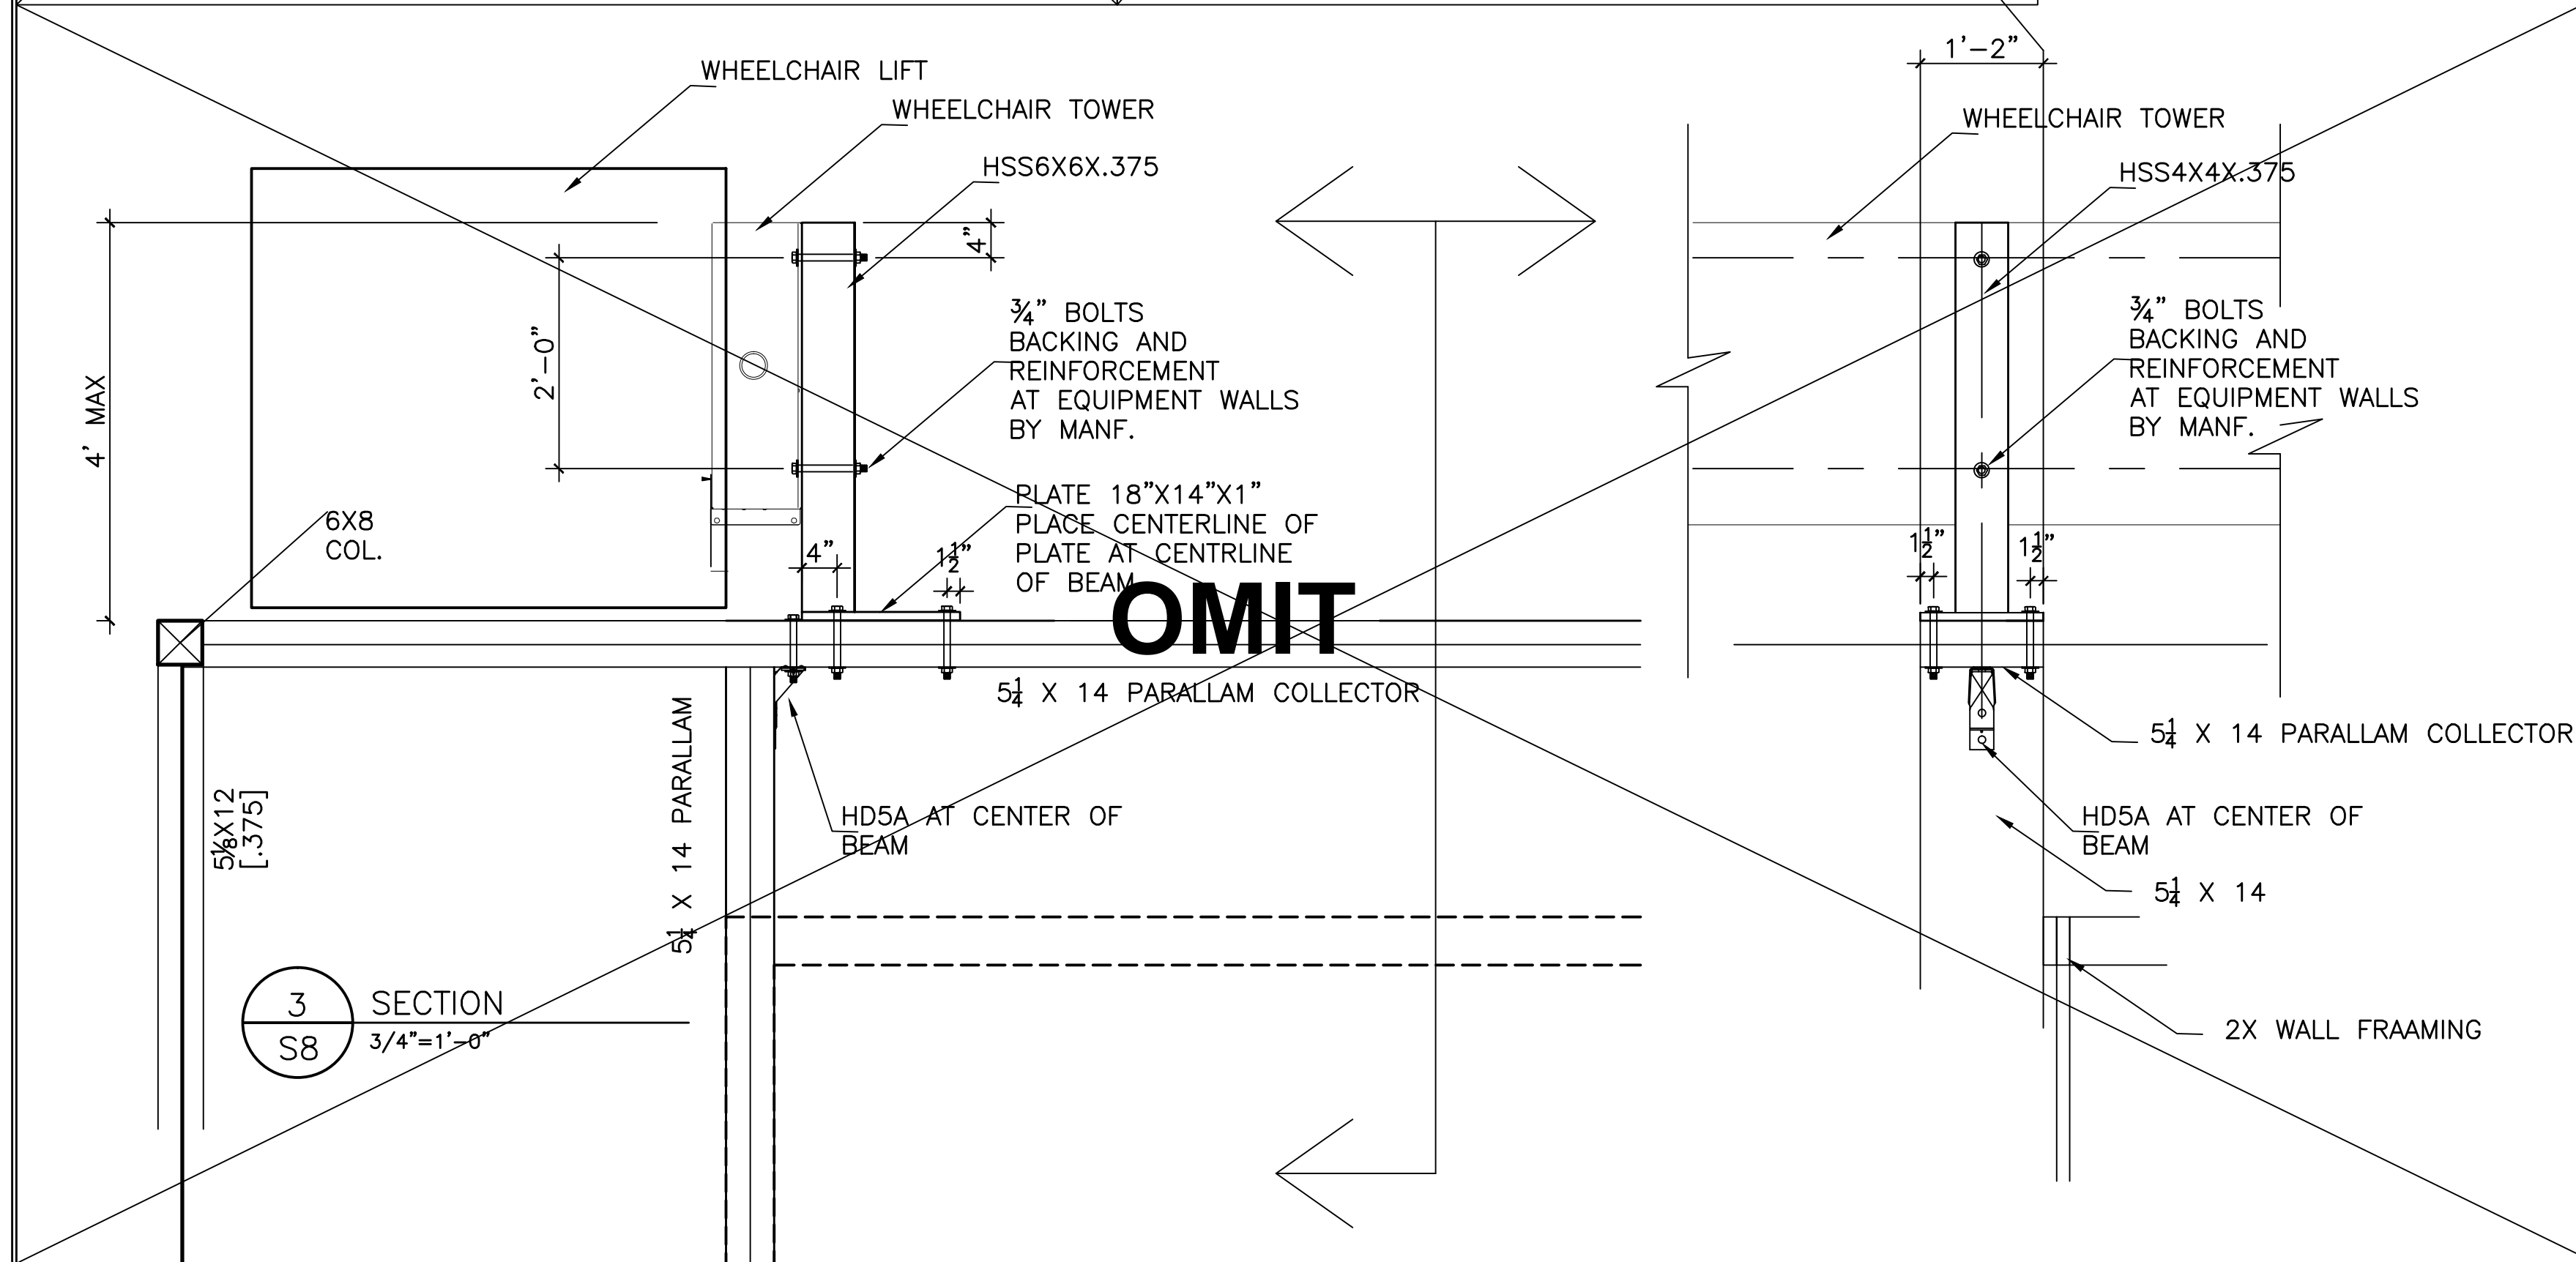
REVISIONS	BY
9/26/2011 - PLAN CHECK	G.O.

REGISTERED PROFESSIONAL ENGINEER  
JOSEPH OAKLEY  
No. 2000  
Exp. 09/30/11  
STRUCTURAL  
STATE OF CALIFORNIA

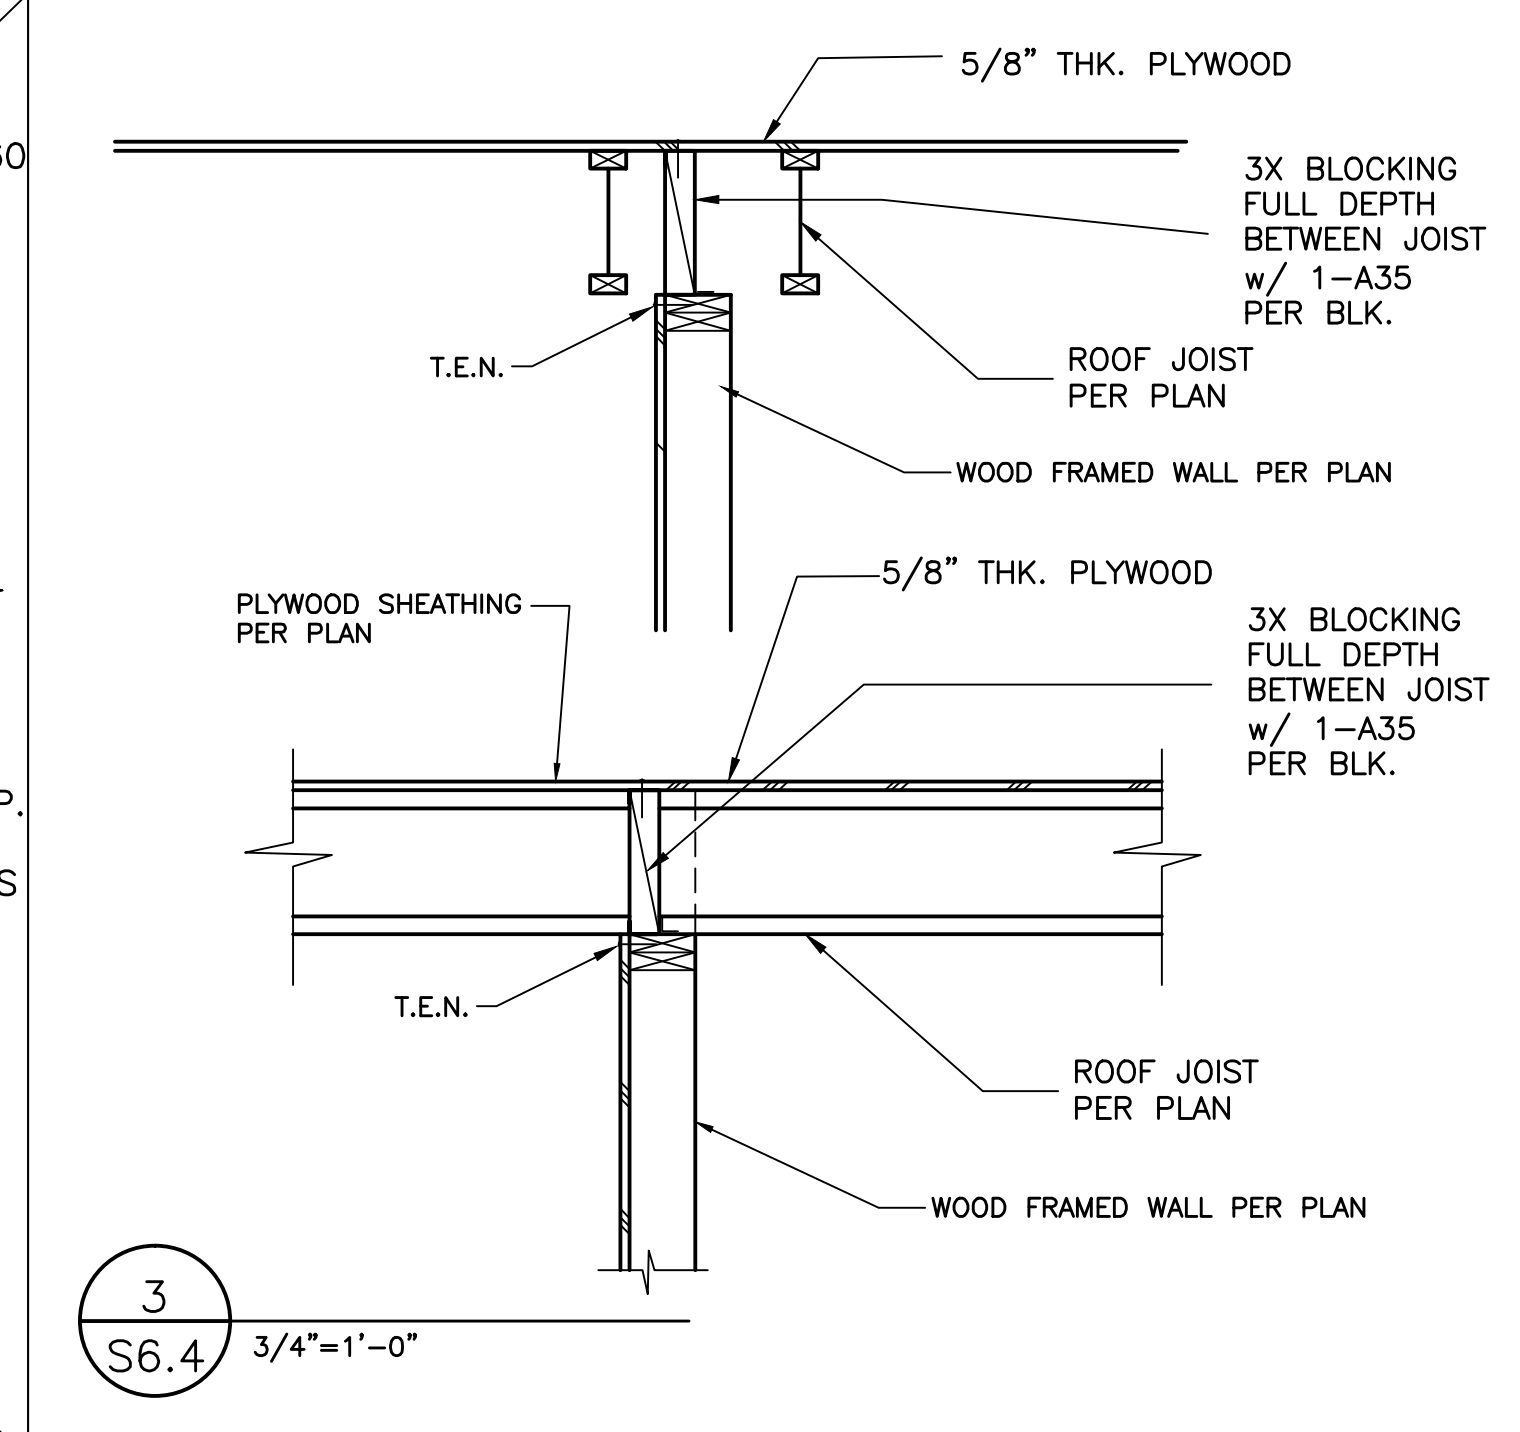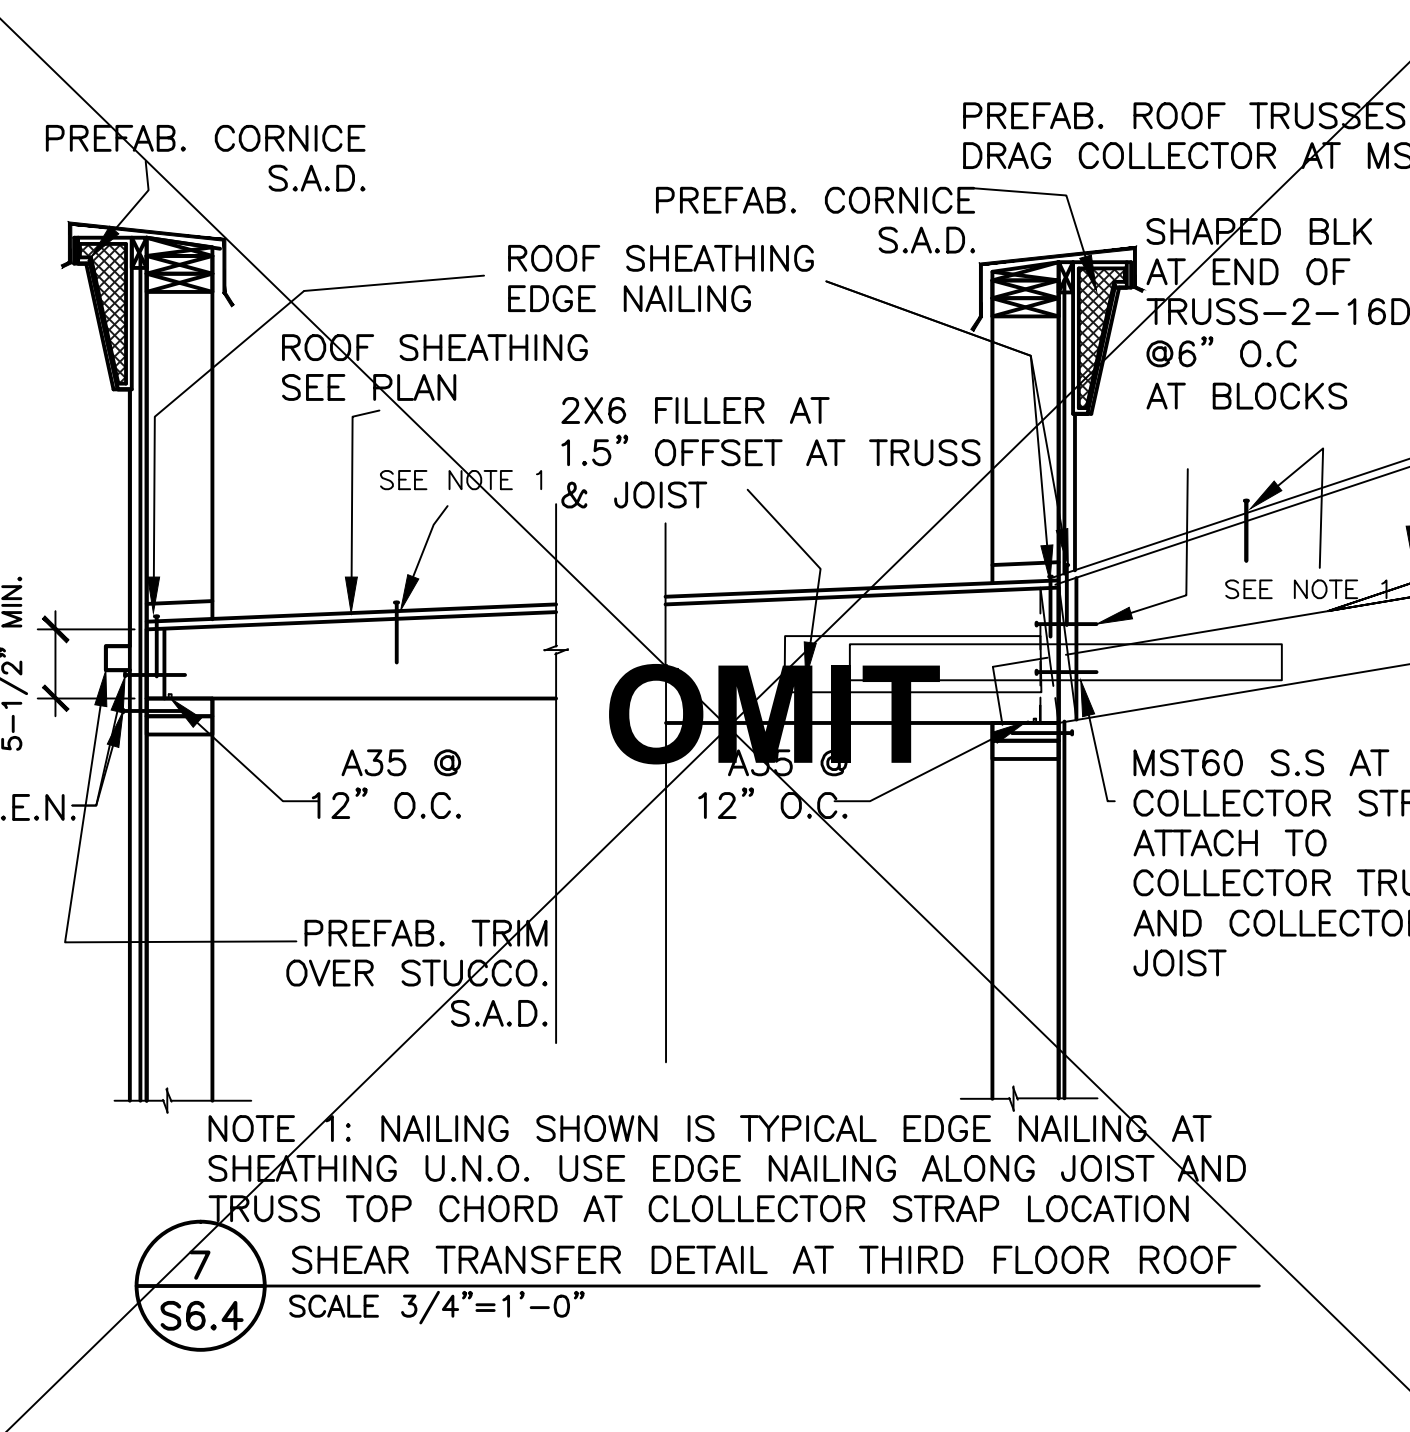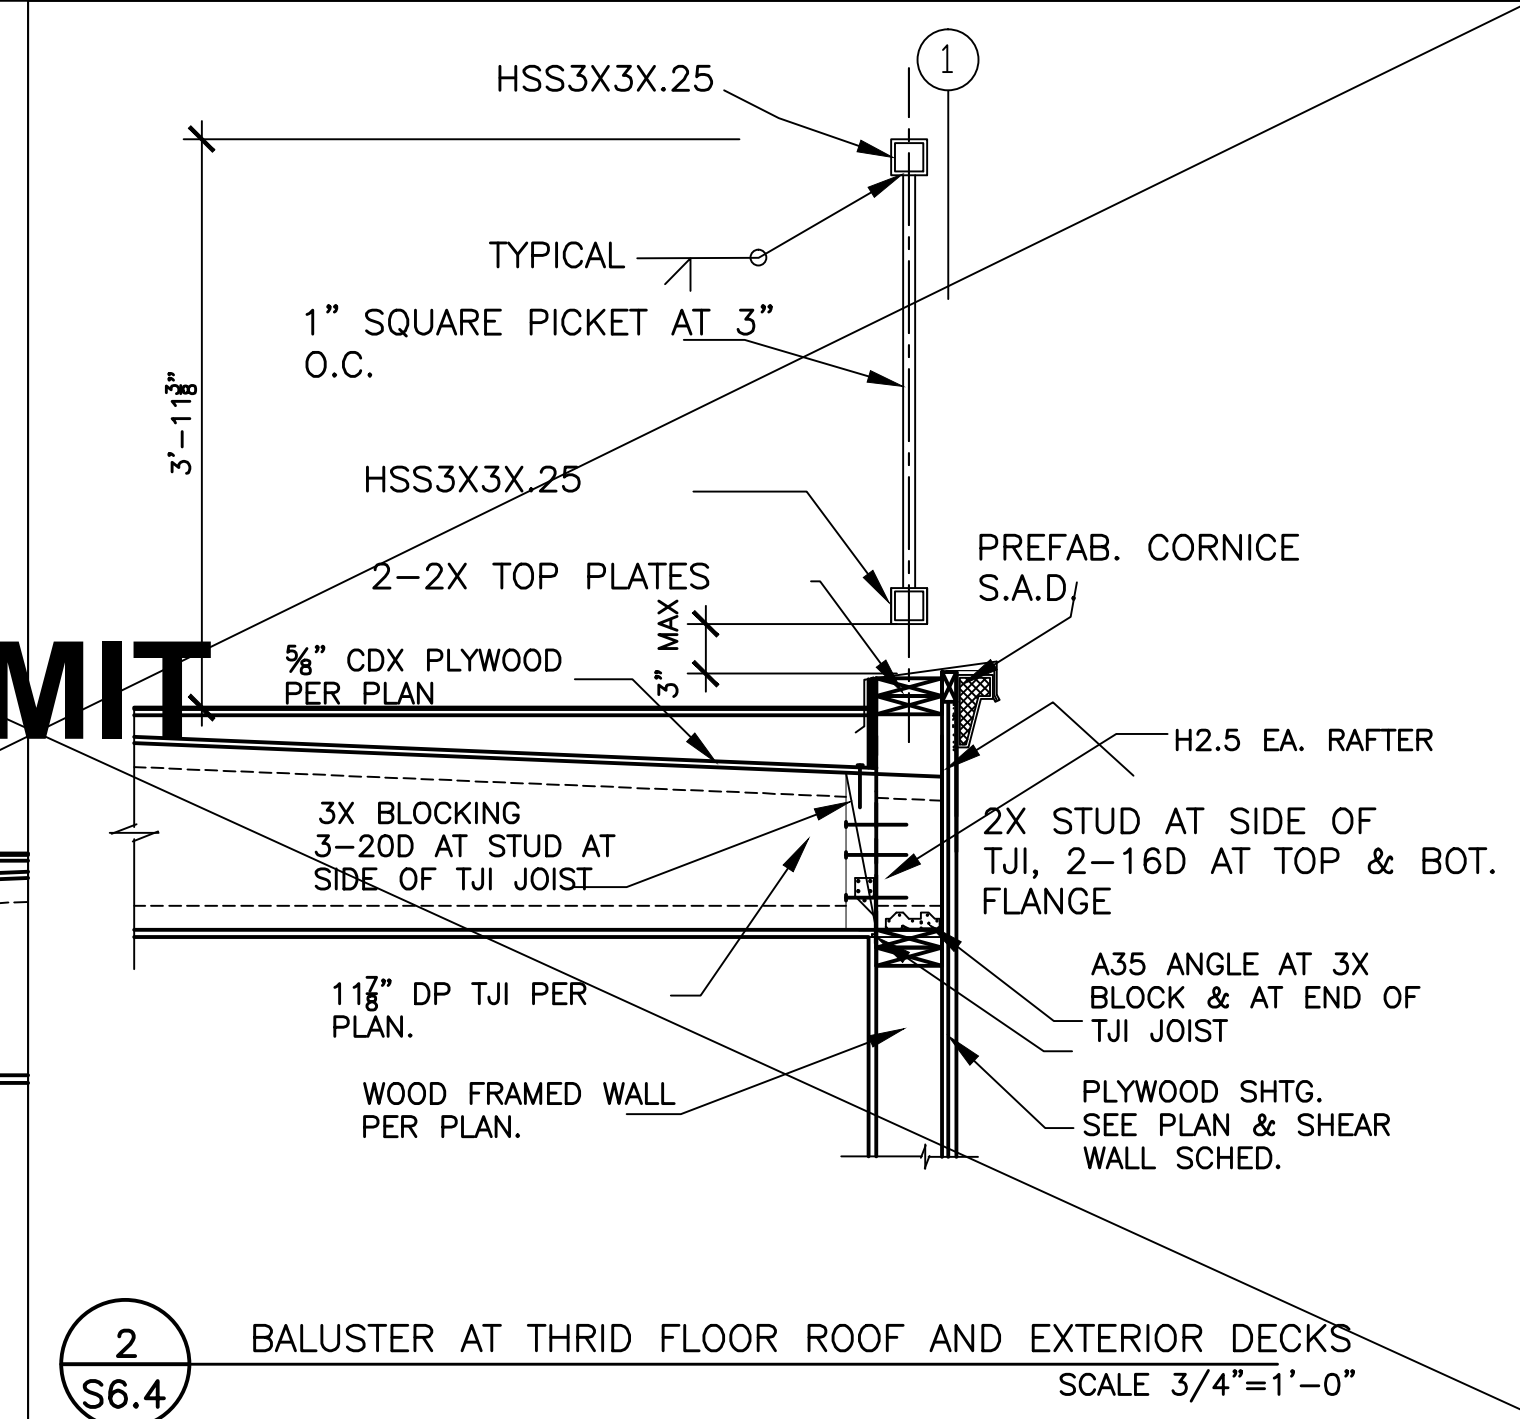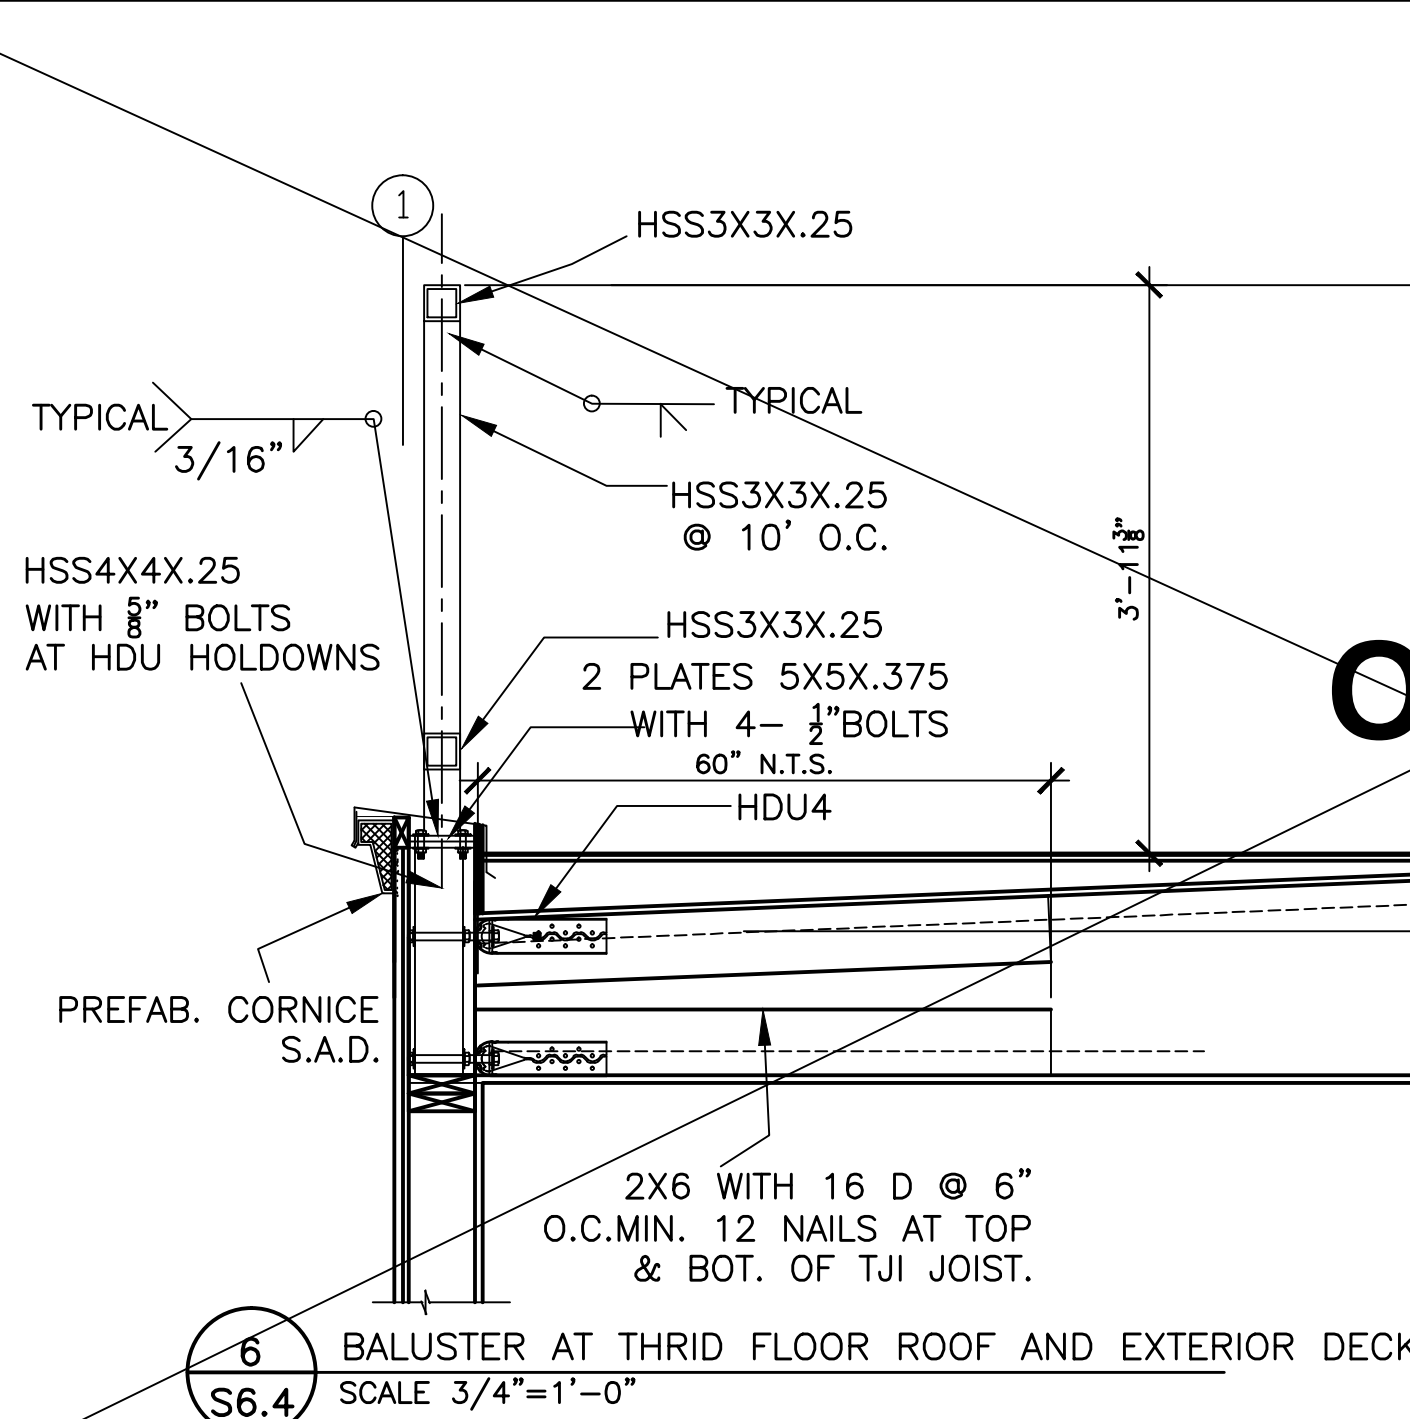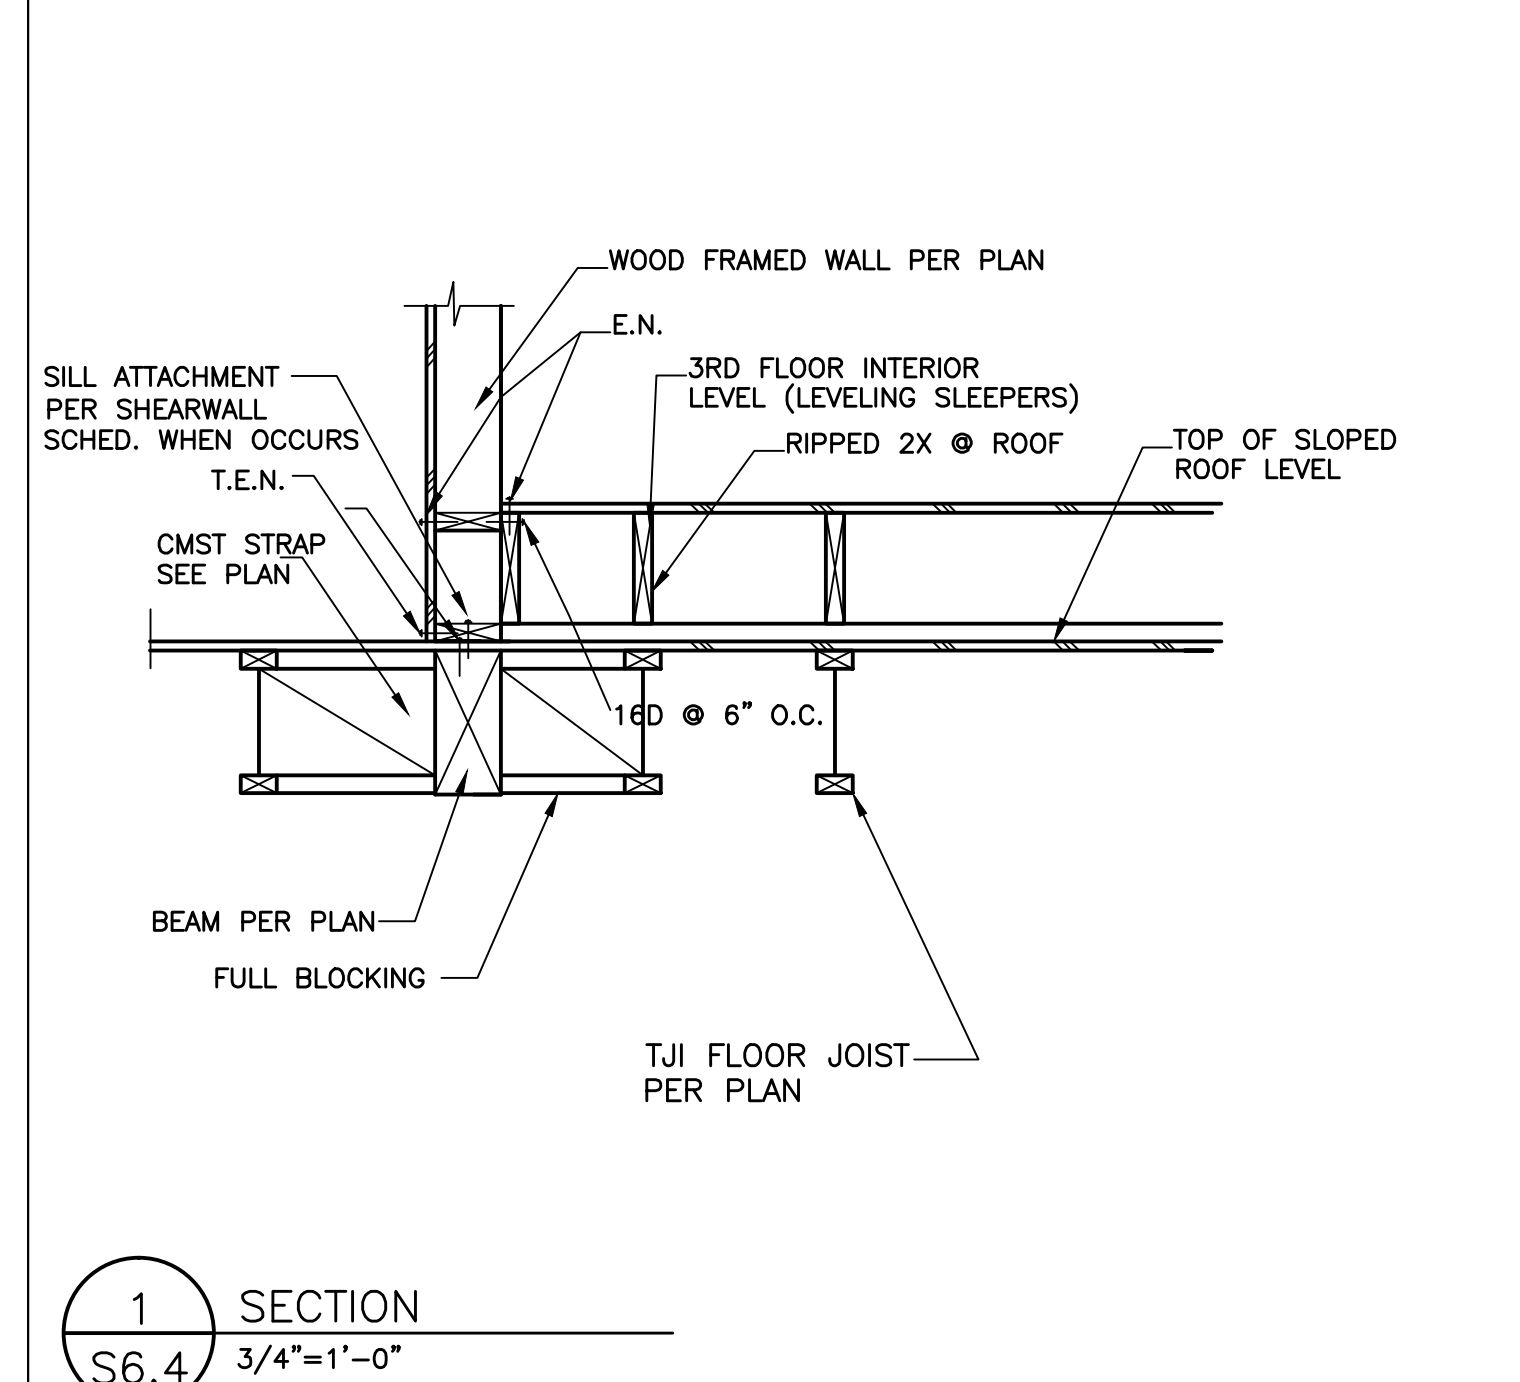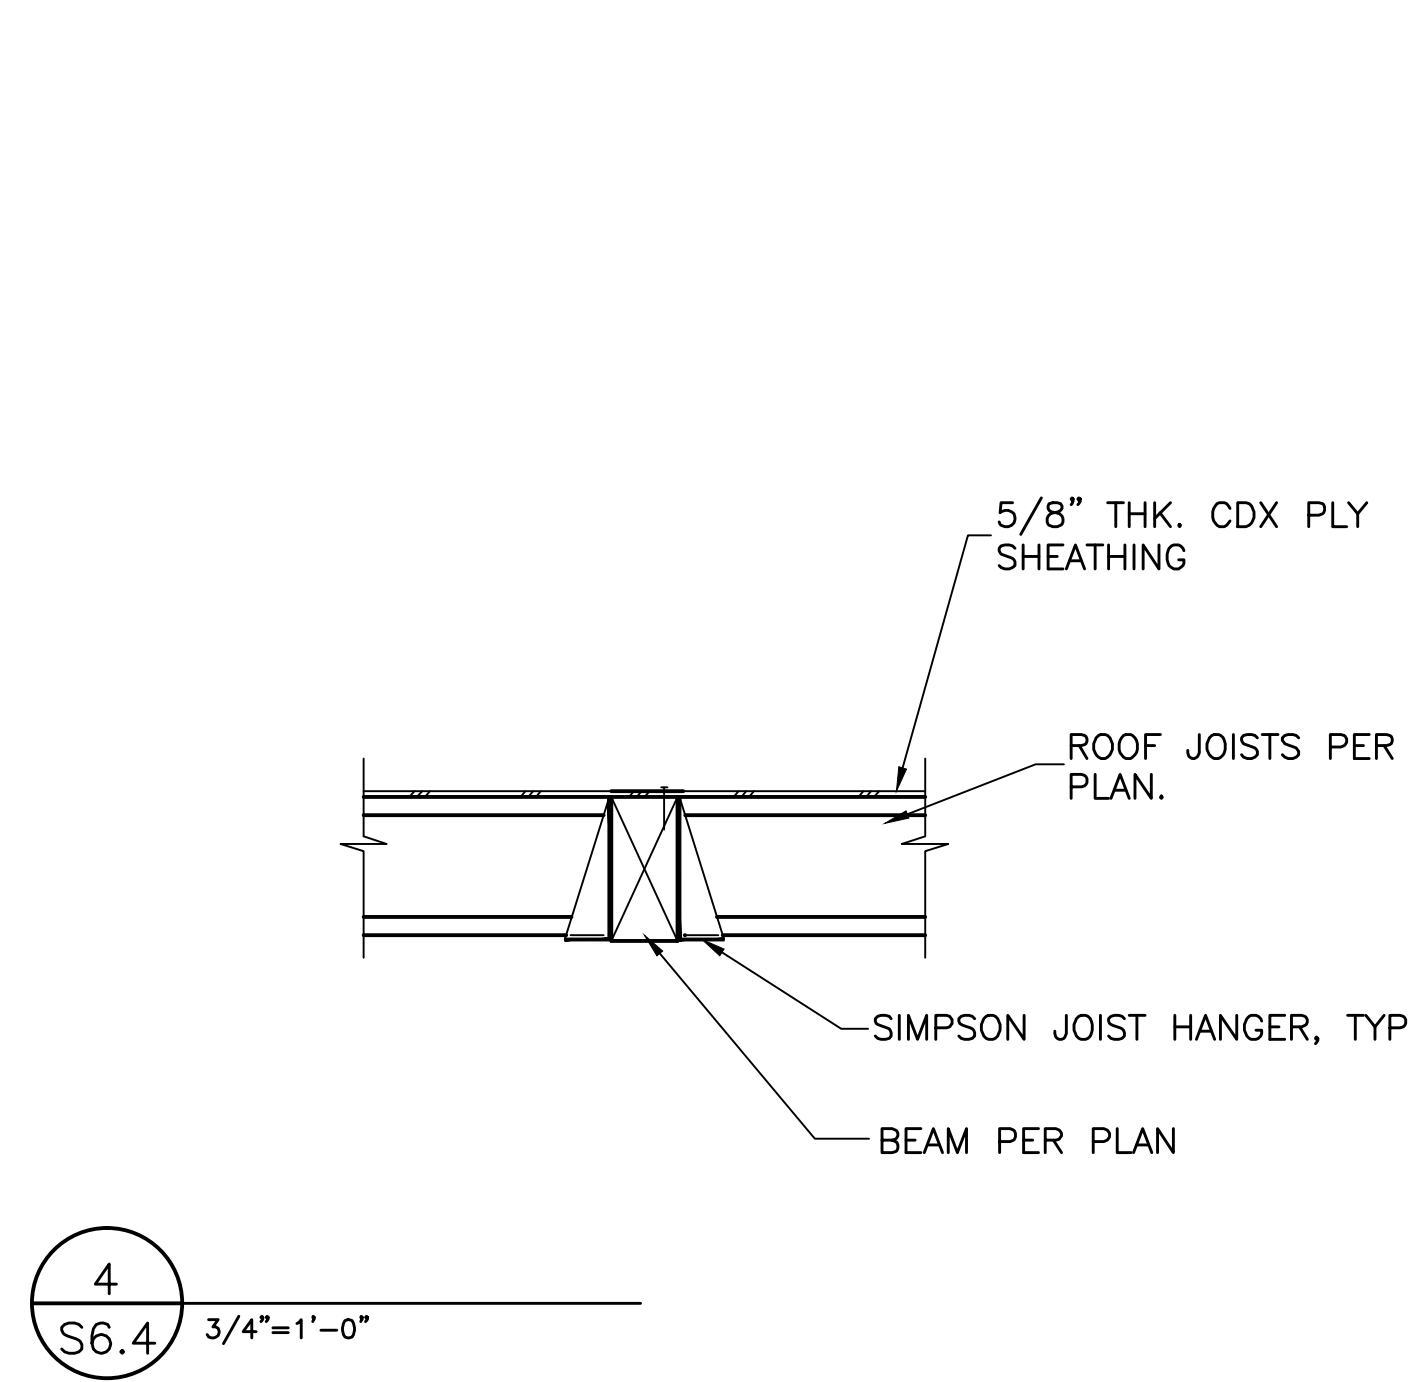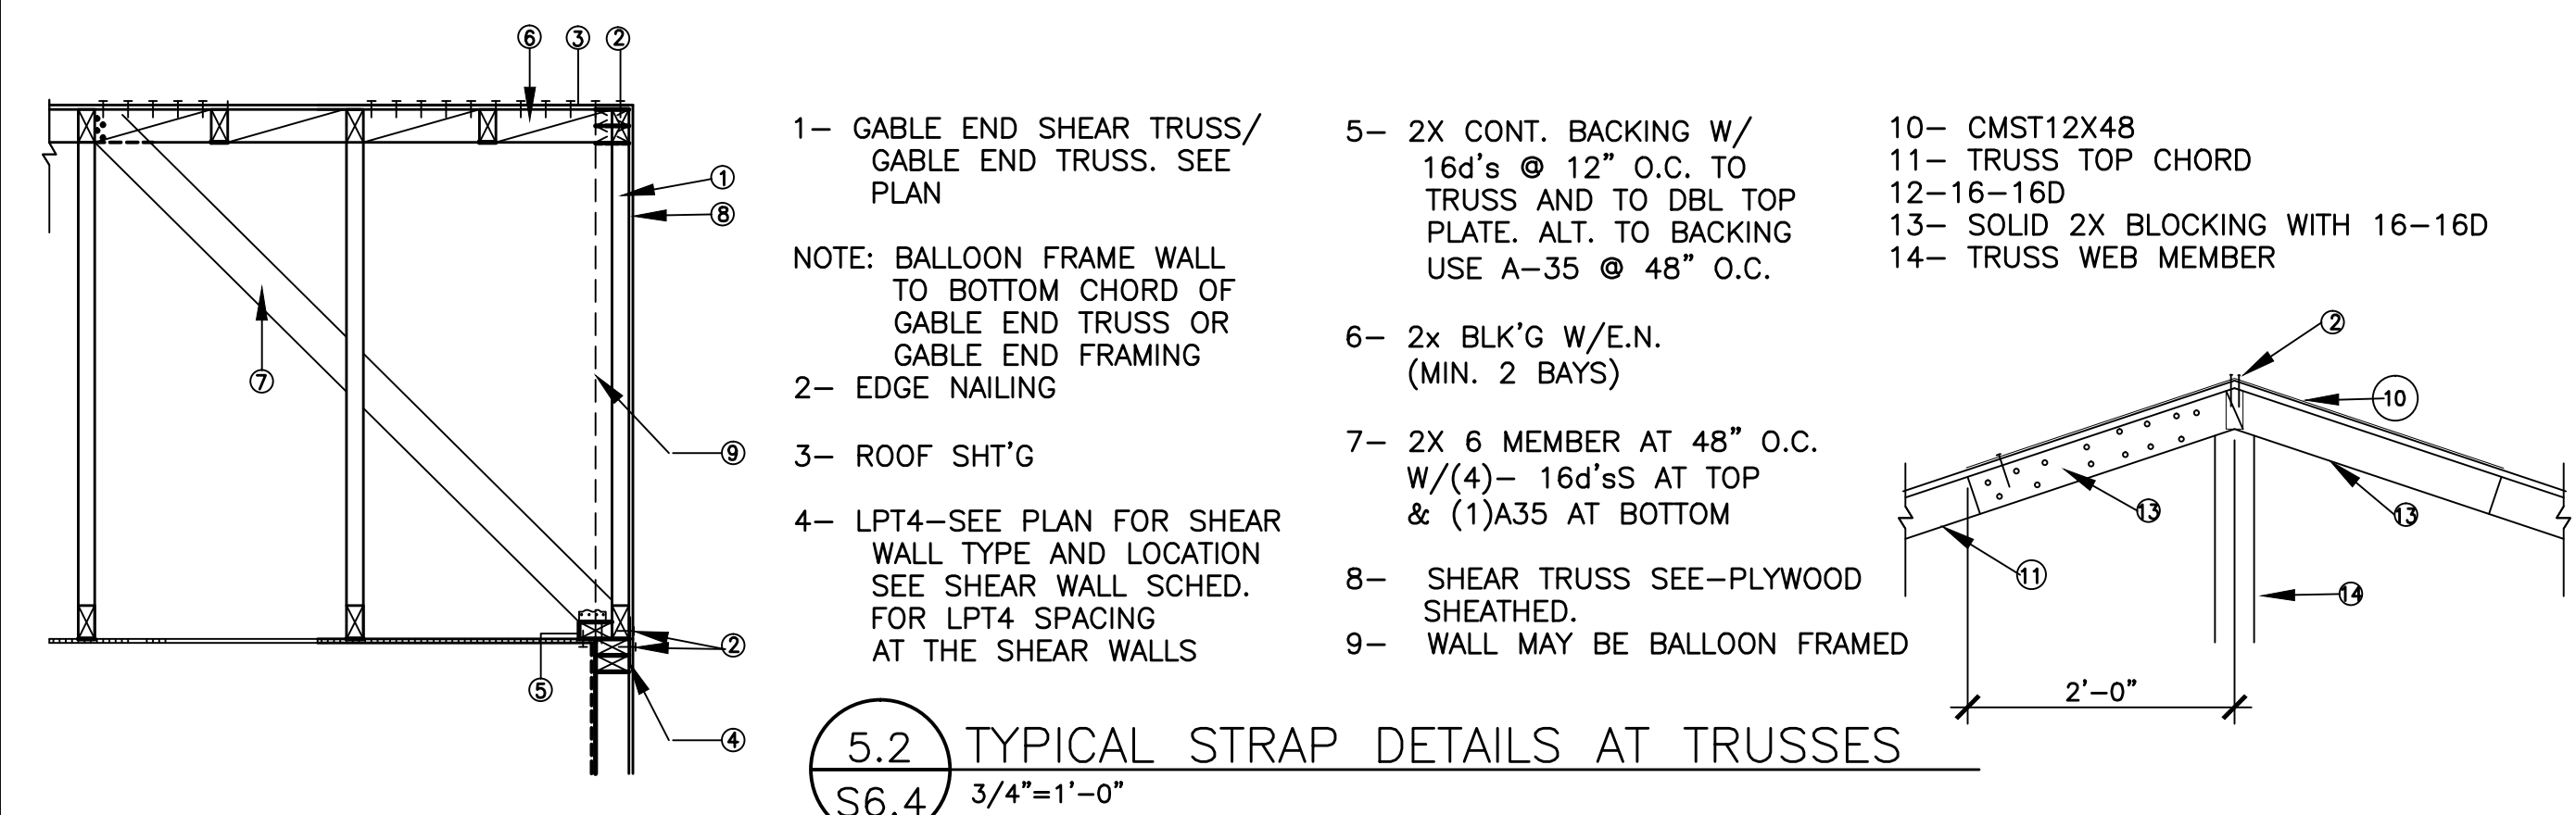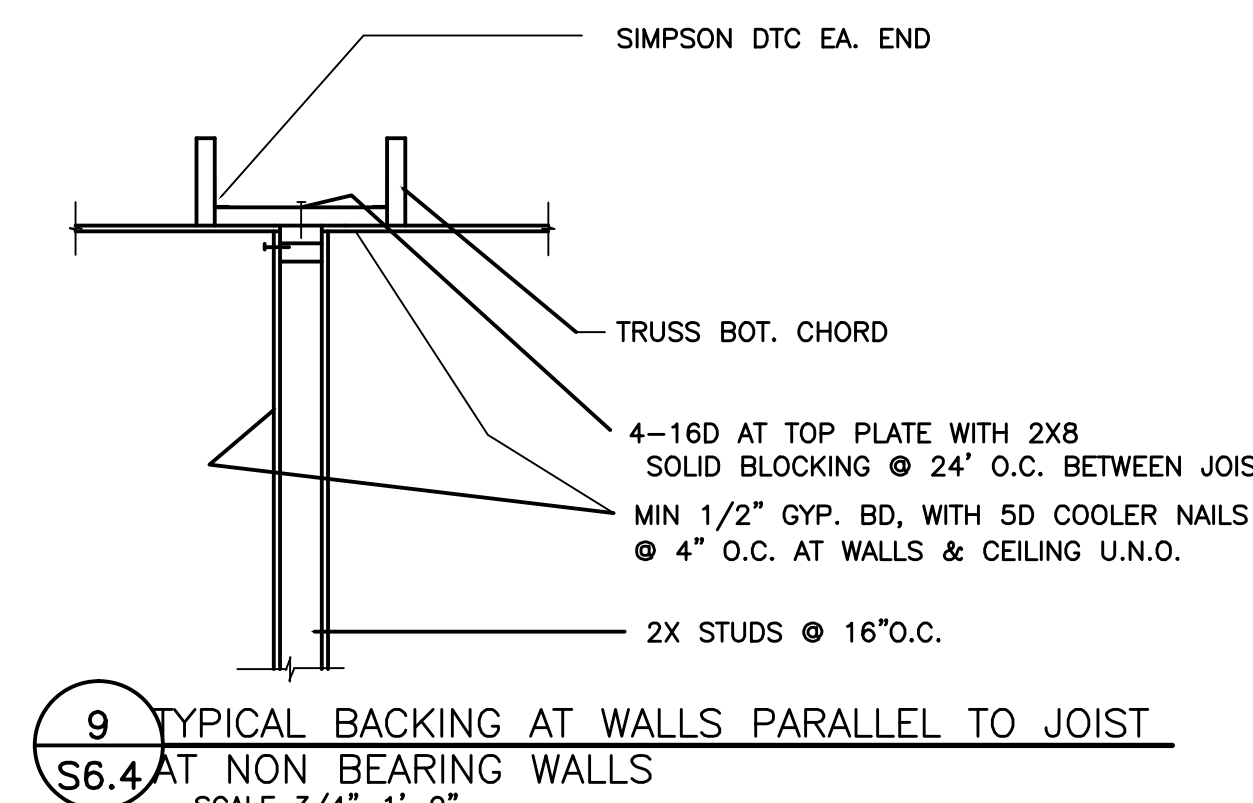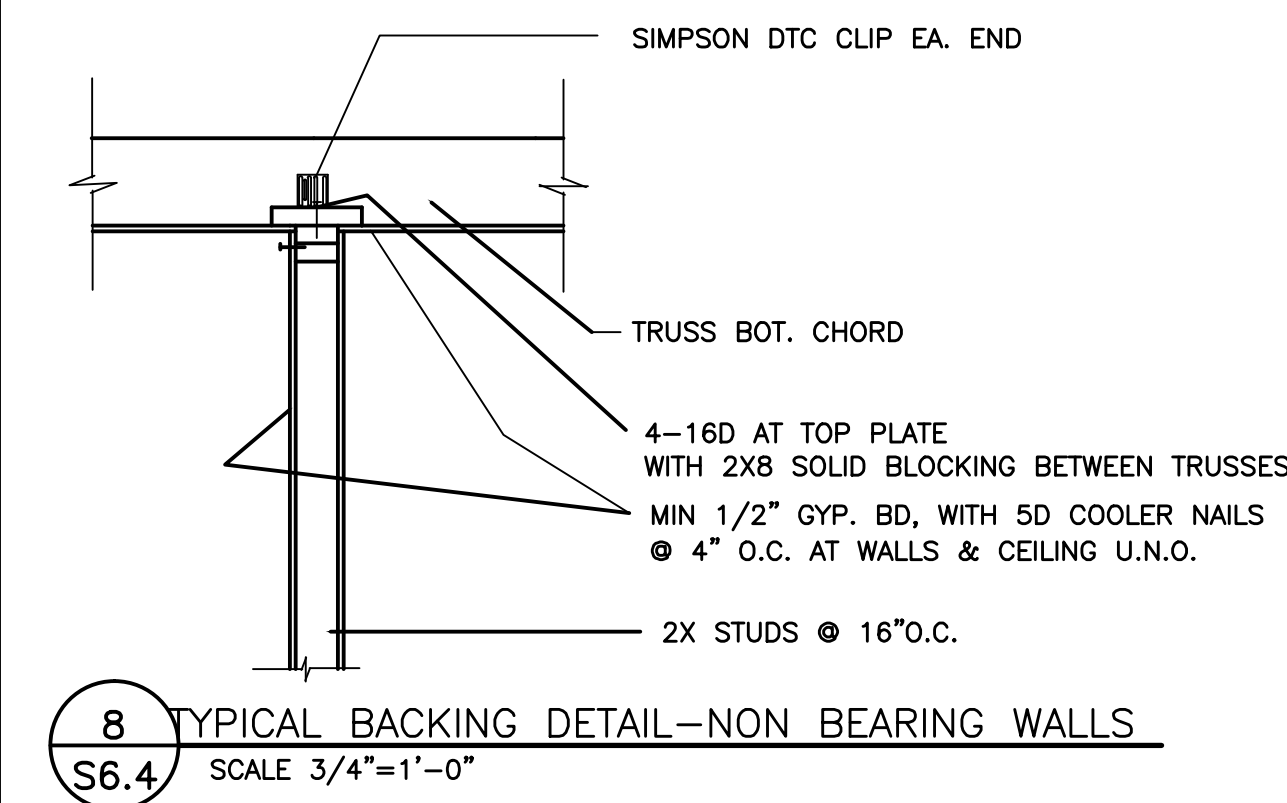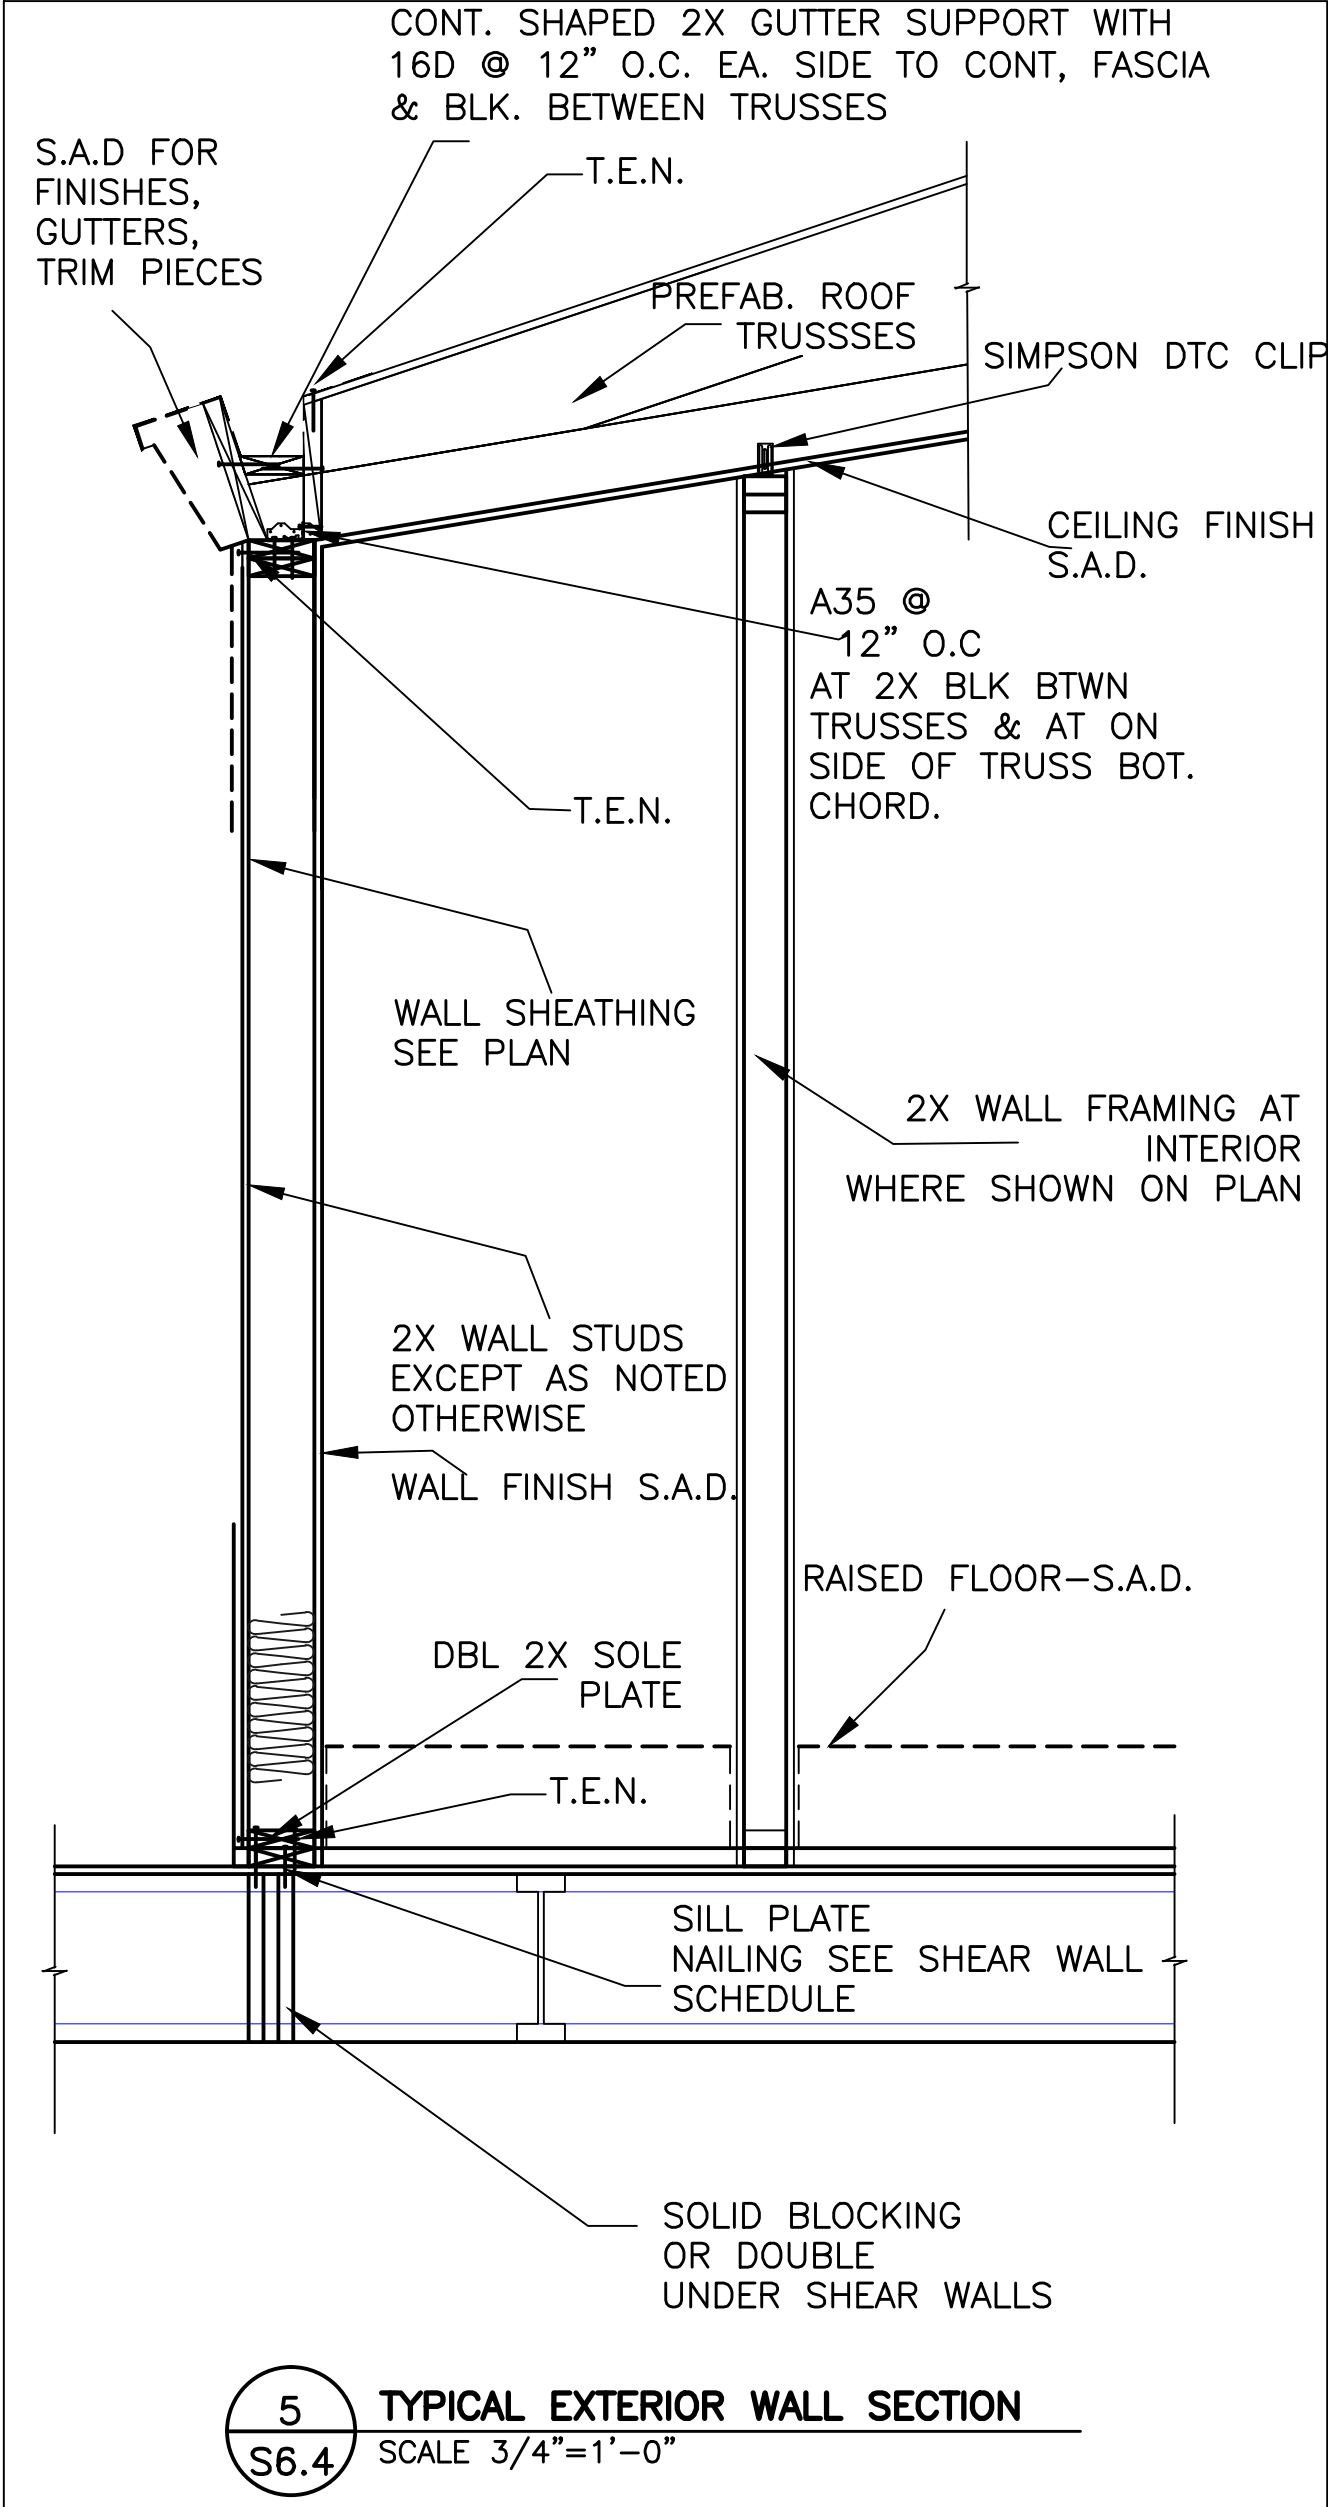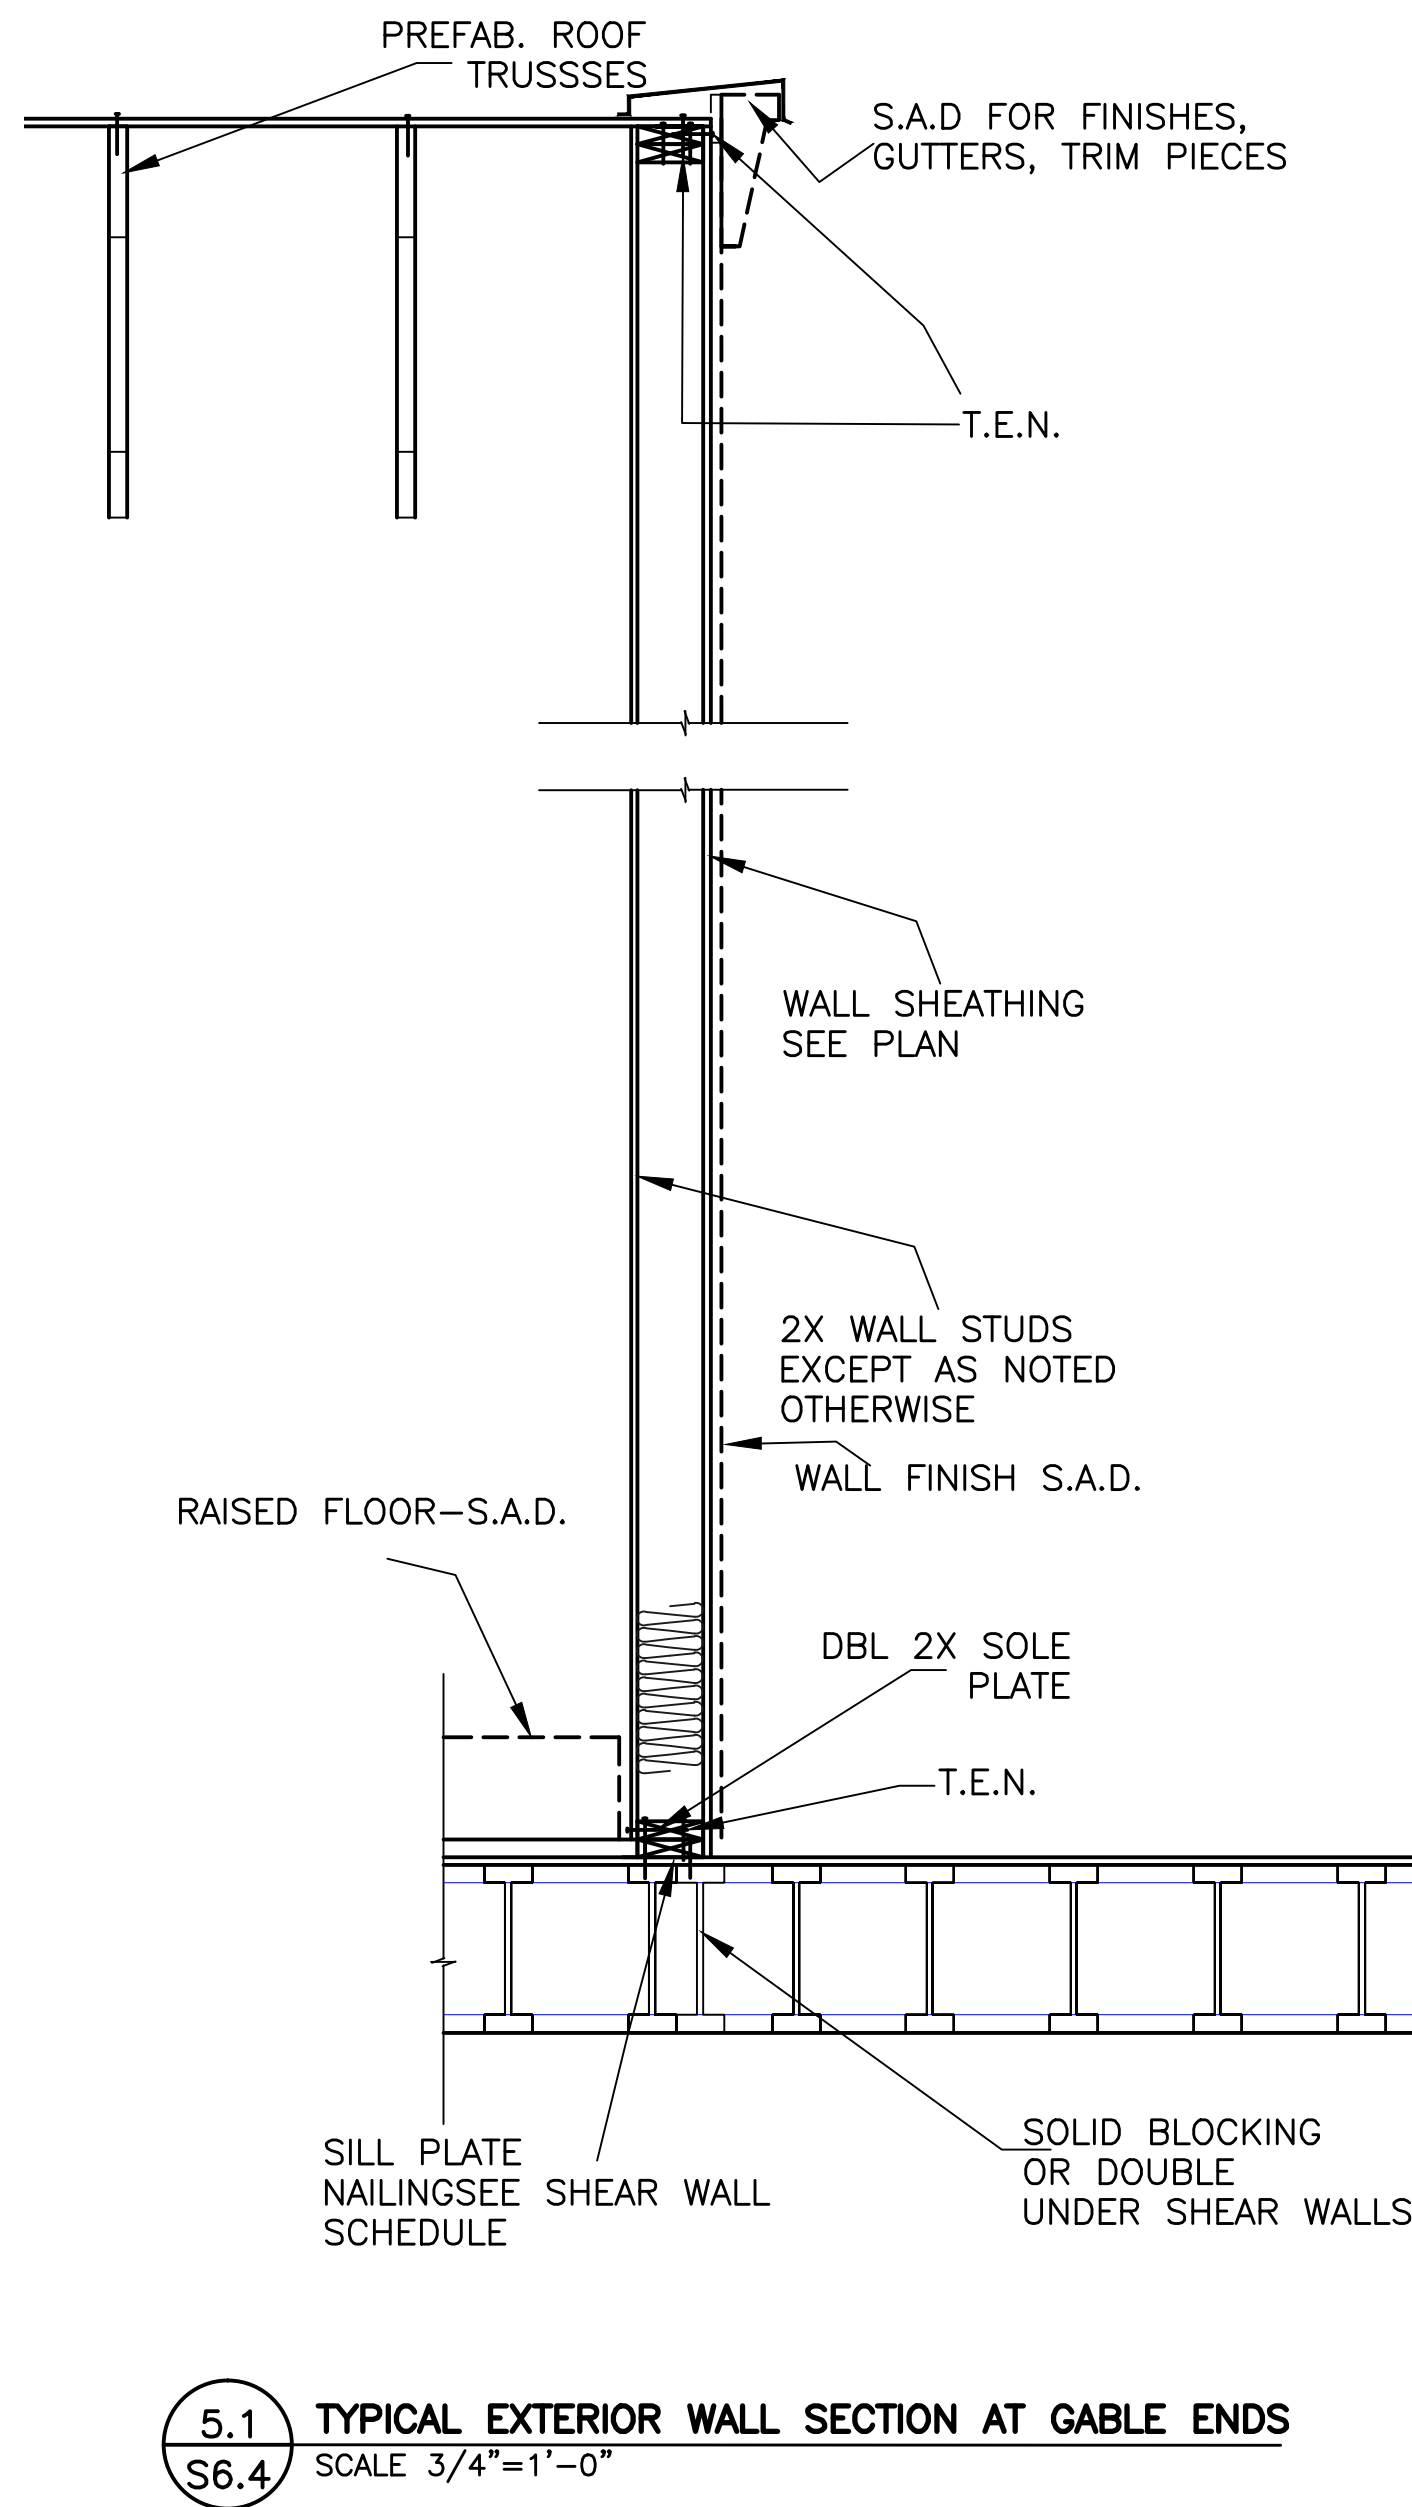PROJECT TITLE:  
**COMMUNITY CENTER**  
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DRAWING TITLE:  
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TEL: 510.566.6043 FAX: 510.566.6043

Date:	08/30/2011
Scale:	AS NOTED
Drawn:	STAFF
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Job No.:	2011-09
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