

CONSTRUCTION PLANS FOR THE: COMMUNITY CENTER

HARBOR PARK APARTMENTS, 969 SONOMA STREET, VALLEJO, CALIFORNIA



REVISIONS	BY
9/26/2011 - PLAN CHECK	G.O.
1/26/2014 - BIDDING	LR



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COMMUNITY CENTER
 HARBOR PARK APARTMENTS
 969 PORTER STREET, VALLEJO, CA 94590
 PROJECT TITLE
 DRAWING TITLE

Date:	04/17/2012
Scale:	AS NOTED
Drawn:	STAFF
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Job No.:	2011-09
Sheet:	A0.0
Of	Sheets

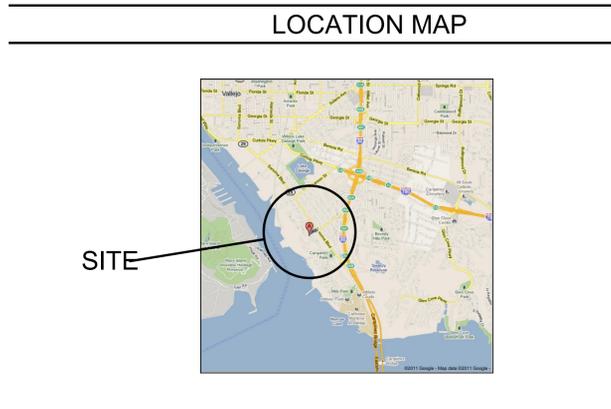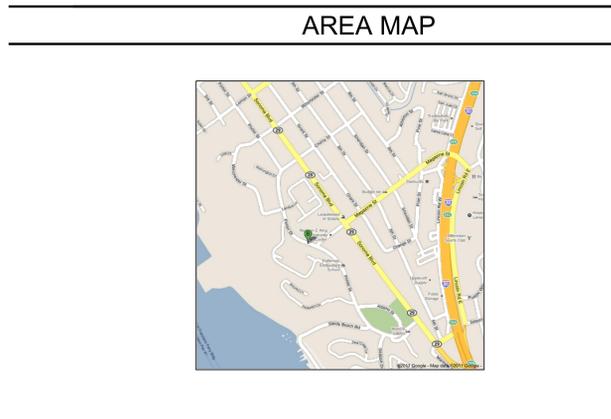

ABBREVIATIONS

& AND @ AT # POUND OR NUMBER (E) EXISTING (N) NEW ADJ. ADJUSTABLE AGGR. APPROXIMATE ARCH. ARCHITECT BLDG. BUILDING BLKG. BLOCK BM. BENCHMARK BOT. BOTTOM CEM. CEMENT CLG. CEILING CLR. CLEAR C.J. CONNECTION JOINT COL. COLUMN CONC. CONCRETE CONN. CONNECTION CONSTR. CONSTRUCTION CONT. CONTINUOUS CTR. CENTER CTSK. COUNTERSUNK DBL. DOUBLE DEPT. DEPARTMENT DET. DETAIL DIA. DIAMETER DIM. DIMENSION DN. DOWN DWG. DRAWING E. EAST E.A. EACH E.J. EXPANSION JOINT EL. ELEVATION ELEC. ELECTRICAL ELEV. ELEVATOR	EQ. EQUAL EQPT. EQUIPMENT EXIST. EXISTING EXP. EXPANSION EXT. EXTERIOR FDN. FOUNDATION FIN. FINISH FIN.FLOOR FINISH FLOOR F.F. FACE OF FINISH F.O.F. FACE OF FINISH F.O.S. FACE OF STUDS FT. FOOT OR FEET FTG. FOOTING FUT. FUTURE GALV. GALVANIZED GND. GROUND GR. GRADE GYP. GYPSUM HORIZ. HORIZONTAL HGT. HEIGHT INSUL. INSULATION INT. INTERIOR JOINT JOINT LAB. LABORATORY LAM. LAMINATE LAV. LAVATORY LCKR. LOCKER LK. LIGHT L.T. LIGHT L.T. WIT. LIGHT WEIGHT MAX. MAXIMUM MECH. MECHANICAL MEMB. MEMBRANE MET. METAL MISC. MISCELLANEOUS M.O. MASONRY OPENING MULL. MULLION N. NORTH	N.L.C. NOT IN CONTRACT NO. OR # NUMBER NOM. NOMINAL N.T.S. NOT TO SCALE O.C. ON CENTER O.D. OUTSIDE DIAMETER (DIM) O.P. OPPOSITE OPP. OPPOSITE PRG. PRECAST PL. PLATE PLAS. PLASTER PLYWD. PLYWOOD PT. POINT PARTITION PARTITION RM. ROOM R.O. ROUGH OPENING S. SOUTH SCHED. SCHEDULE SECT. SECTION SHT. SHEET SIM. SIMILAR SQ. SQUARE STD. STANDARD STL. STEEL STR. STRUCTURAL SUPS. SUPPORTED SYM. SYMMETRICAL THK. THICK T.W. TOP OF WALL T & B. TOP AND BOTTOM T.O.F. TOP OF FOOTING T.O.S. TOP OF STEEL TYP. TYPICAL UNLESS OTHERWISE NOTED VERT. VERTICAL W. WEST W/O. WITHOUT WIP. WEAKENED PLANE WIT. WEIGHT
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APPLICABLE CODES

CALIFORNIA FIRE CODE	2010 EDITION
CALIFORNIA BUILDING CODE	2010 EDITION
CALIFORNIA MECHANICAL CODE	2010 EDITION
CALIFORNIA PLUMBING CODE	2010 EDITION/UPC
CALIFORNIA ELECTRIC CODE	2010 EDITION
CALIFORNIA ENERGY CODE	2010 EDITION

COMPLY WITH ALL LOCAL, STATE, FEDERAL AND PUBLIC AGENCY LAWS AND REGULATIONS
 THE USE OF ABS & PVC DRAIN WASTE, AND VENT PIPING IS PROHIBITED

SPECIAL INSPECTION REQUIREMENTS

SPECIAL INSPECTION IS REQUIRED FOR THE FOLLOWING:
 1. STRUCTURAL WELDING
 2. HIGH STRENGTH BOLTING

CODE SUMMARY AND ANALYSIS

AUTHORITY: CITY OF VALLEJO, CALIFORNIA BUILDING DEPARTMENT
 CODE: CBC - 2010 EDITION
 ZONING: HIGH DENSITY RESIDENTIAL
 CONSTRUCTION TYPE: 5B- SPRINKLERED
 OCCUPANCY GROUP: GROUND FLOOR: A3- COMMUNITY HALL SECOND AND THIRD FLOOR: R2

BUILDING CODE ANALYSIS:
CBC TABLE 503, TYPE V-B CONSTRUCTION:
 A. ALLOWABLE BUILDING HEIGHT = 40 FEET
 B. PROPOSED BUILDING HEIGHT = 38.863 FEET

CBC TABLE 503, A-3 OCCUPANCY:
 C. ALLOWABLE AREA PER STORY = 6000 S.F.
 D. PROPOSED AREA = 2,118 S.F. < 6,000 THEREFORE OK.
 E. ALLOWABLE NUMBER OF STORIES = ONE
 F. PROPOSED NUMBER OF STORIES = ONE, THEREFORE OK

CBC TABLE 503, R-2 OCCUPANCY:
 G. ALLOWABLE AREA PER STORY = 7000 S.F.
 H. PROPOSED AREA = 2,720 S.F. < 7,000 S.F. THEREFORE OK
 I. ALLOWABLE NUMBER OF STORIES = TWO
 J. PROPOSED NUMBER OF STORIES = THREE, SPRINKLERS USED TO INCREASE STORIES.

CBC 506.3:
 K. SPRINKLERS USED TO INCREASE ALLOWABLE NUMBER OF STORIES FOR R-2 FROM TWO TO THREE

CBC 508, 4.4 N AND TABLE 508.4:
 L. REQUIRE SEPARATION BETWEEN A-3 AND R-2 OCCUPANCIES = ONE HOUR RATED HORIZONTAL ASSEMBLY

CBC 420.2 AND 709.3:
 M. REQUIRED SEPARATION BETWEEN DWELLING UNITS = ONE HOUR RATED FIRE WALLS.

BUILDING CODE ANALYSIS: AREA RATIOS AND EXITING REQUIREMENTS

A. BASIC BUILDING AREAS ALLOWED: TYPE A3-6000;
 ACTUAL AREA: 2118 SF RATIO = $\frac{2118}{6000} = .353$
 B. BASIC BUILDING AREA FOR R2 OCCUPANCY: 7000 SF
 ACTUAL AREA: 2720 SF RATIO = $\frac{2720}{7000} = .388$
 C. COMBINED RATIO = $.741 < 1$

EXITING REQUIREMENTS
 GREAT ROOM AND VESTIBULE: OCCUPANT LOAD = 51 TWO EXITS REQUIRED
 OFFICE 1, OFFICE 2, STORAGE/COPY, BUSINESS CENTER-1 EACH 1 EXIT REQ.
 FITNESS CENTER 7 OCCUPANTS, 1 EXIT REQUIRED.
 KITCHEN WOMEN, MEN ROOMS, UTILITY ROOM-1 OCCUP. EA 1 EXIT REQ.
 APARTMENT: 960, 980, 780 SF. 1 EXIT REQUIRED,

DEFERRED SUBMITTALS

- ROLLING SECURITY GATE SHOWN ON DETAIL 21 SHEET A9.4
- ROOF TRUSS SHOP DRAWINGS
- SPRINKLER SYSTEM PIPING AND SHOP DRAWINGS.
- 4 SPACE PRIVATE GARAGE BUILDING
- RETAINING WALL STRUCTURES

DEFERRED SUBMITTALS REQUIRE SEPARATE PERMIT APPLICATIONS AND PLAN CHECK REVIEW, AND PERMIT FEES..

PROJECT TEAM

OWNER: SONOMA APARTMENTS
 1015 PORTER ST.
 VALLEJO, CALIFORNIA 94621

ARCHITECT: OAKLEY & OAKLEY
 ENGINEERS & ARCHITECTS
 7700 EDGEWATER DRIVE
 SUITE 615
 OAKLAND, CA 94621
 CONTACT JOE OAKLEY 510-562-6028

CONTRACTOR: DDMI CONSTRUCTION: CONTACT MIKE GOLDSMITH, 831-427-9099

SCOPE OF WORK

1) CONSTRUCTION OF NEW MIXED USE COMMUNITY BUILDING ON THE 1ST FLOOR AND 3 RESIDENTIAL UNITS ON THE 2ND FLOOR.

GENERAL NOTES

- VERIFY ALL CONDITIONS AND DIMENSIONS PRIOR TO ANY WORK. ALL CONSTRUCTION MUST COMPLY WITH ALL LOCAL GOVERNING CODES.
- DO NOT SCALE DRAWINGS.
- REPORT TO THE ENGINEER ANY ERROR OR OMISSION DISCOVERED IN THE DRAWINGS, OR ANY INCONSISTENCY BETWEEN THE DRAWINGS AND FIELD CONDITIONS, PRIOR TO CONSTRUCTION SO THAT THE ENGINEER MAY ISSUE WRITTEN CLARIFICATION IN A TIMELY MANNER.
- OBTAIN ALL PERMITS AND PAY ALL FEES.
- PROVIDE ADEQUATE BLOCKING AT THE REQUIRED LOCATIONS FOR ALL WALL MOUNTED SHELVING, TABLES, ETC.
- SUBCONTRACTORS ARE RESPONSIBLE FOR RECEIVING AND ON-SITE STORAGE OF ALL SOFT-GOODS (SMALL WARES, ETC.) DURING REGULAR CONSTRUCTION HOURS.
- SUBCONTRACTORS SHALL CONTROL NOISE PRODUCING ITEMS (STEREOS) AT ALL TIMES.
- INTERIOR WALLS TO BE 5/8" TYPE X GYP. BD. ON EACH SIDE OF WOOD STUDS UNLESS NOTED OTHERWISE. EXTEND ANY NEW WALLS TO 6" ABOVE THE HIGHER CEILING.
- FIRE EXTINGUISHERS ARE TO BE MAINTAINED ON THE PREMISES AT LOCATIONS APPROVED BY THE FIRE DEPARTMENT. AND SHALL BE MULTIPURPOSE DRY CHEMICAL TYPE, RATED 4-A-80-B-C, 10 LB NOMINAL CAPACITY AND IN ENAMELED STEEL CONTAINER, FOR CLASS I, CLASS B, AND CLASS C. FIRES. MOUNT IN MANUFACTURERS STANDARD
- PROVIDE "L-METAL". ALL WALLS TO BE TAPED. VERIFY WITH OWNER WHICH WALLS TO RECEIVE WALL COVERING. PRIME THESE WALLS WITH ONE COAT OF PRIMER.
- REFER TO FLOOR PLAN FOR NEW LIGHT FIXTURES AND ELECTRICAL OUTLETS.
- ALL MECHANICAL AND ELECTRICAL EQUIPMENT SHALL HAVE A UL DESIGN/LISTING NUMBER. ANY EQUIPMENT NOT LISTED WILL BE REQUIRED TO BE FIELD TESTED AND CERTIFIED BY AN APPROVED TESTING AGENCY. IT IS THE RESPONSIBILITY OF THE OWNER AND HIS/HER DESIGN/ CONSTRUCTION TEAM TO NOTIFY THE BUILDING DEPARTMENT IF FIELD TESTING IS REQUIRED FOR ANY EQUIPMENT WITHOUT A UL OR EQUIVALENT LISTED LABEL APPROVED BY THE VALLEJO BUILDING DEPARTMENT. PROOF OF EQUIPMENT CERTIFICATION WILL NEED TO BE SUBMITTED AND APPROVED BEFORE A CERTIFICATE OF OCCUPANCY CAN BR ISSUED

SPECIAL NOTES

g. PRIOR TO REQUESTING A FOUNDATION INSPECTION BY THE CITY, THE GEOTECHNICAL ENGINEER SHALL STATE IN WRITING:
 1. THE BUILDING PAD WAS PREPARED AND COMPACTED IN ACCORDANCE WITH THE SOIL REPORT AND SPECIFICATION.
 2. THE UTILITY TRENCHES HAVE BEEN PROPERLY BACK FILLED AND COMPACTED.
 3. THE FOUNDATION EXCAVATION, DEPTH, AND MATERIAL COMPLY WITH THE SOIL REPORT AND APPROVED PLANS.
 b. PRIOR TO FINAL INSPECTION FOR ANY BUILDINGSTRUCTURE, THE ENGINEER OF RECORD SHALL A FINAL LETTER STATING THE COMPLETED PAD, FOUNDATION, ROUGH GRADING, AND ASSOCIATED SITE WORK SUBSTANTIALLY CONFORMS TO THE APPROVED PLANS, SPECIFICATIONS, AND INVESTIGATION


SPECIAL OBSERVATION REQUIREMENTS

SPECIAL OBSERVATION IS REQUIRED FOR THE FOLLOWING:
 1. STRUCTURAL WELDING
 2. HIGH STRENGTH BOLTING
 3. FINAL STRUCTURAL OBSERVATION LETTER IS REQUIRED BY ENGINEER AND MUST BE RETURNED TO BUILDING DEPARTMENT PRIOR TO ISSUANCE OF PERMIT

DRAWING LIST

REVISIONS	SET	SHT.	TITLE
			ARCHITECTURAL
		A0.0	TITLE SHEET
		A0.1	PATH OF TRAVEL
		A1.1	SITE PLAN
		A1.2	SITE DETAILS
		A1.3	ENLARGED ACCESSIBLE RAMP PLANS
		C2.1	GRADING PLAN
		A2.1	FIRST FLOOR PLAN
		A2.21	SECOND & THIRD FLOOR PLANS
		A2.24	EXTERIOR ELEVATIONS
		A2.25	EXTERIOR ELEVATION AND ROOF PLAN
		A2.29	INTERIOR ELEVATIONS
		A2.3	INTERIOR ELEVATION UNITS A, B, C
		A2.4	REFLECTED CEILING PLAN COMMUNITY BUILDING
		A4.1	DOOR, WINDOW, AND FINISH SCHEDULE COMMUNITY BUILDING
		A4.11	FINISH SCHEDULE UNITS A,B,C
		A7.1	BUILDING SECTIONS
		A7.2	BUILDING SECTIONS
		A7.3	STAIRWAY DETAILS
		A8.1	BUILDING WALL SECTIONS
		A9.1	DOOR AND WINDOW SCHEDULE UNITS A,B,C
		A9.2	ARCHITECTURAL DETAILS
		A9.3	ARCHITECTURAL DETAILS
		A9.4	ARCHITECTURAL DETAILS
		A9.41	ARCHITECTURAL DETAILS
		A9.42	ARCHITECTURAL DETAILS
		A9.5	STAIRWAY 1 & 2 DETAILS
			STRUCTURAL
		S0.1	GENERAL NOTES
		S1.1	FOUNDATION PLAN
		S1.2	SECOND FLOOR FRAMING PLAN
		S1.3	ROOF FRAMING PLAN
		S1.4	ROOF FRAMING PLAN
		S3.1	TYPICAL FOUNDATION DETAILS
		S3.2	FOUNDATION DETAILS
		S3.21	FOUNDATION & FRAMING DETAILS
		S5.1	STAIR FRAMING DETAILS
		S6.1	TYPICAL WOOD FRAMING DETAILS
		S6.2	TYPICAL WOOD SHEAR WALL FRAMING DETAILS
		S6.3	WOOD FRAMING DETAILS
		S6.3.1	WOOD FRAMING DETAILS
		S6.4	WOOD FRAMING DETAILS
		S8	TYPICAL HARDY FRAMING DETAILS
		S9	TYPICAL HARDY FRAMING DETAILS
			MECHANICAL/ELECTRICAL/PLUMBING
		M01	GROUND FLOOR MECHANICAL PLAN
		M03	SECOND FLOOR MECHANICAL PLAN
		M04	THIRD FLOOR MECHANICAL PLAN
		M05	MECHANICAL DETAILS-FIRE DAMPERS
		P01	GROUND FLOOR PLUMBING PLAN
		P02	SECOND & 3RD FLOOR PLUMBING PLAN
		P04	PLUMBING ISOMETRICS
		E01	GROUND FLOOR POWER PLAN
		E02	GROUND FLOOR LIGHTING PLAN
		E2	DETAILS, PANEL SCHEDULES FOR GROUND FLOOR
		E03	2ND FLOOR ELECTRICAL PLAN
		E04	3RD FLOOR ELECTRICAL PLAN
			FIRE PROTECTION
		FAS1	GROUND SPRINKLER PLAN
		FAS2	SECOND FLOOR SPRINKLER PLAN
		FAS3	THIRD FLOOR SPRINKLER PLAN
			LANDSCAPE
		L1.1	NOT INCLUDED
			CIVIL
		CA1.1	SITE GRADING AND UTILITY PLAN
			TITLE 24
		A24.1	TITLE 24
		A24.2	TITLE 24
		A24.3	TITLE 24
		A24.4	TITLE 24

Jan 22, 2014 - 10:37am Z:\Year 2011 - Community Bldg Drawings\Architectural\A0_000812 - Title Sheet.dwg

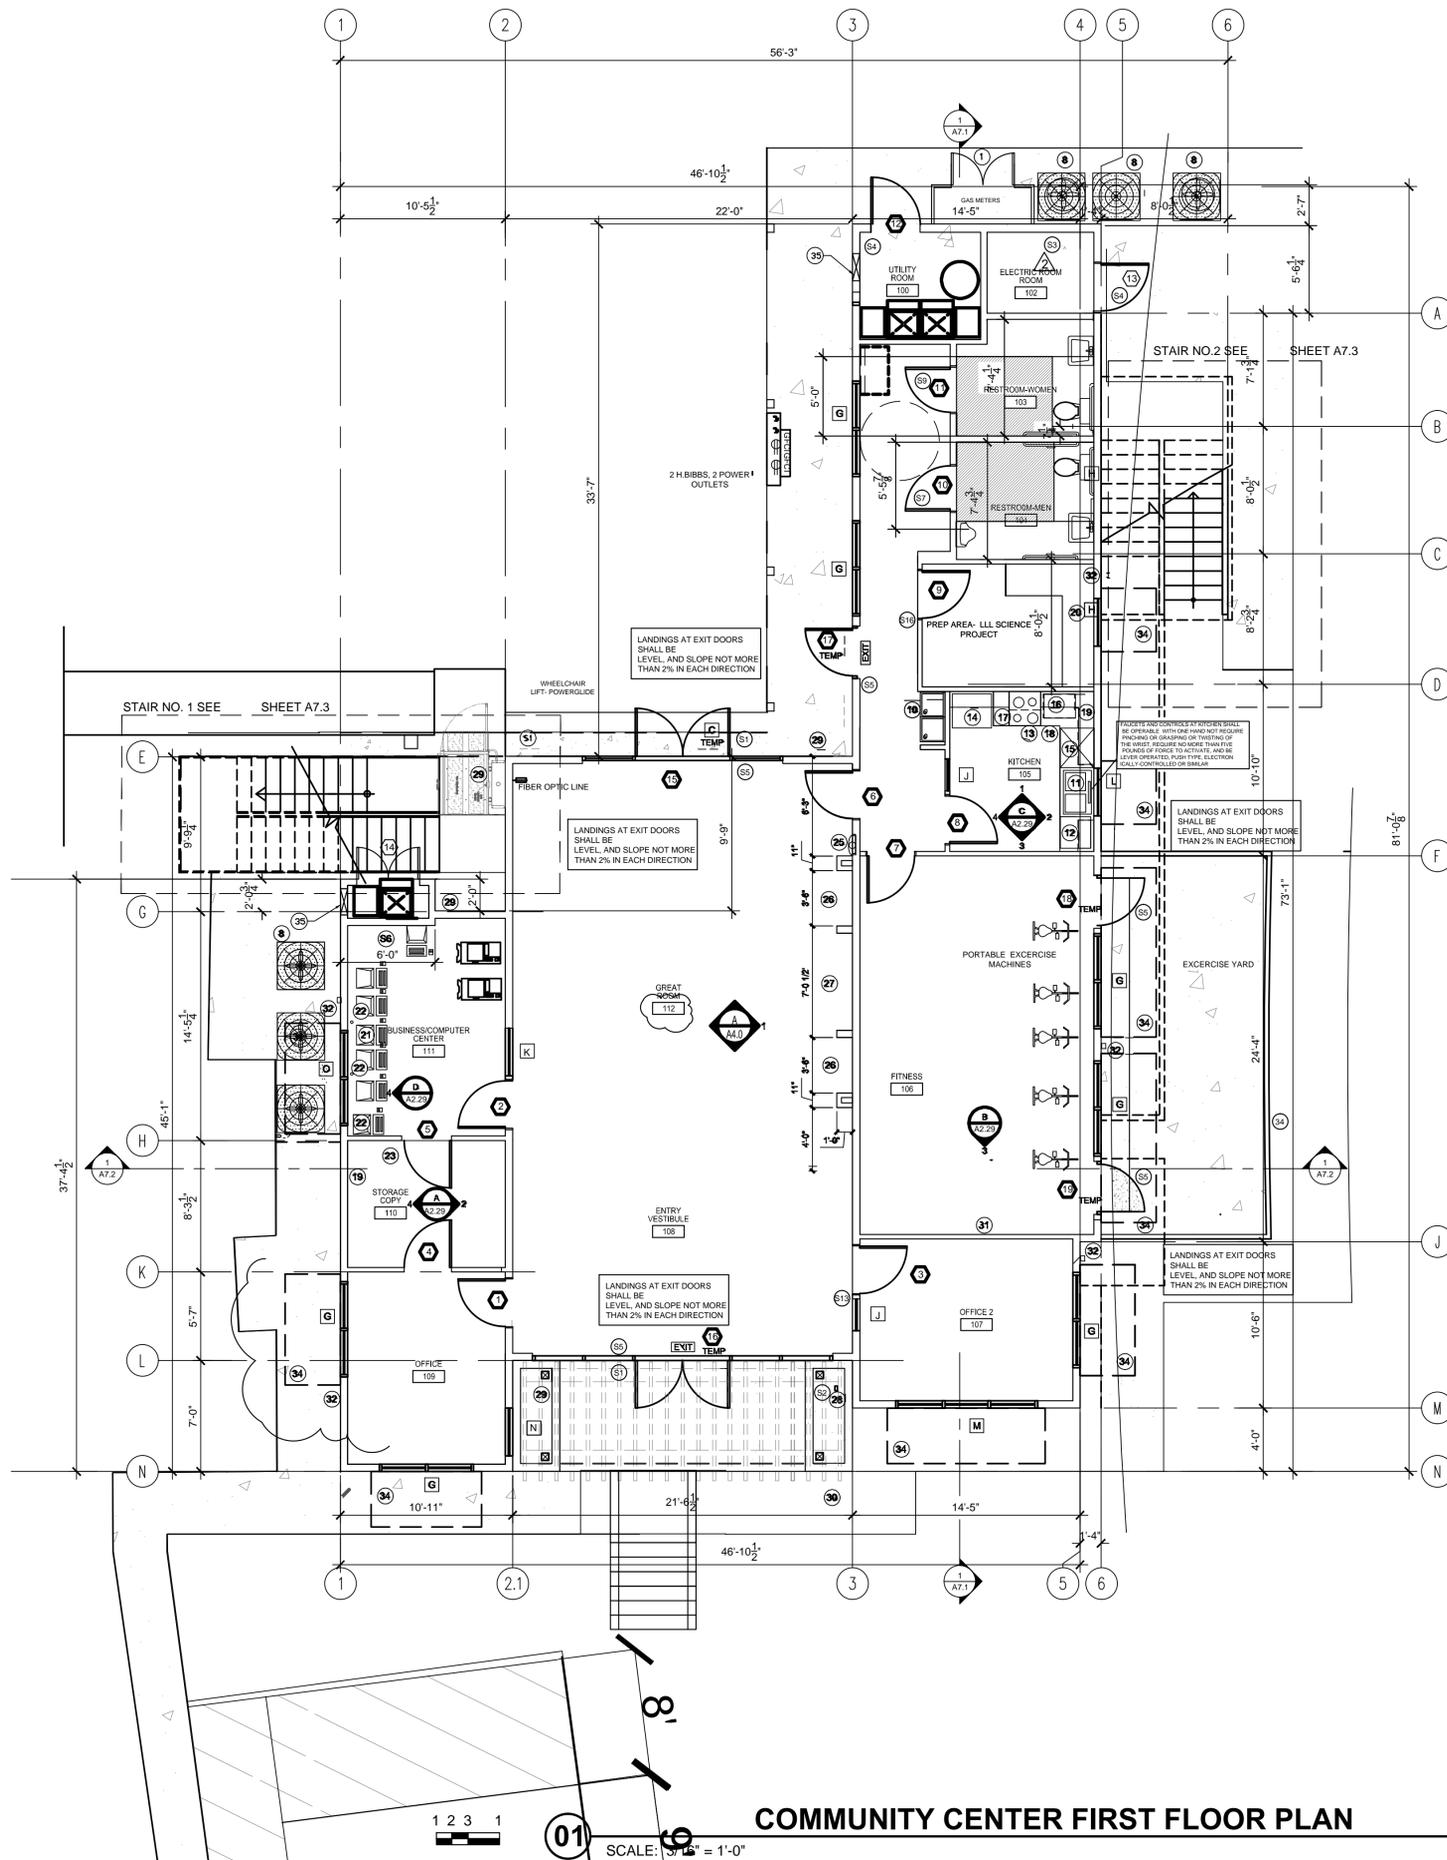


1 2 3 1
 01 SCALE: 3/16" = 1'-0"
COMMUNITY CENTER FIRST FLOOR PLAN

COMMON AREA SIGN NOTES

- 81 INSTALL SIGN DISPLAYING INTERNATIONAL SYMBOL OF ACCESSIBILITY @ 60" A.F.F. AT EACH BUILDING ENTRANCE
- 82 PROVIDE TACTILE SIGN WITH THE WORDS "COMMUNITY BUILDING" 60" A.F.F. ON THE LATCH SIDE OF THE DOOR SHOWN.
- 83 PROVIDE SIGN STATING "FIRE ALARM CONTROL PANEL" (VERIFY EXACT WORDING AND LOCATION WITH CITY OF VALLEJO FIRE DEPARTMENT)
- 84 PROVIDE SIGN WITH THE WORDS "UTILITY ROOM" @ 60" A.F.F. ON THE LATCH SIDE OF THE DOOR.
- 85 PROVIDE TACTILE EXIT SIGN WITH THE WORDS "EXIT" @ 60" A.F.F. ON THE WALL ADJACENT TO THE LATCH SIDE OF A SINGLE-LEAF DOOR OR ON THE ADJACENT RIGHT WALL OF A DOUBLE-LEAF DOOR (CBC 10011.3, CBC 1117B.5.7)
- 86 PROVIDE TACTILE SIGN WITH THE WORDS "UTILITY ROOM" @ 60" A.F.F. ON THE LATCH SIDE OF THE DOOR.
- 87 PROVIDE TACTILE SIGN WITH THE WORDS "MEN" 60" A.F.F. ON THE LATCH SIDE OF THE DOOR SHOWN. SEE DOOR SCHEDULE FOR ADDITIONAL REQUIREMENTS.
- 88 PROVIDE TACTILE SIGN WITH THE WORDS "WOMEN" 60" A.F.F. ON THE LATCH SIDE OF THE DOOR SHOWN. SEE DOOR SCHEDULE FOR ADDITIONAL REQUIREMENTS.
- 89 PROVIDE SIGN WITH THE WORDS "STORAGE" 60" A.F.F. ON THE LATCH SIDE OF THE DOOR.
- 90 PROVIDE SIGN WITH THE WORDS "BUSINESS CENTER" 60" A.F.F. ON THE LATCH SIDE OF THE DOOR.
- 91 PROVIDE SIGN WITH THE WORDS "STORAGE / COPY" 60" A.F.F. ON THE LATCH SIDE OF THE DOOR.
- 92 PROVIDE SIGN WITH THE WORDS "OFFICE 1" 60" A.F.F. ON THE LATCH SIDE OF THE DOOR.
- 93 PROVIDE SIGN WITH THE WORDS "OFFICE 2" 60" A.F.F. ON THE LATCH SIDE OF THE DOOR.
- 94 PROVIDE SIGN WITH THE WORDS "FITNESS" 60" A.F.F. ON THE LATCH SIDE OF THE DOOR.
- 95 PROVIDE SIGN WITH THE WORDS "KITCHEN" 60" A.F.F. ON THE LATCH SIDE OF THE DOOR.
- 96 PROVIDE SIGN WITH THE WORDS "LL SCIENCE PROJECT" THE LATCH SIDE OF THE DOOR.

TACTILE EXIT SIGN DETAILS

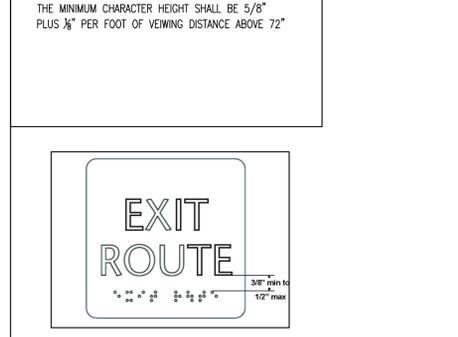

DRAWINGS FOR REVIEW AND BIDDING PURPOSES ONLY-NOT FOR CONSTRUCTION. SUBMIT RFI FOR CONFLICTS OR INFORMATION NOT SHOWN

KEYNOTES

- 1 METAL FENCE GAS METER ENCLOSURE. SEE NORTH ELEVATION
- 2 LIGHTING CONTROL PANEL. SEE ELECTRICAL DRAWINGS
- 3 SEE E ELECTRICAL DWGS FOR TELEPHONE PANEL LOCATION
- 4 FIRE SPRINKLER RISER
- 5 WATER HEATER. SEE MECH. DWGS
- 6 SEE MECHANICAL DWGS. FOR HVAC UNITS
- 7 CONDENSER
- 8 PAIR 2'-0" WIDE X 6' HIGH METAL GATES
- 9 HANDICAPPED ACCESSIBLE DRINKING FOUNTAIN. PROVIDE HIGH AND LOW DRINKING FOUNTAIN
- 10 DOUBLE SINK AND GARBAGE DISPOSAL. COMPLY WITH CDB 1115B.4.7(2)
- 11 DISHWASHER
- 12 RANGE AND OVEN
- 13 REFRIGERATOR WITH WATER SUPPLY FOR ICEMAKER
- 14 30' MIN. CLR. SPACE BELOW COUNTER
- 15 MICROWAVE
- 16 RANGE HOOD, AND FAN. MOUNT CONTROLS AT 44" ABOVE FIN. FLR.
- 17 BASE CABINETS
- 18 UPPER CABINETS
- 19 60" DIAMETER FOR ADA ACCESS
- 20 COUNTER
- 21 HOLES FOR DATA CABLES
- 22 COPIER LOCATION
- 23 FILE CABINET LOCATION
- 24 RECESSED FIRE EXTINGUISHER (PORTABLE) - TYPICAL ONE 2A-10BC TYPE AT LOCATIONS SHOWN
- 25 ADJUSTABLE OPEN SHELVES
- 26 TV/VIDEO GAME SPACE
- 27 FIRE DEPARTMENT KNOX BOX.
- 28 not used
- 29 WOOD TRELIS
- 30 8' WALL MOUNTED MIRROR
- 31 ROOF DOWNSPOUTS
- 32 FABRIC AWNING
- 34 6' HIGH WOOD FENCE SEE DETAIL SHEET A9.4
- 35 16X16 WALL LOUVERS II AT 12" ABOVE FLR, 12" BELOW CEILING

GENERAL NOTES

- B. ALL DIMENSIONS ARE TO FACE OF STUD OR CENTERLINE OF PARTITION WALL, INTERIOR COLUMN/ WINDOW/ DOOR UNLESS OTHERWISE NOTED.
- C. DETAILS ARE KEYED AND NOTED "TYPICAL" ONLY ONCE ON THE PLANS WHEN THEY FIRST OCCUR, AND ARE REPRESENTATIVE OF SIMILAR CONDITIONS THROUGHOUT, UNLESS OTHERWISE NOTED.
- D. PROVIDE WATER-RESISTANT GYP. BOARD AT ALL WET WALL LOCATIONS.
- E. FOR DOOR AND WINDOW KEYS REFER TO DOOR AND WINDOW SCHEDULE. SEE A9.1
- F. REFER TO INTERIOR ELEVATION FOR CABINETS CALLOUTS. SEE SHEET A2.3, A2.4 & A2.5
- G. FOR ALL TOILETS ACCESSORIES & HEIGHTS REFER TO A2.3, A2.4 & A2.5
- H. FOR FINISH FLOOR REFER TO FINISH SCHEDULE A4.1.
- I. PROVIDE ACOUSTICAL SEALANT AT ALL WALLS AND CEILING CONDITION.
- J. PROVIDE 5/8" THK. GYP. BD. MOISTURE RESISTANT AT WET AREAS , BATHROOMS & KITCHEN SINK AREA.
- K. PROVIDE WD. BLOCKING BEHIND GYPSUM BD. PARTITION FOR ATTACHMENT FOR ALL FIXTURE, FITTINGS, ART WORK & ACCESSORIES.
- L. PROVIDE WD. BLOCKING AT CEILING FOR BLINDS AT WINDOW WHERE REQUIRED.
- M. GROUND AND FLOOR SURFACES AT ACCESSIBLE ROUTES TO BE SLIP RESISTANCE PER N. CBC. 1124.B
- O. SLOPE FLOOR DRAIN 1/4"=1'-0" SEE PLUMBING DWGS.
- P. PROVIDE WD BLOCKING IN WALL AT GRAB BAR, CABINETS, SHELVES, AND CEILINGS AS REQUIRED FOR WINDOW SHADING.
- PLYWOOD SHEAR WALL TO EXTEND FULL HEIGHT OF THE WALL. SSD.
- Q. INTERIOR FINISHES CEILINGS & WALLS SHALL BE CLASSIFIED W/ASTME 84-TYPE "C" FLAMED SPREAD 76-200, SMOKE DEVELOPED AT 0-450. TESTED W/NFPA 286
- R. INTERIOR TRIM SHALL HAVE A MIN. CLASS C FLAMED SPREAD & SMOKE DEVELOP INDEX WHEN TESTED W/ASTME-84 AND NOT TO EXCEED 10% OF AGGREGATE WALL OR CLG. REFER TO SHEET AX.0X FOR WALL TYPE LEGEND

LEGEND

- ONE HOUR RATED WALL. SEE DETAIL SHEET X/XX
- INTERIOR FULL HT. PARTITION. SEE DETAIL SHEET X.XX
- INTERIOR BEARING PARTITION WALL. SEE DETAIL SHEET X.XX
- FIRE EXTINGUISHER

REVISIONS	BY
9/26/2011 - PLAN CHECK	G.O.
11/20/2013 - GAS METER	STAFF
1/20/2014 BIDDING	STAFF
WINDOW, DOOR MARKS ADDED	
DOORS, DOOR MARKS ADDED	
DOORS MODIFIED, FLOOR FINISHES CHANGED	

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PROJECT TITLE: **COMMUNITY CENTER**
 HARBOR PARK APARTMENTS
 969 PORTER STREET, VALLEJO, CA 94560
 DRAWING TITLE: **FIRST FLOOR PLAN**

Date:	08/30/2011
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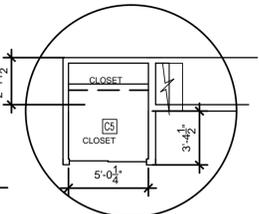
Of _____ Sheets

Jan 27, 2014 - 4:03pm \\SERVER\Server Drive B\Year 2011 Jobs\2011-09-3 - Community Bldg\REVISED DRAWINGS FOR NEGOTIATED CONTRACT WITH WELDYNS BID FOR DOOR SCHEDULE 1-14-2014.dwg

ACCESSIBILITY NOTES

- 29. BASE CABINETS WITH "BASELIFT" ADJUSTABLE SINK AND COUNTER. PROVIDE VINYL FINISH FLOOR.
- 30. BASE COUNTER TOP SHALL BE ADJUSTABLE TO 28" MINIMUM HEIGHT (SLIMLIFT OR EQUAL)
- 31. PROVIDE MINIMUM 30" X 48" CLEAR SPACE AT TUB FOR ACCESSIBILITY
- 32. GRAB BARS, AND SUPPORTS SHALL BE ABLE TO SUPPORT 250 POUND FORCE.
- 33. MOUNT ALL RECEPTACLE OUTLETS BETWEEN 15" AND 48" ABOVE FINISH FLOOR.
- 34. MOUNT ALL SWITCHES, THERMOSTATS, AND OTHER CONTROLS BETWEEN 15" AND 48 INCHES ABOVE FINISH FLOOR
- 35. BASE CABINETS UNDER SINK CABINET AREA, INCLUDING TOEBOARD, AND SHELVING SHALL BE REMOVABLE WITHOUT THE USE OF SPECIALIZED TOOLS OR SPECIALIZED KNOWLEDGE TO PROVIDE CLEARANCE FOR A WHEELCHAIR. FINISHED FLOORING SHALL BE PROVIDED BENEATH THE COUNTER TOP
- 36. PROVIDE A PERMANENTLY WIRED DOORBELL MOUNTED 48" ABOVE THE FLOOR AT MAIN ENTRY TO UNIT A, ACCESSIBLE UNIT

DETAIL A



KEYNOTES

- 01 BASE CABINETS
- 02 UPPER CABINETS
- 03 BACK SPLASH
- 04 P. LAM. FINISH
- 05 DOUBLE SINK. MIN. 30" SPACE BELOW COUNTER
- 06 WOOD TRIM
- 07 PAPER TOWEL DISPENSER
- 08 BLOCK OUT WALL
- 09 TOILET TISSUE DISPENSER
- 10 CERAMIC TILE
- 11 MIRROR
- 12 RANGE HOOD
- 13 CONVENTIONAL OVEN/STOVE
- 14 ACCESSIBLE REFRIGERATOR 30" MIN. CLR.
- 15 FLOOR MOUNTED TOILET
- 16 FLOOR DRAIN
- 17 SOLID WOOD DOOR, SEE SHEET A15.1
- 18 COUNTER TOP MICROWAVE
- 19 DISHWASHER
- 20 SINK SPD
- 21 TUB SPD
- 22 SHOWER (STERLING MODEL 71150115-0 AT ADA UNIT)

INTERIOR STAIR NOTES

- 23 STAIR SHALL HAVE CLOSED VERTICAL RISERS.
- 24 THERE SHALL BE NO NOSING AT TREADS
- 25 PROVIDE SLIP RESISTANT TREADS OR CARPET FINISH
- 26 HANDRAILS ARE SHOWN AT EA. SIDE OF STAIRWAYS
- 27 HANDRAILS SHALL BE MOUNTED 34 TO 38 INCHES ABOVE TOP OF END OF TREAD
- 28 HANDRAILS SHALL BE 1.5" IN DIA. AND TERMINATE IN SAFETY TERMINALS. SEE 6/55.1 FOR MOUNTING

DETAIL
RISER CALCULATIONS:
 GROUND FLOOR TO SECOND FLOOR
 12'-7"=151" / 151 / 7 = 21.57 USE 22 RISERS
 SECOND FLOOR TO THIRD FLOOR
 9'-1" + 15.875" FLOOR + 3.5" SHIM = 128.375"
 128.375 / 7.75 = 16.5645 RISERS USE 17 RISERS @ 7.5691"


GENERAL NOTES

- A. ALL DIMENSIONS ARE TO FACE OF STUD OR CENTERLINE OF PARTITION WALL, INTERIOR COLUMN/ WINDOW/ DOOR UNLESS OTHERWISE NOTED.
- B. DETAILS ARE KEYED AND NOTED "TYPICAL" ONLY ONCE ON THE PLANS WHEN THEY FIRST OCCUR, AND ARE REPRESENTATIVE OF SIMILAR CONDITIONS THROUGHOUT, UNLESS OTHERWISE NOTED.
- C. PROVIDE WATER-RESISTANT GYP. BOARD AT ALL WET WALL LOCATIONS.
- D. FOR DOOR AND WINDOW KEYS REFER TO DOOR AND WINDOW SCHEDULE. SEE A9.1 REFER TO INTERIOR ELEVATION FOR CABINETS CALLOUTS. SEE SHEET A2.3, A2.4 & A2.5
- E. FOR ALL TOILETS ACCESSORIES & HEIGHTS REFER TO A2.3, A2.4 & A2.5
- F. FOR FINISH FLOOR REFER TO FINISH SCHEDULE A4.1.
- G. PROVIDE ACOUSTICAL SEALANT AT ALL WALLS AND CEILING CONDITION.
- H. PROVIDE 5/8" THK. GYP. BD. MOISTURE RESISTANT AT WET AREAS, E RESTROOMS, LAUNDRY AREA, CLASS RESTROOM, & KITCHEN SINK AREA.
- I. PROVIDE WD. BLOCKING BEHIND GYPSUM BD. PARTITION FOR ATTACHMENT FOR ALL FIXTURE, FITTINGS, ART WORK & ACCESSORIES.
- J. PROVIDE WD. BLOCKING AT CEILING FOR BLINDS AT WINDOW WHERE REQUIRED.
- K. PROVIDE TACKLE SIGN AT EXIT DOORS WITH THE WORD "EXIT" PER CBC. 1011.3.
- L. GROUND AND FLOOR SURFACES AT ACCESSIBLE ROUTES TO BE SLIP RESISTANCE PER CBC. 1124.B
- M. SLOPE FLOOR DRAIN 1/4"=1'-0" SEE PLUMBING DWGS.
- N. PROVIDE WD BLOCKING IN WALL AT GRAB BAR, CABINETS, SHELVES, AND CEILINGS AS REQUIRED FOR WINDOW SHADING.
- O. PLYWOOD SHEAR WALL TO EXTEND FULL HEIGHT OF THE WALL SSD.
- P. INTERIOR FINISHES CEILINGS & WALLS SHALL BE CLASSIFIED W/ASTM E 84-TYPE "C" FLAMED SPREAD 76-200, SMOKE DEVELOPED AT 0-450. TESTED W/NFPA 286
- Q. INTERIOR TRIM SHALL HAVE A MIN. CLASS C FLAMED SPREAD & SMOKE DEVELOP INDEX WHEN TESTED W/ASTM E-84 AND NOT TO EXCEED 10% OF AGGREGATE WALL OR CLG.
- R. SEE ROOF PLAN FOR DOWNSPOUT LOCATIONS
- S. WALK DECK SHALL BE DEXOTEX ELASTOTEX 500 URETHANE DECK OR EQUAL USE SLOPED SHAPED INSULATION BOARDS TO OBTAIN SLOPE AT ROOF DECK.


LEGEND

- ONE HOUR RATED WALL
- INTERIOR FULL HT. PARTITION
- INTERIOR BEARING PARTITION WALL
- FIRE EXTINGUISHER

REVISIONS	BY
9/26/2011 - PLAN CHECK	G.O.
2/13/2012 - REVISIONS	STAFF
1-08-14 ROOF DRAINAGE	STAFF
1-08-14 STAIRWAYS	

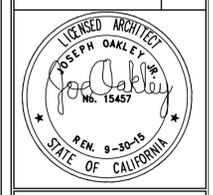


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 7700 E DEWEATER DRIVE, SUITE 615
 DENVER, CO 80231
 PHONE: 303.733.6022
 FAX: 303.733.6043

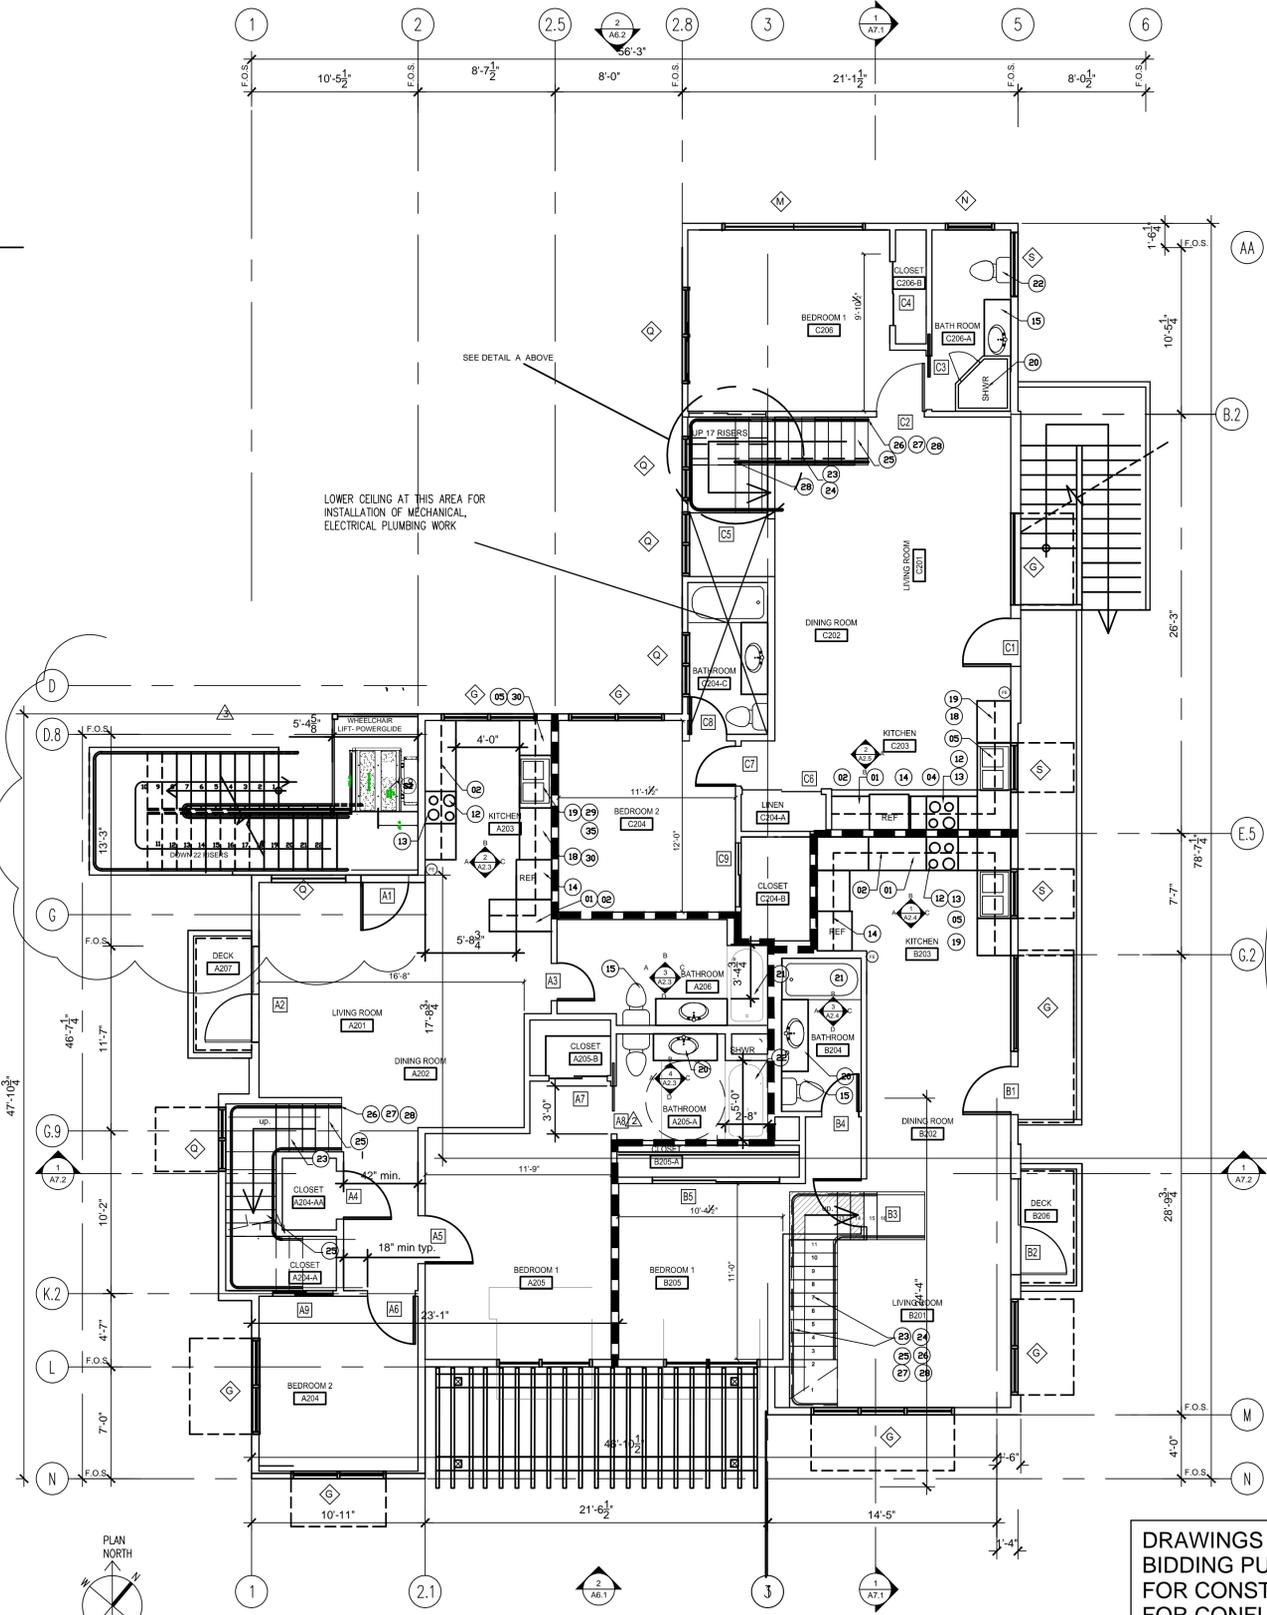

01 COMMUNITY CENTER SECOND FLOOR PLAN
 SEE ACCESSIBILITY NOTE 29 THROUGH FOR ACCESSIBLE UNIT A

DRAWINGS FOR REVIEW AND BIDDING PURPOSES ONLY-NOT FOR CONSTRUCTION. SUBMIT RFI FOR CONFLICTS OR INFORMATION NOT SHOWN

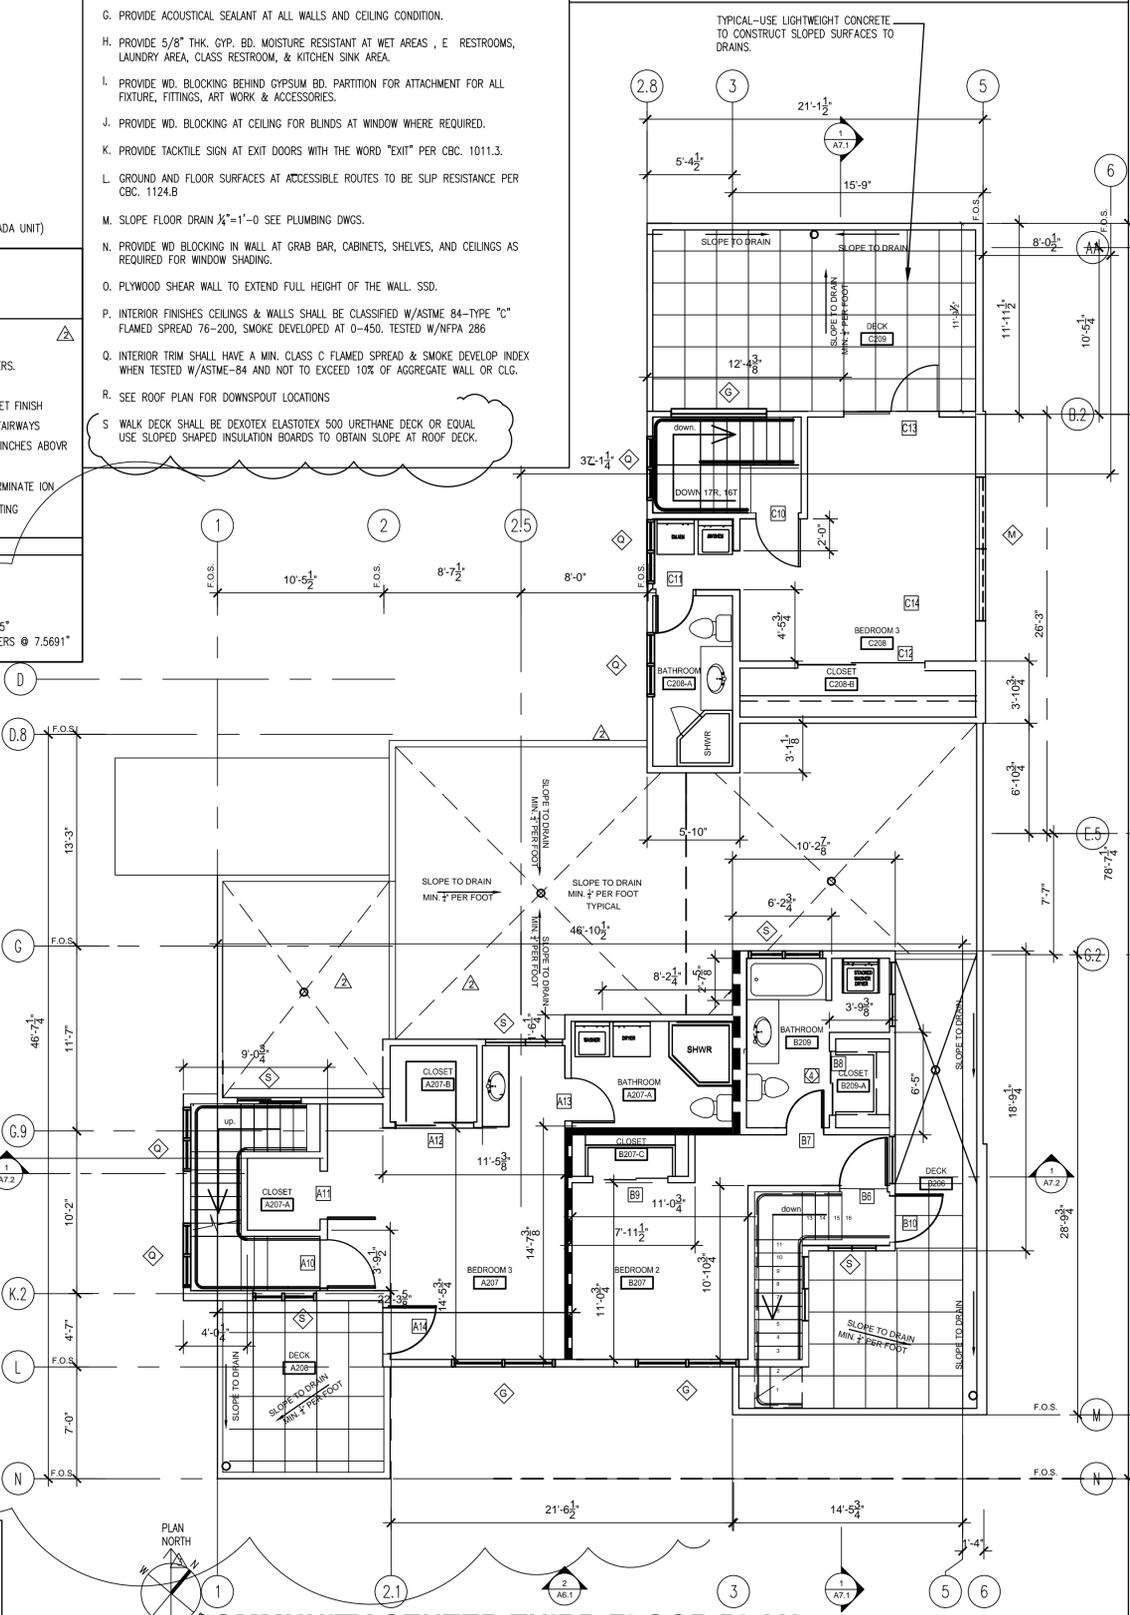


02 COMMUNITY CENTER THIRD FLOOR PLAN

COMMUNITY CENTER
 HARBOR PARK APARTMENTS
 969 PORTER STREET, VALLEJO, CA 94560

Date:	01/12/2011
Scale:	3/16" = 1'-0"
Drawn:	STAFF
Checked:	RY
Job No.:	2011-09
Sheet:	

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 Of Sheets

Jan 27, 2014 - 4:05pm \\SERVER\Server Drive B\Year 2011 Jobs\2011-09.3 - Community Bldg\REVISED DRAWINGS FOR NEGOTIATED CONTRACT WITH WE LYDINS\ARCHITECTURE\A221-A225-REVISED FOR WELYONS BID FOR DOOR SCHEDULE 1-14-2014.dwg

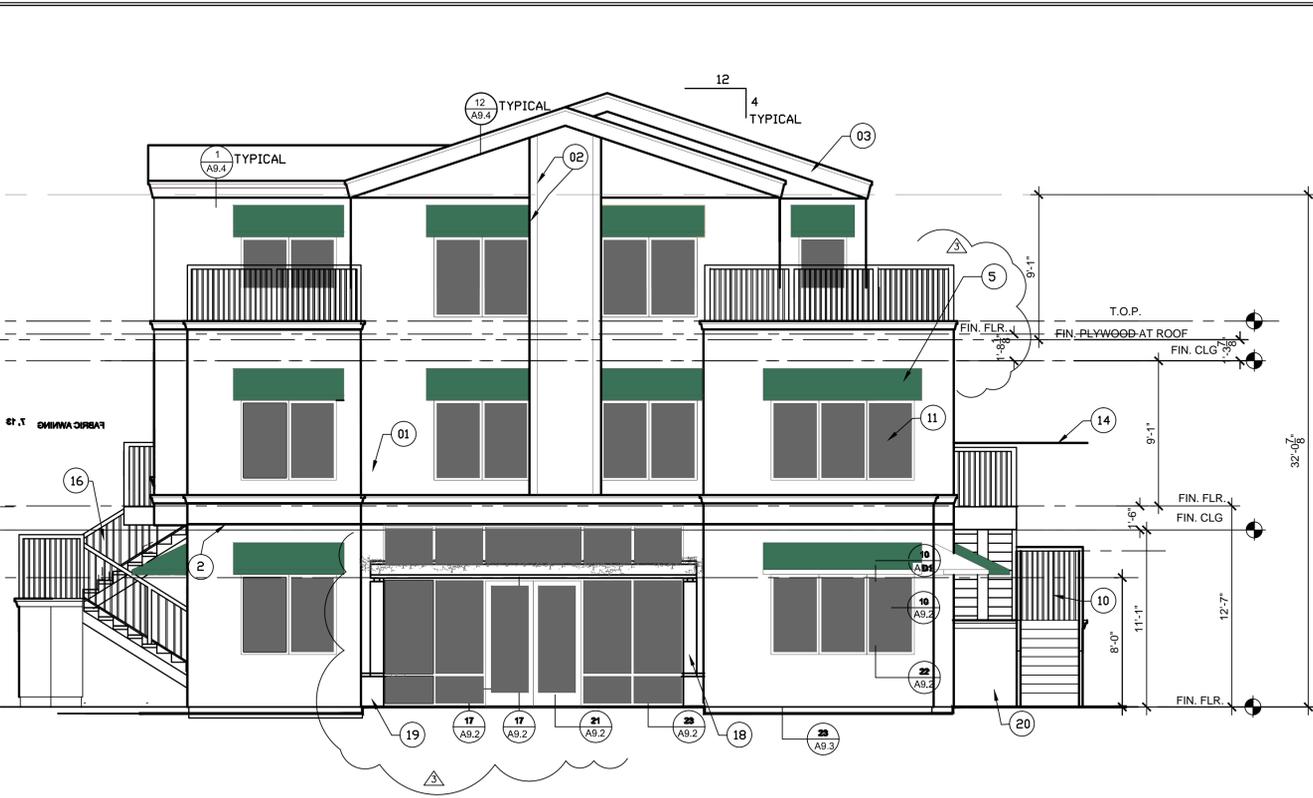

FRONT ELEVATION (SOUTH)



NORTH ELEVATION



PORTER STREET ELEVATION (WEST)

KEYNOTES ELEVATIONS

- 01 3 COATS OF CEMENT PLASTER SYSTEM WITH ACRYLIC FINISH
- 02 2" ALUMINUM REVEAL
- 03 EPS TRIM G.I. CAPPING
- 04 EPS TRIM
- 05 FABRIC AWNING
- 06 G.I. SCUPPER CONDUCTOR
- 07 METAL & WOOD TRELLIS
- 08 METAL STAIRS
- 09 WOOD TRELLIS
- 10 METAL STAIRS
- 11 VINYL WINDOW. SEE WINDOW SCHEDULE
- 12 ALUMINUM STOREFRONT SYSTEM - SEE WINDOW SCHEDULE
- 13 EXTERIOR WOOD DOORS, SEE DOOR SCHEDULE
- 14 STEEL RAILING
- 15 VINYL WINDOW
- 16 METL. RAILING
- 17 LOUVER DOOR
- 18 WOOD COLUMN
- 19 PLANTER BOX
- 20 WHEEL CHAIR LIFT
- 21 6" WOOD FENCE-SELECTION BY OWNER
- 22 EXHAUST FAN OUTLET

GENERAL NOTES

- A. ALL DIMENSIONS ARE TO FACE OF STUD OR CENTERLINE OF PARTITION WALL, INTERIOR COLUMN/ WINDOW/ DOOR UNLESS OTHERWISE NOTED.
- B. DETAILS ARE KEYED AND NOTED "TYPICAL" ONLY ONCE ON THE PLANS WHEN THEY FIRST OCCUR, AND ARE REPRESENTATIVE OF SIMILAR CONDITIONS THROUGHOUT, UNLESS OTHERWISE NOTED.
- C. FOR DOOR AND WINDOW KEYS REFER TO DOOR AND WINDOW SCHEDULE.


LEGEND

- ONE HOUR RATED WALL
- INTERIOR FULL HT. PARTITION
- INTERIOR BEARING PARTITION WALL
- EPS TRIM - MOLDING

DRAWINGS FOR REVIEW AND BIDDING PURPOSES ONLY-NOT FOR CONSTRUCTION. SUBMIT RFI FOR CONFLICT OR INFORMATION NOT SHOWN

01 COMMUNITY CENTER EXTERIOR ELEVATIONS

REVISIONS	BY
9/26/2011 - PLAN CHECK	G.O.
1/ 08 / 14 BIDDING	T.O.
GUARDRAIL AND WINDOWS REVISION	
PARAPET RAISED FOR BUILT UP ROOF, 9'-9" CLG. 7'	
STOREFRONT DOORS, WINDOW REVISED	
BIDDING REVISION	

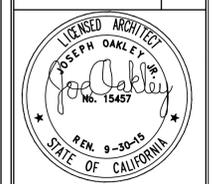

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 7700 EDGEWATER DRIVE, STE. 615
 SAN JOSE, CA 95129
 TEL: 408.262.6024
 FAX: 510.562.6043

PROJECT TITLE: **COMMUNITY CENTER**
 HARBOR PARK APARTMENTS
 969 PORTER STREET, VALLEJO, CA 94560
 DRAWING TITLE: **SECOND FLOOR PLAN**

Date: 08/30/2011
 Scale: 3/16" = 1'-0"
 Drawn: STAFF
 Checked: RY
 Job No.: 2011-09

Sheet:
A2.24
 Of _____ Sheets

Jan 27, 2014 - 4:07pm \\SERVER\Server Drive B\Year 2011\Jobs\A226-093 - Community Bldg\REVISED DRAWINGS FOR NEGOTIATED CONTRACT WITH WE LYDINS\ARCHITECTURE\A226-093-REVISED FOR WELYDINS BID FOR DOOR SCHEDULE 1-14-2014.dwg



WEST ELEVATION

KEYNOTES ELEVATIONS

- 01 3 COATS OF CEMENT PLASTER SYSTEM
- 02 2" ALUMINUM REVEAL
- 03 EPS TRIM G.I. CAPPING
- 04 EPS TRIM
- 05 FABRIC AWNING
- 06 G.I. SCUPPER CONDUCTOR
- 07 METAL & WOOD TRELLIS
- 08 METAL STAIRS
- 09 WOOD TRELLIS
- 10 METAL STAIRS
- 11 VINYL WINDOW. SEE WINDOW SCHEDULE
- 12 ALUMINUM STOREFRONT SYSTEM. SEE WINDOW SCHEDULE
- 13 EXTERIOR WOOD DOORS, SEE DOOR SCHEDULE
- 14 STEEL RAILING.
- 15 VINYL WINDOW
- 16 MTL. RAILING.
- 17 LOUVER DOOR
- 18 STL. COLUMN. SED
- 19 PLANTER BOX.


GENERAL NOTES

- A. ALL DIMENSIONS ARE TO FACE OF STUD OR CENTERLINE OF PARTITION WALL, INTERIOR COLUMN/ WINDOW/ DOOR UNLESS OTHERWISE NOTED.
- B. DETAILS ARE KEYED AND NOTED "TYPICAL" ONLY ONCE ON THE PLANS WHEN THEY FIRST OCCUR, AND ARE REPRESENTATIVE OF SIMILAR CONDITIONS THROUGHOUT, UNLESS OTHERWISE NOTED.
- C. FOR DOOR AND WINDOW KEYS REFER TO DOOR AND WINDOW SCHEDULE.


LEGEND

- ONE HOUR RATED WALL
- INTERIOR FULL HT. PARTITION
- INTERIOR BEARING PARTITION WALL
- EPS TRIM - MOLDING

REVISIONS	BY
9/26/2011 - PLAN CHECK	G.O.
1/09/2014	STF
GUARDAIL REVISED	
1/09/2014	
REVISED ROOF DRAINAGE	
1-10-2014	
REVISED ROOF DRAINAGE, WINDOWS AT HALLWAY	

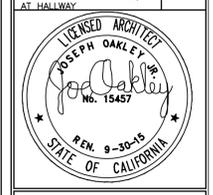

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 7700 EDGEWATER DRIVE, STE. 615
 SAN JOSE, CA 95131
 FAX 510.562.6043

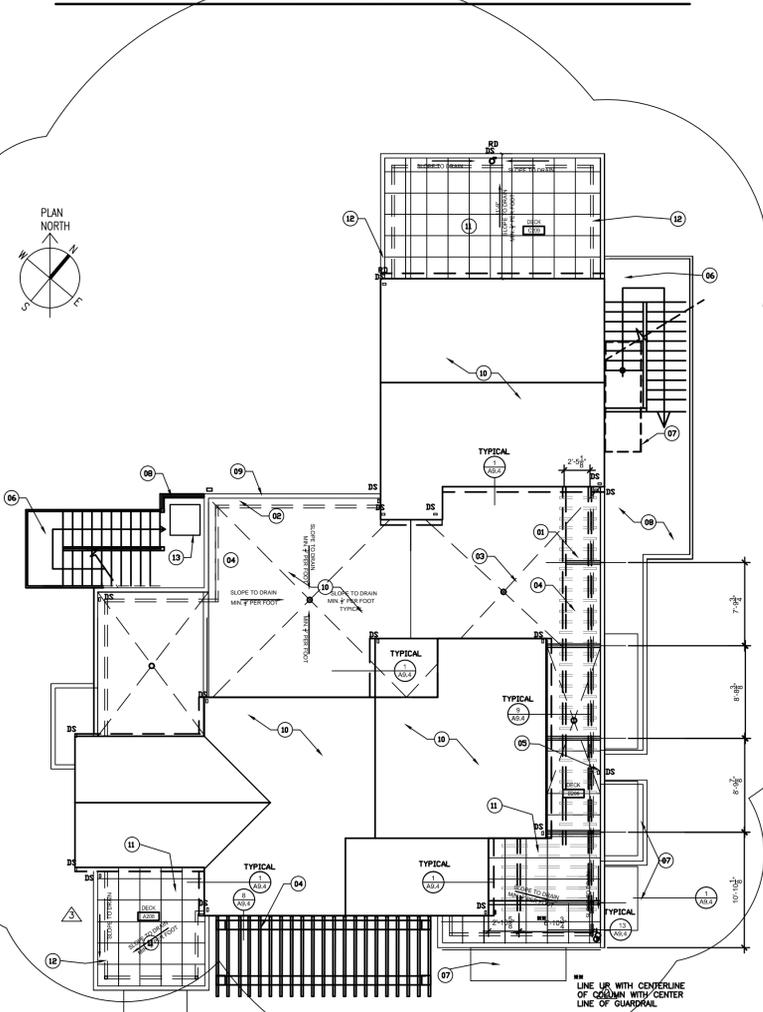

COMMUNITY CENTER ROOF PLAN

01

SCALE 1/8" = 1'-0" SEE SHEET A2.26 FOR ENLARGED ROOF PLAN

KEYNOTES ROOF PLAN

- 01 ROOF CRICKET.
- 02 ROOF LINE OF PARAPET.
- 03 BUILT UP ROOF WITH 90 LB. CAP SHEET CLASS B ROOF SYSTEM. PROVIDE MIN 1/4" SLOPE @ VALLEY
- 04 TRELLIS W/ WOOD FRAME WITH STEEL POSTS
- 05 THROUGH WALL SCUPPER AND 3/4" DOWN SPOUT. TERMINATE AT DOWNSPOUT AT SPLASH BLOCK.
- 06 EXTERIOR STAIRS BELOW
- 07 FABRIC AWNING BELOW.
- 08 DECKING BELOW.
- 09 CORNICE AT EDGE OF PARAPET.
- 10 ASPHALT SHINGLE ROOF
- 11 ROOF DECK
- 12 METAL RAIL
- 13 CHAIR LIFT

GENERAL NOTES

- A. ALL RAIN WATER LEADERS & DOWNSPOUT BE CONNECTED TO STORM DRAIN SYSTEM.
- B. ALL DIMENSIONS ARE TO FACE OF STUDS OR CENTER OF COLUMN LINE AS APPLICABLE, UN.

LEGEND

- CRICKET. SEE DET. SHEET A9.3

WHEELCHAIR LIFT DETAILS

AmeriGlide
AmeriGlide Hercules II VPL Typical Drawing
 Left Hand Shown; Right Hand is Opposite
 Right Hand Platform Gate Shown

Model	X	Y
AG400	77"	53"
AG600	101"	77"
AG800	125"	101"
AG1000	149"	125"
AG1200	173"	149"

DRAWINGS FOR REVIEW AND BIDDING PURPOSES ONLY-NOT FOR CONSTRUCTION. SUBMIT RFI FOR CONFLICTS OR INFORMATION NOT SHOWN


PROJECT TITLE:
COMMUNITY CENTER
 HARBOR PARK APARTMENTS
 959 PORTER STREET, VALLEJO, CA 94560
 DRAWING TITLE:
LEFT ELEVATION AND ROOF PLAN
CHAIR LIFT DETAILS

Date:	04/10/2012
Scale:	3/16" = 1'-0"
Drawn:	STAFF
Checked:	RY
Job No.:	2011-09
Sheet:	

A2.25

Of _____ Sheets

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01

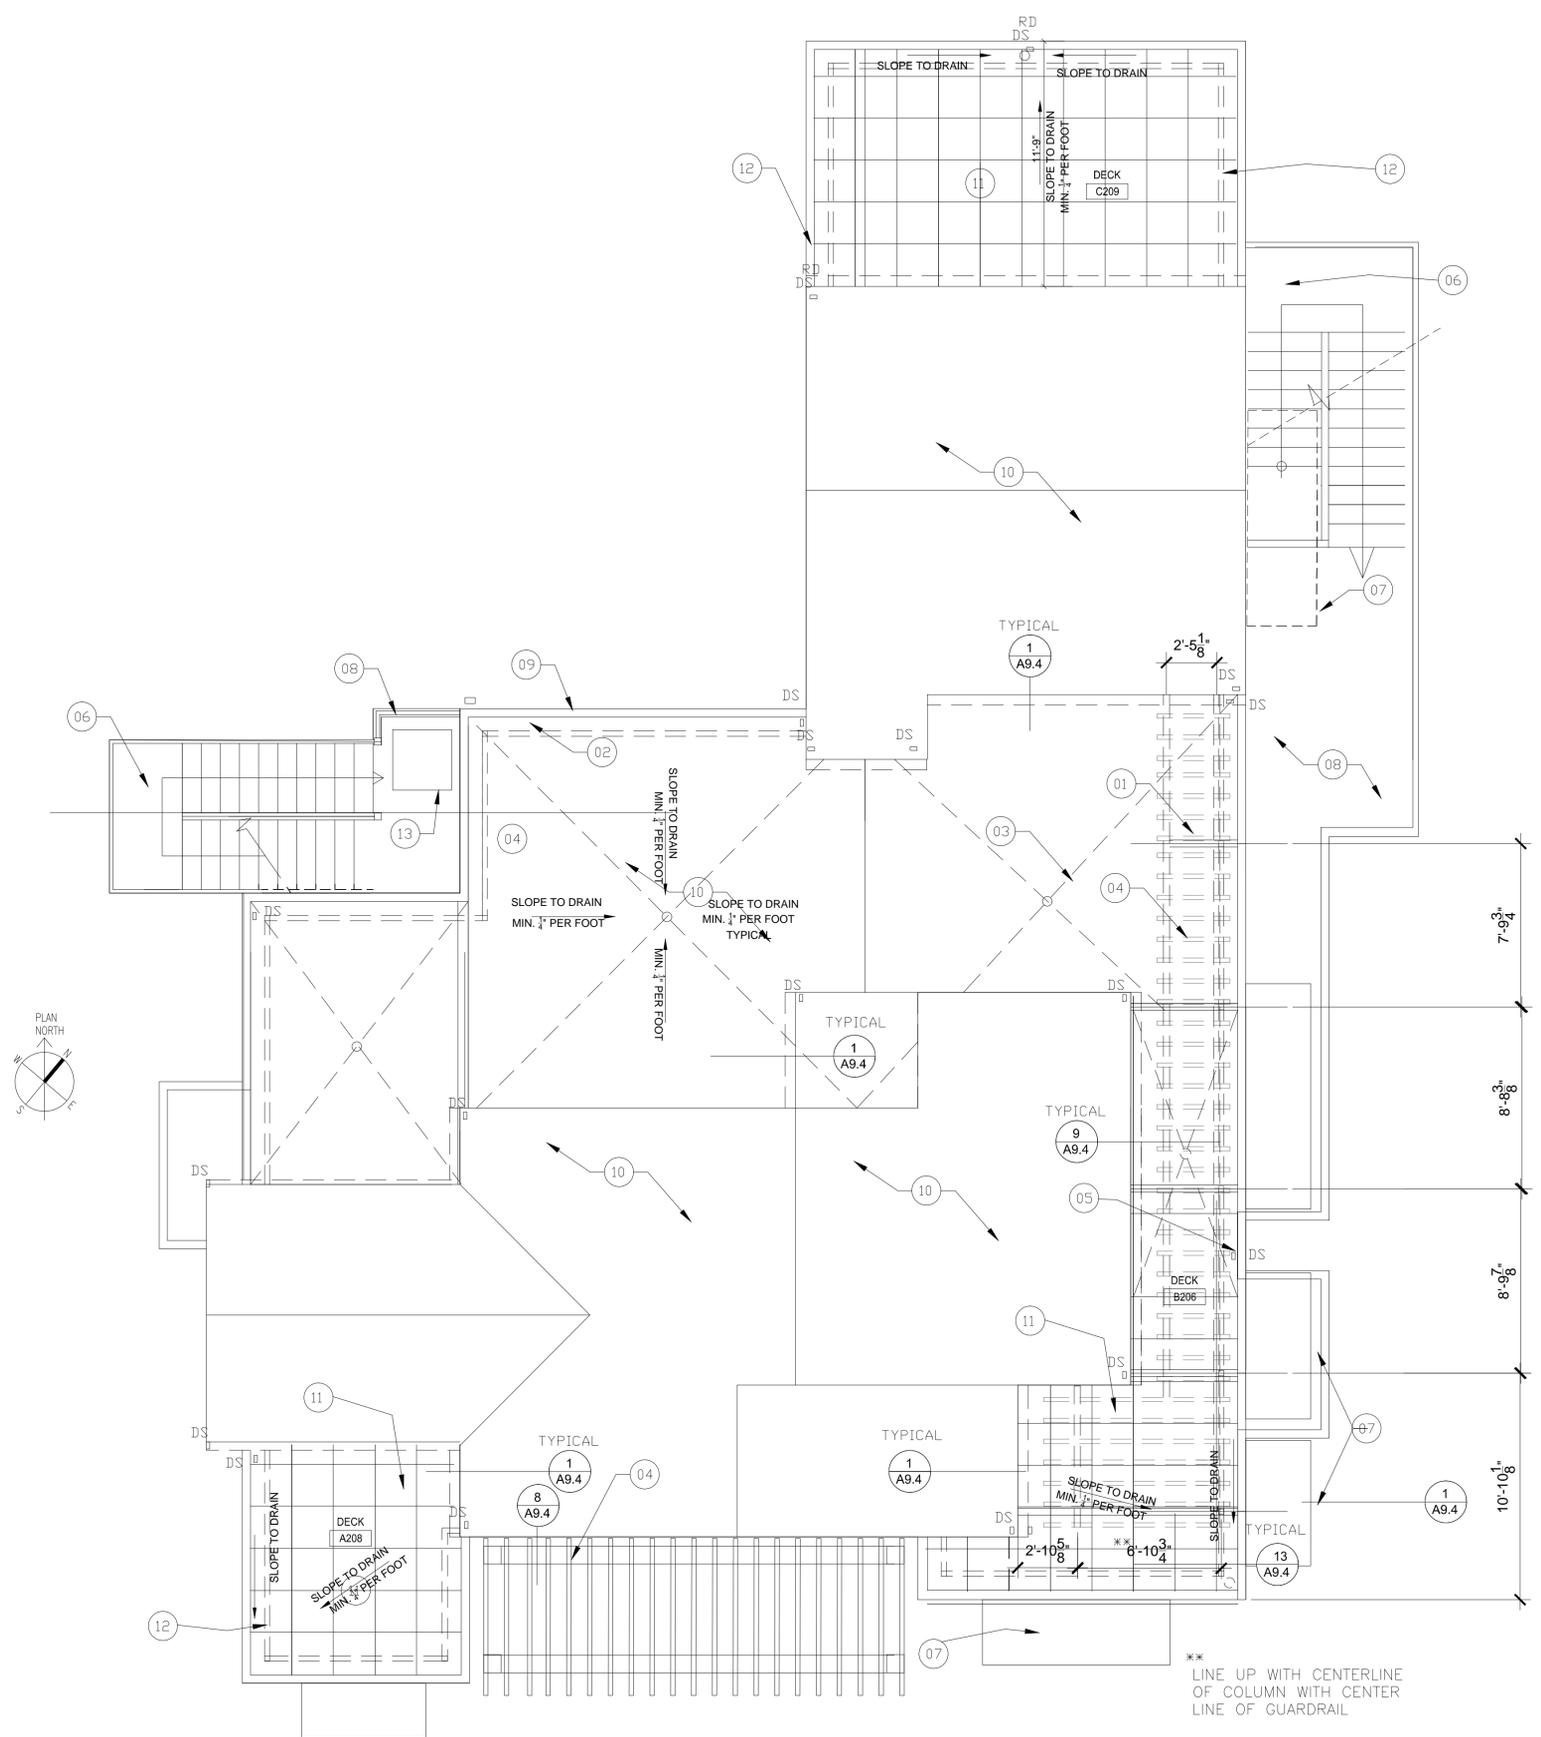COMMUNITY CENTER ROOF PLAN

GENERAL NOTES

- A. ALL DIMENSIONS ARE TO FACE OF STUD OR CENTERLINE OF PARTITION WALL, INTERIOR COLUMN/ WINDOW/ DOOR UNLESS OTHERWISE NOTED.
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- C. FOR DOOR AND WINDOW KEYS REFER TO DOOR AND WINDOW SCHEDULE.

LEGEND

- ONE HOUR RATED WALL
- INTERIOR FULL HT. PARTITION
- INTERIOR BEARING PARTITION WALL
- EPS TRIM - MOLDING

KEYNOTES ROOF PLAN

- 01 BEAM AT ROOF TRELLIS.
- 02 ROOF LINE OF PARAPET.
- 03 BUILT UP ROOF WITH 90 LB. CAP SHEET CLASS B ROOF SYSTEM. PROVIDE MIN 1/4\"/>

REVISIONS	BY
9/26/2011 - PLAN CHECK	G.G.
1/09/2014	STF
GUARDAIL REVISED	
1/09/2014	
REVISED ROOF DRAINAGE	
1-10-2014	
REVISED ROOF DRAINAGE, WINDOWS AT HALLWAY	
1-26-2014	
ADDED ENLARGED PLAN SHEET	



OAKLEY & OAKLEY
 ARCHITECT, CIVIL & STRUCTURAL ENGINEERS
 7000 DELCRAWLER DRIVE, SUITE 615
 DUBLIN, CA 94568
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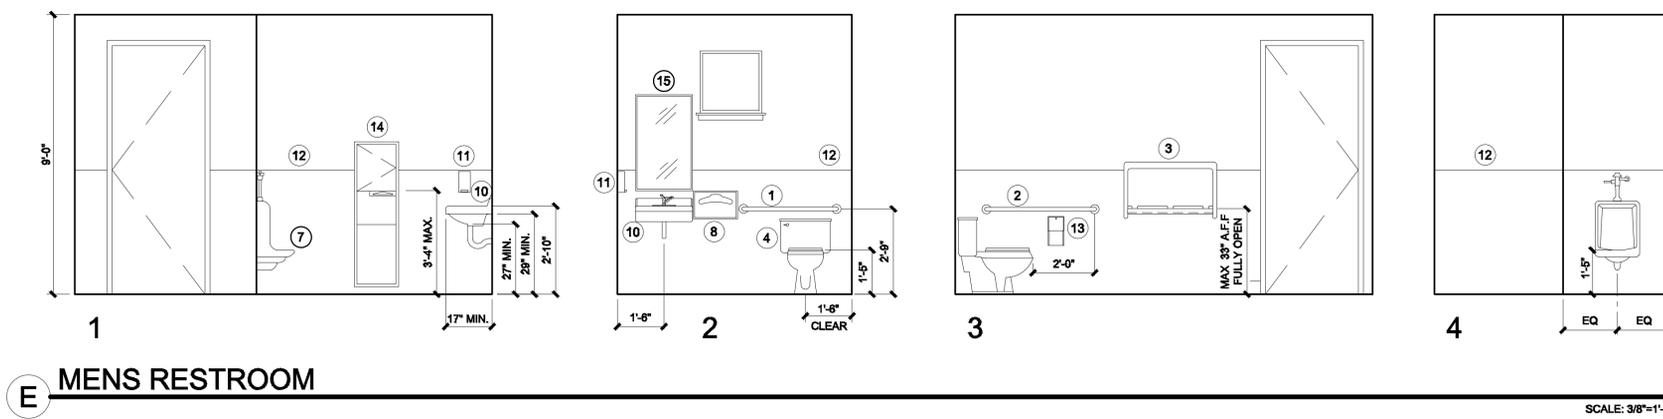
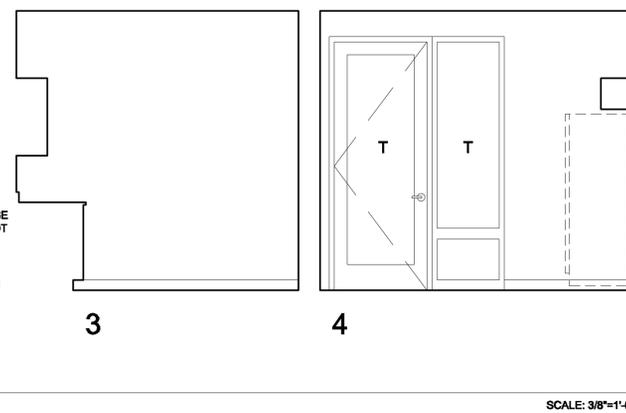
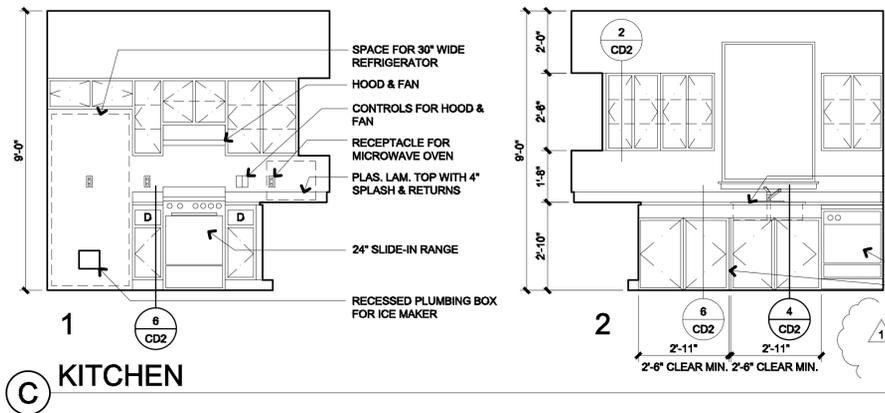
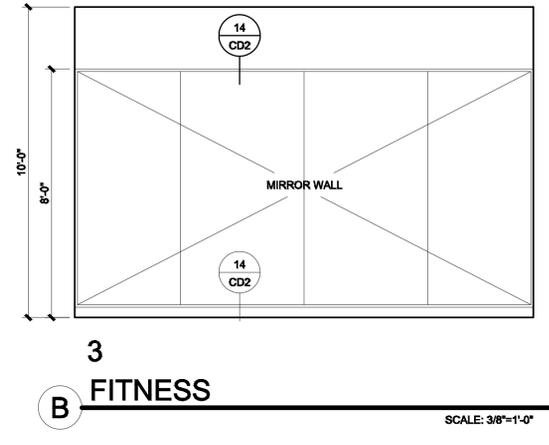
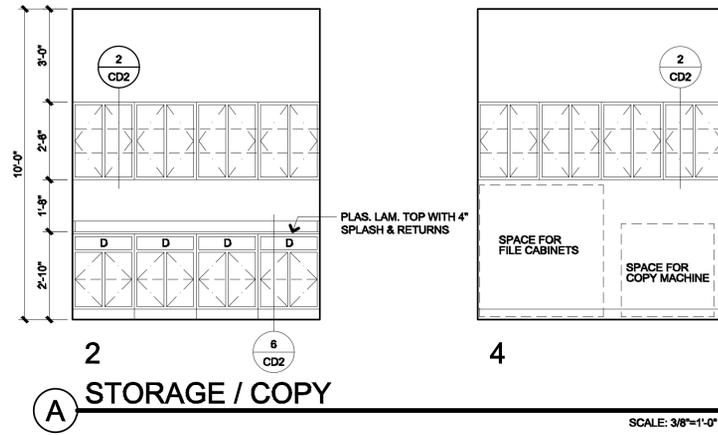
PROJECT TITLE:
COMMUNITY CENTER
 HARBOR PARK APARTMENTS
 969 PORTER STREET, VALLEJO, CA 94560

ENLARGED ROOF PLAN




Date:	04/10/2012
Scale:	3/16" = 1'-0"
Drawn:	STAFF
Checked:	RY
Job No.:	2011-09

Sheet:
A2.26
 Of Sheets


Jun 18, 2014 - 11010m Z:\Year 2011 Jobs\2011-093 - Community_Bldg\REVISED DRAWINGS FOR NEGOTIATED CONTRACT WITH WE LYONS\ARCHITECTURE\A2.29 INTERIOR ELEVATIONS UNITS A,B,C.dwg



- RESTROOM KEY NOTES**
- 1 36" GRAB BAR AT +33" A.F.F.
 - 2 42" GRAB BAR AT +33" A.F.F.
 - 3 B-2210 DIAPER CHANGING STATION. MOUNT PER MFR SPECS, BOTTOM AT 26 1/2" A.F.F.
 - 4 WATER CLOSET
 - 5 60" TURNING RADIUS
 - 6 30" x 48" CLEAR SPACE AT SINK
 - 6.1 36" x 48" CLEAR SPACE AT URINAL
 - 7 URINAL (HC) MOUNTED AT 17" TO RIM OF URINAL
 - 8 B-4221 TOILET SEAT COVER DISPENSER
 - 9 B-270 SANITARY NAPKIN DISPOSAL
 - 10 SINK
 - 11 B-2112 SURFACE MOUNTED SOAP DISPENSER
 - 12 TILE WAINSCOT
 - 13 B-2888 TOILET TISSUE DISPENSER
 - 14 B-3944 PAPER TOWEL DISPENSER & TRASH RECEPTACLE
 - 15 MIRROR - MOUNT BOTTOM AT 40" A.F.F.
- SEE SHEETS X1, X2 AND X3 FOR SPECIFIC HANDICAPPED REQUIREMENTS
- PROVIDE BLOCKING AS REQUIRED FOR ALL WALL MOUNTED FIXTURES, AND ALL HANDICAPPED RELATED ITEMS

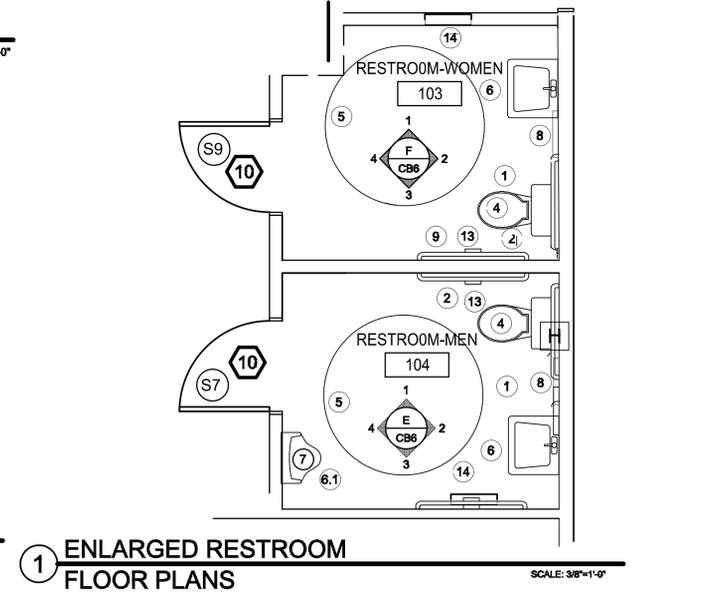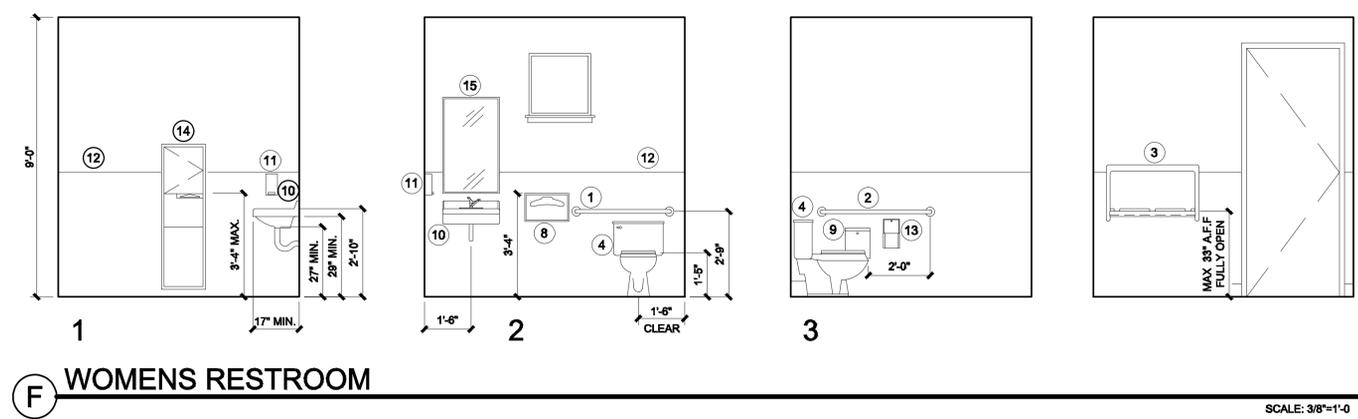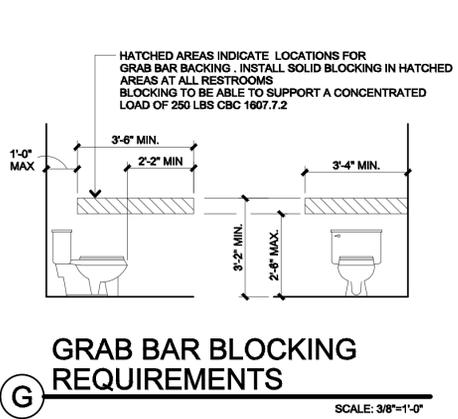

REVISIONS	BY
9/26/2011 - PLAN CHECK	G.O.

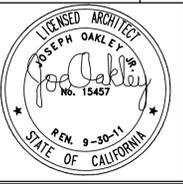


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 ARCHITECTS & STRUCTURAL ENGINEERS
 2700 CALIFORNIA STREET, SUITE 615
 OAKLAND, CA 94612
 P.A.Y. 510.962.8043

PROJECT TITLE:
COMMUNITY CENTER
 HARBOR PARK APARTMENTS
 959 PORTER STREET, VALLEJO, CA 94560
 DRAWING TITLE:
UNIT A FLOOR PLAN & INTERIOR ELEVATIONS


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Scale:	AS NOTED
Drawn:	STAFF
Checked:	RY
Job No.:	2011-09
Sheet:	A2.29
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Jun 27, 2014 - 11:54pm \\Server\server drive d\Year 2011_Jobs\2011-093 - Community Big\REVISED DRAWINGS FOR NEGOTIATED CONTRACT WITH VE LYONS\ARCHITECTURE\2.3 INTERIOR ELEVATIONS UNITS A,B,C\revised_09g.dwg

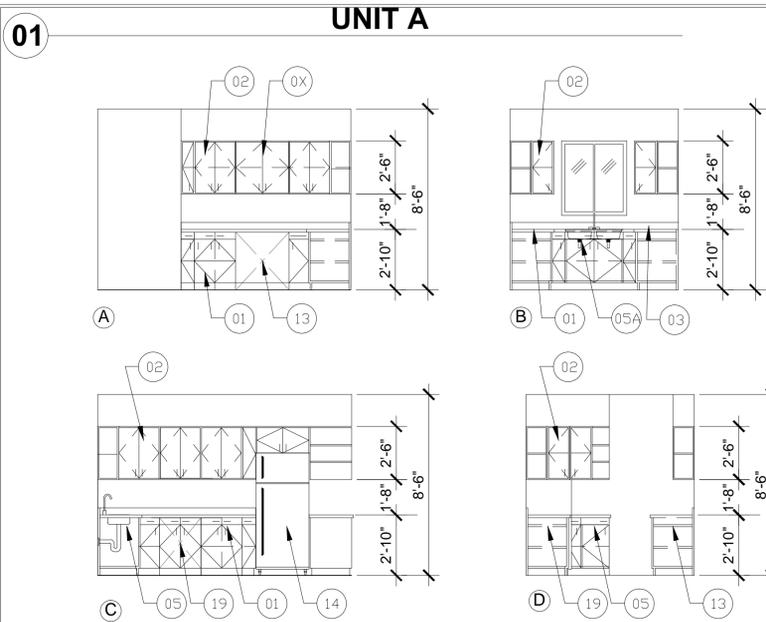


02 KITCHEN INTERIOR ELEVATION

SCALE: 1/4" = 1'-0"

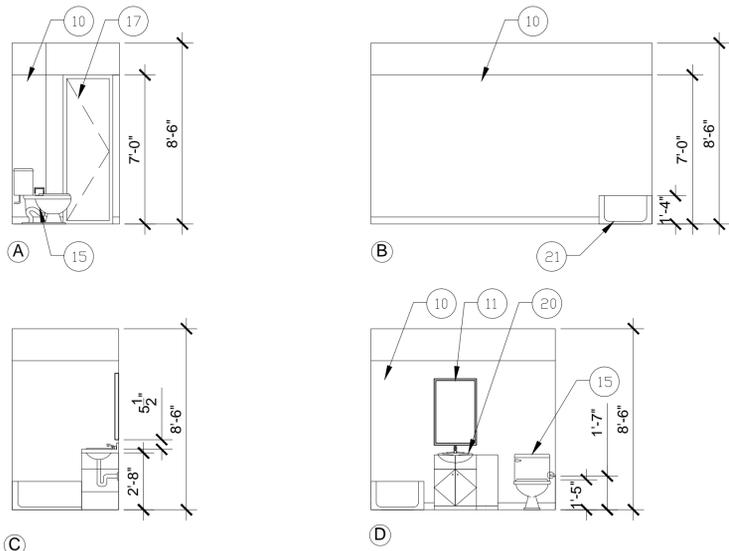


03 BATHROOM A206 INTERIOR ELEVATION

SCALE: 1/4" = 1'-0"

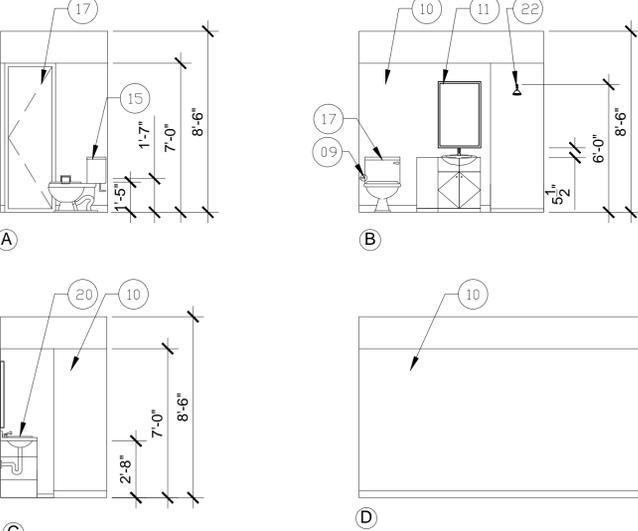


04 BATHROOM A205-A INTERIOR ELEVATION

SCALE: 1/4" = 1'-0"

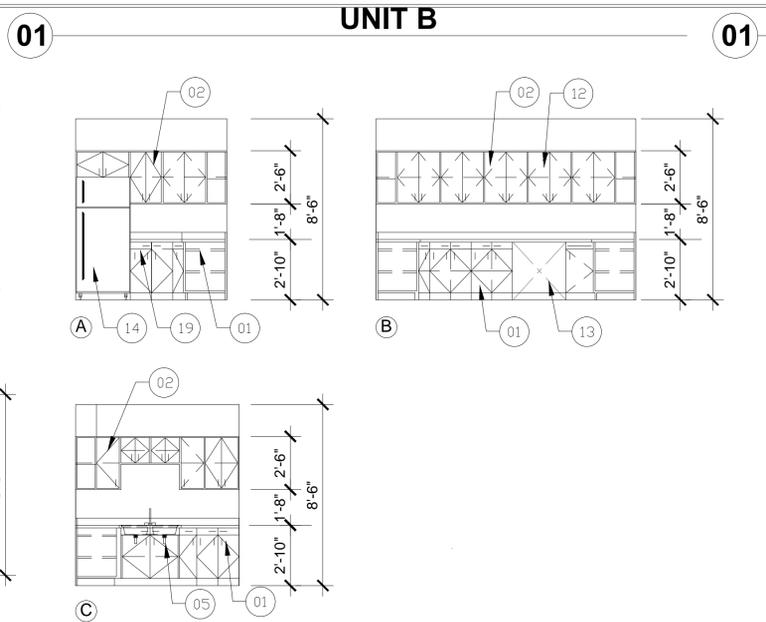

02 KITCHEN INTERIOR ELEVATION

SCALE: 1/4" = 1'-0"

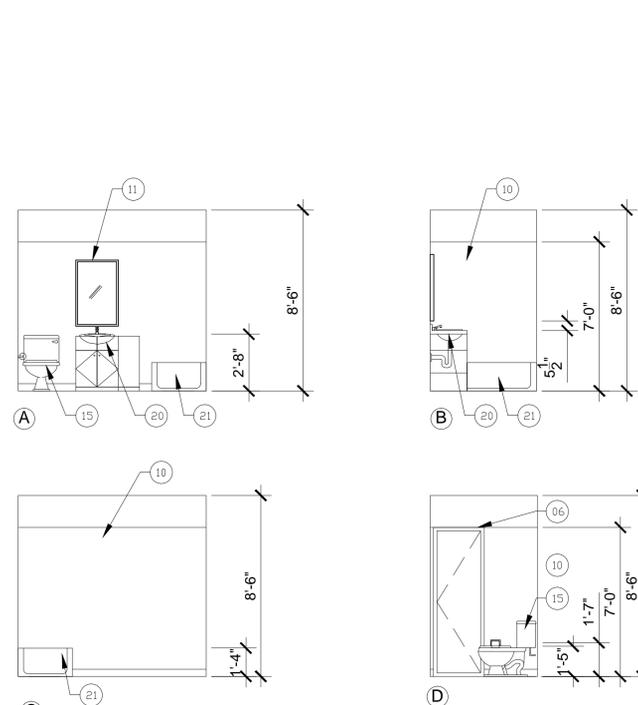


03 BATHROOM B204 INTERIOR ELEVATION

SCALE: 1/4" = 1'-0"




04 BATHROOM C204-A INTERIOR ELEVATION

SCALE: 1/4" = 1'-0"

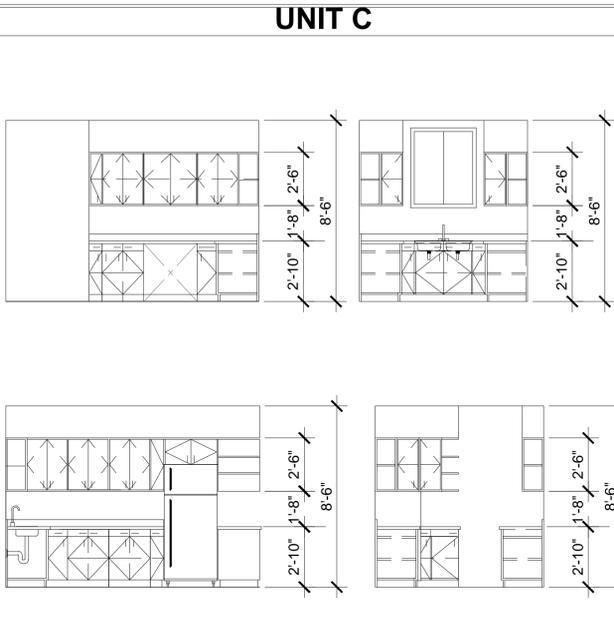


02 KITCHEN INTERIOR ELEVATION

SCALE: 1/4" = 1'-0"

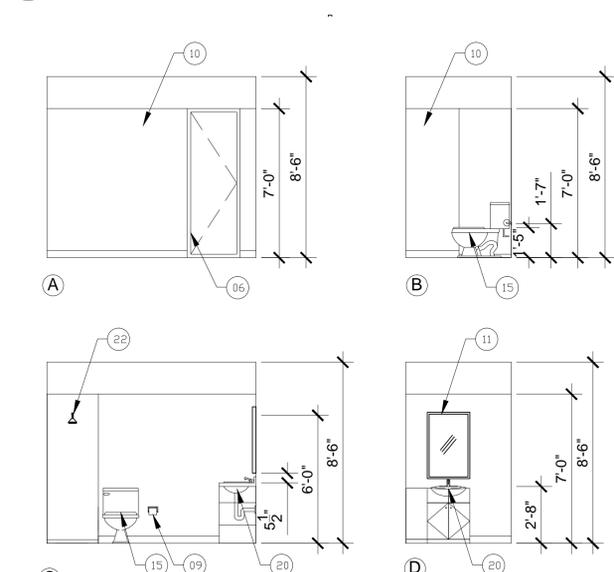

03 BATHROOM C206-A INTERIOR ELEVATION

SCALE: 1/4" = 1'-0"

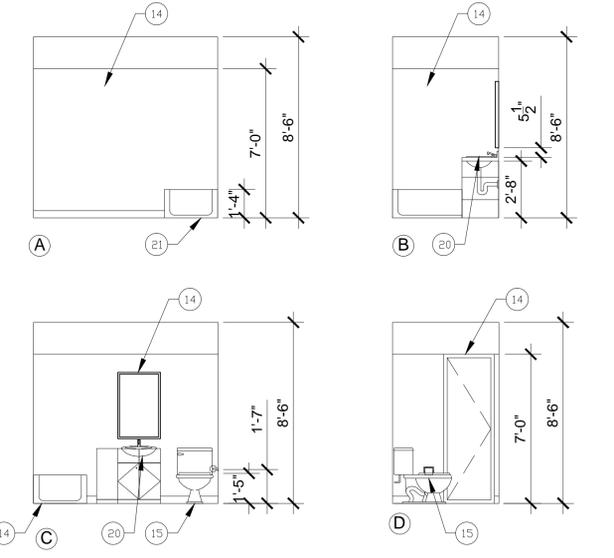

04 BATHROOM C204-A INTERIOR ELEVATION

SCALE: 1/4" = 1'-0"



KEYNOTES

- 01 BASE CABINETS.
- 02 UPPER CABINETS.
- 03 BACK SPLASH
- 04 GRANITE FINISH
- 05 DOUBLE SINK, MIN. 30" SPACE BELOW COUNTER.
- 55A. BASE CABINETS AT UNIT A
SHALL BE REMOVABLE FOR ADA COMPLIANCE
- 06 WOOD TRIM
- 07 PAPER TOWEL DISPENSER
- 08 BLOCK OUT WALL
- 09 TOILET TISSUE DISPENSER
- 10 PRE FABRICATED TUB, SHOWER AND WALL FINISH.
ALL COUNTER TOPS SHALL HAVE GRANITE FINISHES.
- 11 MIRROR
- 12 RANGE HOOD
- 13 CONVENTIONAL OVEN/STOVE
- 14 ACCESSIBLE REFRIGERATOR 30" MIN. CLR.
- 15 FLOOR MOUNTED TOILET
- 16 FLOOR DRAIN
- 17 SOLID WOOD DOOR, SEE DOOR SCHEDULE
- 18 COUNTER TOP MICROWAVE
- 19 DISHWASHER
- 20 SINK SPD
- 21 TUB SPD
- 22 SHOWER

GENERAL NOTES

- A. ALL DIMENSIONS ARE TO FACE OF STUD OR CENTERLINE OF PARTITION WALL, INTERIOR COLUMN/ WINDOW/ DOOR UNLESS OTHERWISE NOTED.
- B. DETAILS ARE KEYED AND NOTED "TYPICAL" ONLY ONCE ON THE PLANS WHEN THEY FIRST OCCUR, AND ARE REPRESENTATIVE OF SIMILAR CONDITIONS THROUGHOUT, UNLESS OTHERWISE NOTED.
- C. PROVIDE WATER-RESISTANT GYP. BOARD AT ALL WET WALL LOCATIONS.
- D. FOR DOOR AND WINDOW KEYS REFER TO DOOR AND WINDOW SCHEDULE. SEE A9.1 REFER TO INTERIOR ELEVATION FOR CABINETS CALLOUTS. SEE SHEET A2.3, A2.4 & A2.5.
- E. FOR ALL TOILETS ACCESSORIES & HEIGHTS REFER TO A2.3, A2.4 & A2.5
- F. FOR FINISH FLOOR REFER TO FINISH SCHEDULE A4.1.
- G. PROVIDE ACOUSTICAL SEALANT AT ALL WALLS AND CEILING CONDITION.
- H. PROVIDE 5/8" THK. GYP. BD. MOISTURE RESISTANT AT WET AREAS , E RESTROOMS, LAUNDRY AREA, CLASS RESTROOM, & KITCHEN SINK AREA.
- I. PROVIDE WD. BLOCKING BEHIND GYPSUM BD. PARTITION FOR ATTACHMENT FOR ALL FIXTURE, FITTINGS, ART WORK & ACCESSORIES.
- J. PROVIDE WD. BLOCKING AT CEILING FOR BLINDS AT WINDOW WHERE REQUIRED.
- K. PROVIDE TACKLE SIGN AT EXIT DOORS WITH THE WORD "EXIT" PER CBC. 1011.3.
- L. GROUND AND FLOOR SURFACES AT ACCESSIBLE ROUTES TO BE SLIP RESISTANCE PER CBC. 1124.B
- M. SLOPE FLOOR DRAIN 1/4"=1'-0 SEE PLUMBING DWGS.
- N. PROVIDE WD BLOCKING IN WALL AT GRAB BAR, CABINETS, SHELVES, AND CEILINGS AS REQUIRED FOR WINDOW SHADING.
- O. PLYWOOD SHEAR WALL TO EXTEND FULL HEIGHT OF THE WALL. SSD.
- P. INTERIOR FINISHES CEILINGS & WALLS SHALL BE CLASSIFIED W/ASTME 84-TYPE "C" FLAMED SPREAD 76-200, SMOKE DEVELOPED AT 0-450. TESTED W/NFPA 286
- Q. INTERIOR TRIM SHALL HAVE A MIN. CLASS C FLAMED SPREAD & SMOKE DEVELOP INDEX WHEN TESTED W/ASTME-84 AND NOT TO EXCEED 10% OF AGGREGATE WALL OR CLG.

LEGEND

- ONE HOUR RATED WALL
- INTERIOR FULL HT. PARTITION
- INTERIOR BEARING PARTITION WALL
- FIRE EXTINGUISHER

REVISIONS	BY
9/26/2011 - PLAN CHECK	G.O.
1-20-2014 - BIDDING	LR



PROJECT TITLE:
COMMUNITY CENTER
 HARBOR PARK APARTMENTS
 959 PORTER STREET, VALLEJO, CA 94560
 DRAWING TITLE:
INTERIOR ELEVATIONS

OAKLEY & OAKLEY
 ARCHITECTS
 2700 COLLEGEWAY & STRUCTURAL ENGINEERS
 OAKLAND, CA 94612
 P.A.V. 510.962.8043

Date:	04/17/2012
Scale:	AS NOTED
Drawn:	STAFF
Checked:	RY
Job No.:	2011-09


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A2.3
 Of _____ Sheets

Jan 20, 2014 - 1:41pm 2\Year 2011-09-3 - Community_Bldg\REVISED DRAWINGS FOR NEGOTIATED CONTRACT WITH VE LYDINS\ARCHITECTURE\A4.0 REFLECTED CEILING PLAN COMMUNITY ROOM_080812.dwg

KEYNOTES

- 1 STUCCO SOFFIT
- 2 1 HOUR RATED GYPSUM BOARD CEILING FINISH
- 3 NON RATED SUSPENDED CEILING
- 4 PROVIDE 1 HOUR FIRE DAMPERS AT OPENINGS AT 1 HOUR RATED CEILING
- 5 SCONCE LIGHTING FIXTURE
- 6 TROUGH LIGHTING-SINGLE LINE FLOURESCENT FIXTURE WITH 2X12 WOOD FACE, 2X8 TROUGH BOTTOM

REVISIONS	BY
9/26/2011 - PLAN CHECK	G.O.
01/08/2014 - BIDDING	TG
01/09/2014 - BIDDING	TG

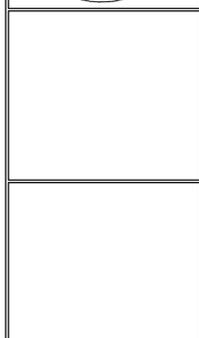

OAKLEY & OAKLEY
 ARCHITECTURAL & STRUCTURAL ENGINEERS
 244 KLAND, CA 94621
 P.A.Y. 570.962.8043


- ### GENERAL NOTES
- ALL DIMENSIONS ARE TO FACE OF STUD OR CENTERLINE OF PARTITION WALL, INTERIOR COLUMN/ WINDOW/ DOOR UNLESS OTHERWISE NOTED.
 - DETAILS ARE KEYED AND NOTED "TYPICAL" ONLY ONCE ON THE PLANS WHEN THEY FIRST OCCUR, AND ARE REPRESENTATIVE OF SIMILAR CONDITIONS THROUGHOUT, UNLESS OTHERWISE NOTED.
 - PROVIDE WATER-RESISTANT GYP. BOARD AT ALL WET WALL LOCATIONS.
 - FOR DOOR AND WINDOW KEYS REFER TO DOOR AND WINDOW SCHEDULE. SEE A9.1
 - REFER TO INTERIOR ELEVATION FOR CABINETS CALLOUTS. SEE SHEET A2.3, A2.4 & A2.5.
 - FOR ALL TOILETS ACCESSORIES & HEIGHTS REFER TO A2.3, A2.4 & A2.5
 - FOR FINISH FLOOR REFER TO FINISH SCHEDULE A4.1.
 - PROVIDE ACOUSTICAL SEALANT AT ALL WALLS AND CEILING CONDITION.
 - PROVIDE 5/8" THK. GYP. BD. MOISTURE RESISTANT AT WET AREAS, BATHROOMS & KITCHEN SINK AREA.
 - PROVIDE WD. BLOCKING BEHIND GYPSUM BD. PARTITION FOR ATTACHMENT FOR ALL FIXTURE, FITTINGS, ART WORK & ACCESSORIES.
 - PROVIDE WD. BLOCKING AT CEILING FOR BLINDS AT WINDOW WHERE REQUIRED.
 - GROUND AND FLOOR SURFACES AT ACCESSIBLE ROUTES TO BE SLIP RESISTANCE PER CBC. 1124.B
 - SLOPE FLOOR DRAIN 1/4"=1'-0 SEE PLUMBING DWGS.
 - PROVIDE WD BLOCKING IN WALL AT GRAB BAR, CABINETS, SHELVES, AND CEILINGS AS REQUIRED FOR WINDOW SHADING.
 - PLYWOOD SHEAR WALL TO EXTEND FULL HEIGHT OF THE WALL. SSD.
 - INTERIOR FINISHES CEILINGS & WALLS SHALL BE CLASSIFIED W/ASTM 84-TYPE "C" FLAMED SPREAD 76-200, SMOKE DEVELOPED AT 0-450. TESTED W/NFPA 286
 - INTERIOR TRIM SHALL HAVE A MIN. CLASS C FLAMED SPREAD & SMOKE DEVELOP INDEX WHEN TESTED W/ASTM-84 AND NOT TO EXCEED 10% OF AGGREGATE WALL OR CLG.
 - REFER TO SHEET AX.0X FOR WALL TYPE LEGEND

LEGEND

- ONE HOUR RATED WALL.
- INTERIOR FULL HT. PARTITION.
- INTERIOR BEARING PARTITION WALL.
- FIRE EXTINGUISHER


PROJECT TITLE:
COMMUNITY CENTER
 HARBOR PARK APARTMENTS
 959 PORTER STREET, VALLEJO, CA 94560
 DRAWING TITLE:
REFLECTED CEILING PLAN

Date:	04/17/2012
Scale:	AS NOTED
Drawn:	STAFF
Checked:	RY
Job No.:	2011-09
Sheet:	A4.0
Of	Sheets

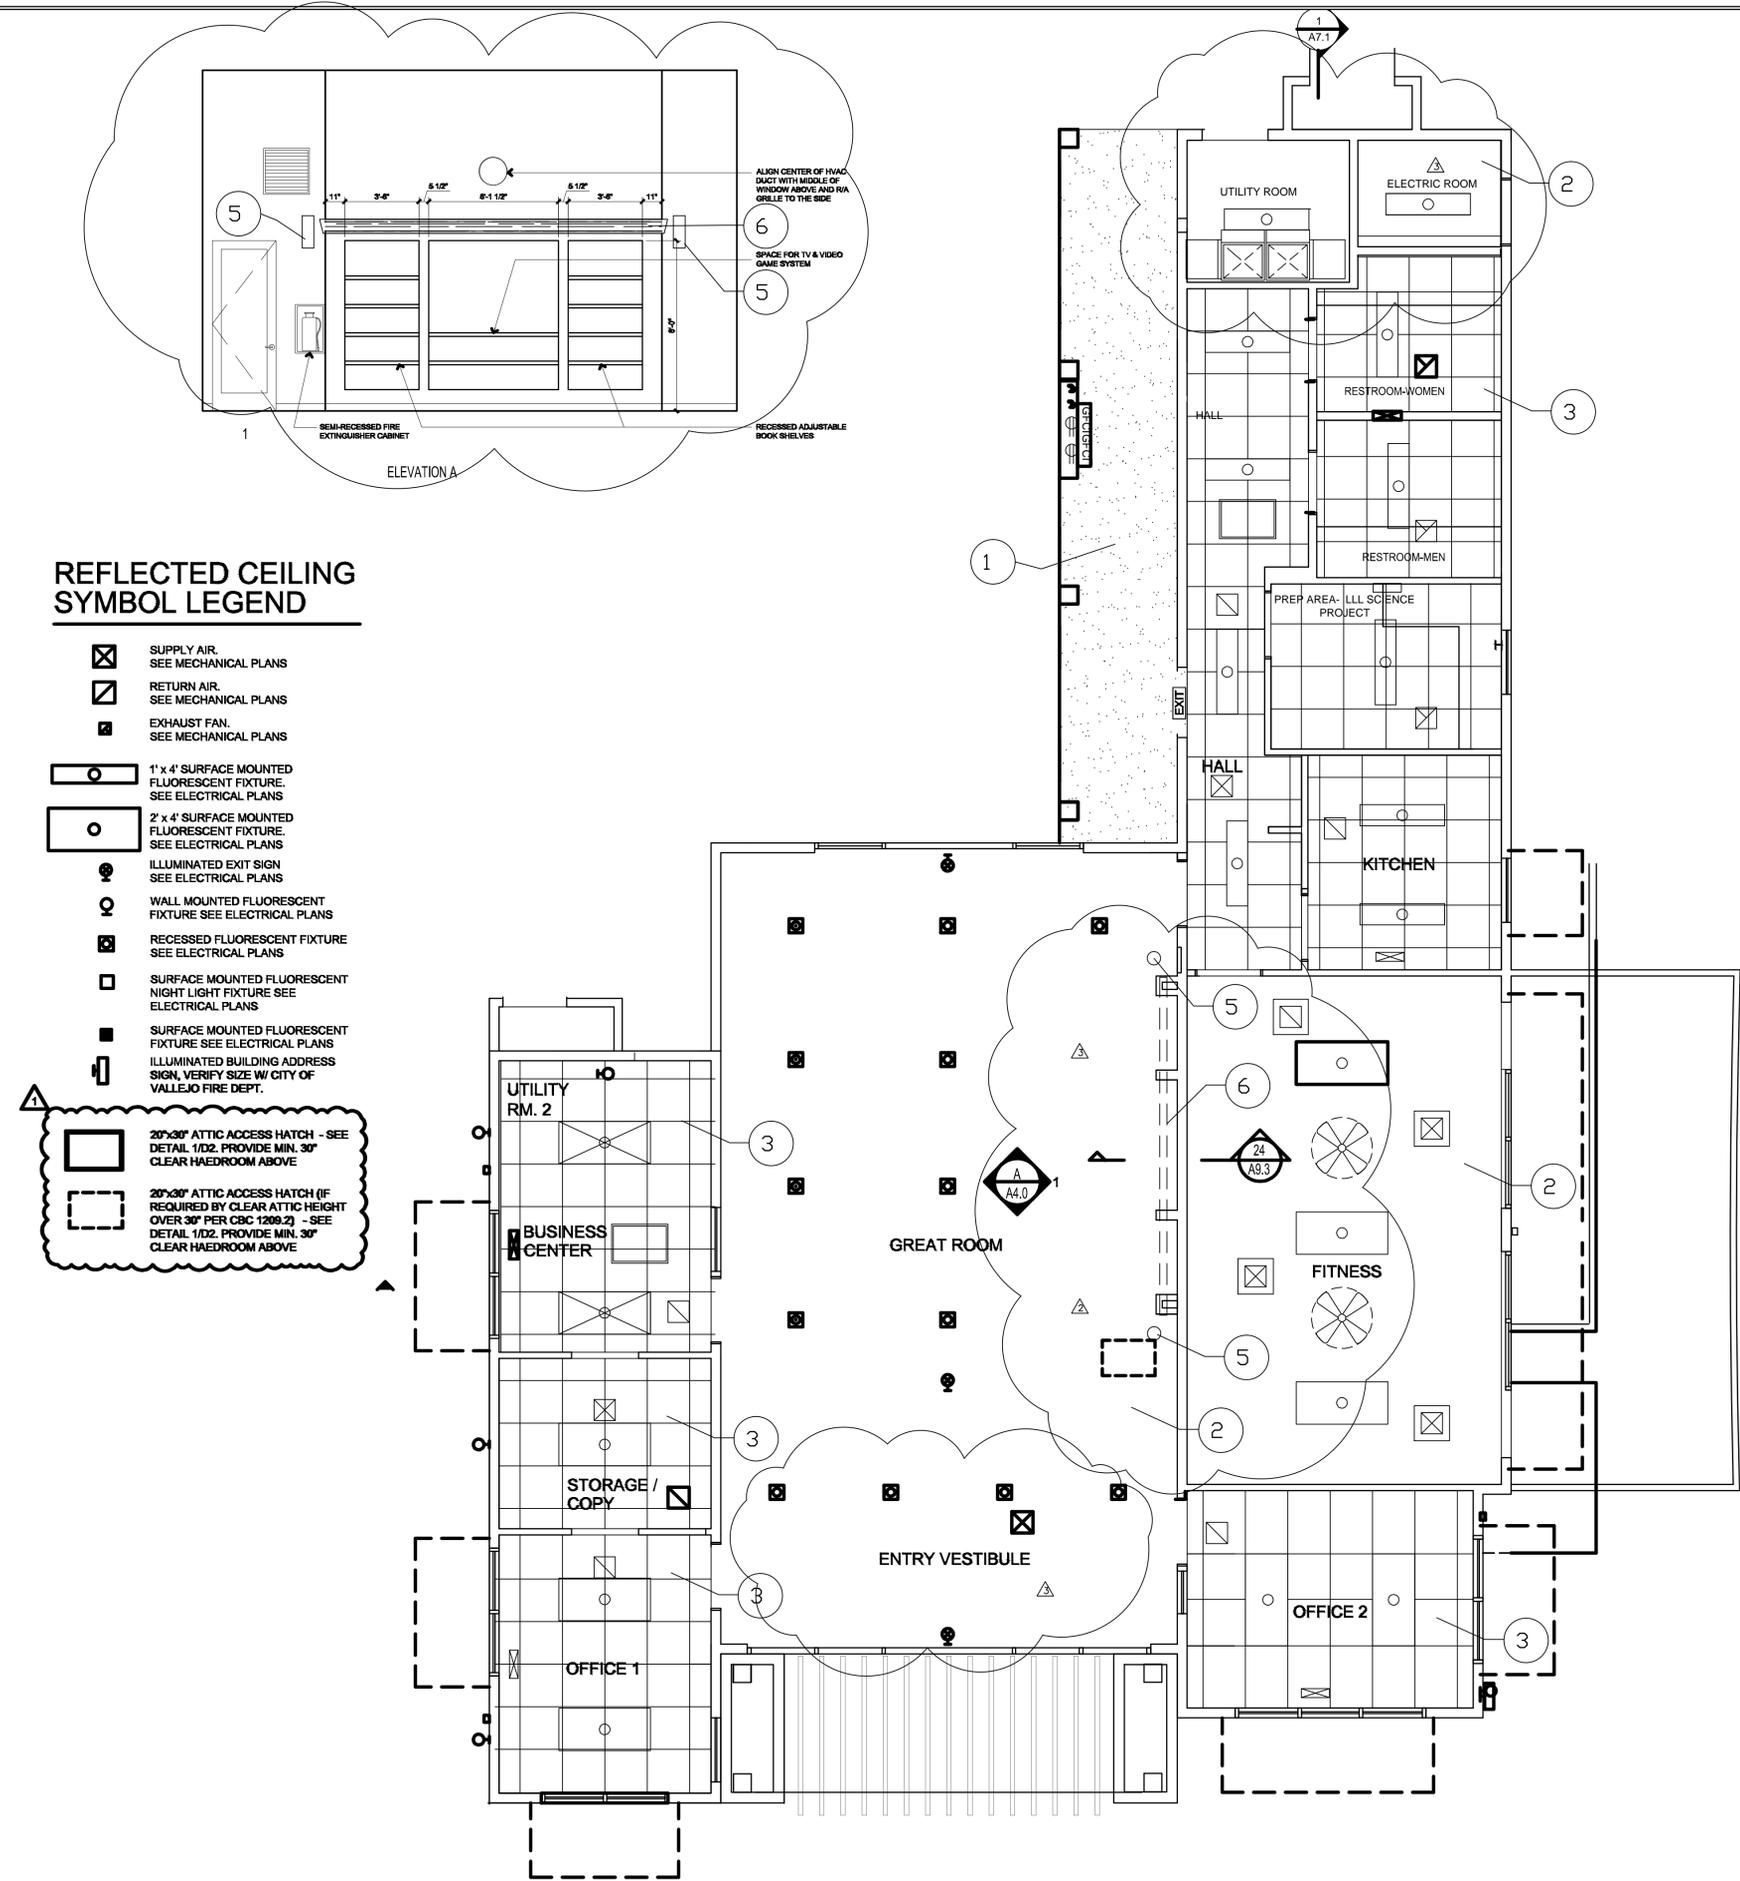

REFLECTED CEILING SYMBOL LEGEND

- SUPPLY AIR. SEE MECHANICAL PLANS
- RETURN AIR. SEE MECHANICAL PLANS
- EXHAUST FAN. SEE MECHANICAL PLANS
- 1' x 4' SURFACE MOUNTED FLUORESCENT FIXTURE. SEE ELECTRICAL PLANS
- 2' x 4' SURFACE MOUNTED FLUORESCENT FIXTURE. SEE ELECTRICAL PLANS
- ILLUMINATED EXIT SIGN. SEE ELECTRICAL PLANS
- WALL MOUNTED FLUORESCENT FIXTURE. SEE ELECTRICAL PLANS
- RECESSED FLUORESCENT FIXTURE. SEE ELECTRICAL PLANS
- SURFACE MOUNTED FLUORESCENT NIGHT LIGHT FIXTURE. SEE ELECTRICAL PLANS
- SURFACE MOUNTED FLUORESCENT FIXTURE. SEE ELECTRICAL PLANS
- ILLUMINATED BUILDING ADDRESS SIGN. VERIFY SIZE W/ CITY OF VALLEJO FIRE DEPT.
- 20' x 30' ATTIC ACCESS HATCH - SEE DETAIL 1/D2. PROVIDE MIN. 30" CLEAR HEADROOM ABOVE
- 20' x 30' ATTIC ACCESS HATCH (IF REQUIRED BY CLEAR ATTIC HEIGHT OVER 30" PER CBC 1209.2) - SEE DETAIL 1/D2. PROVIDE MIN. 30" CLEAR HEADROOM ABOVE

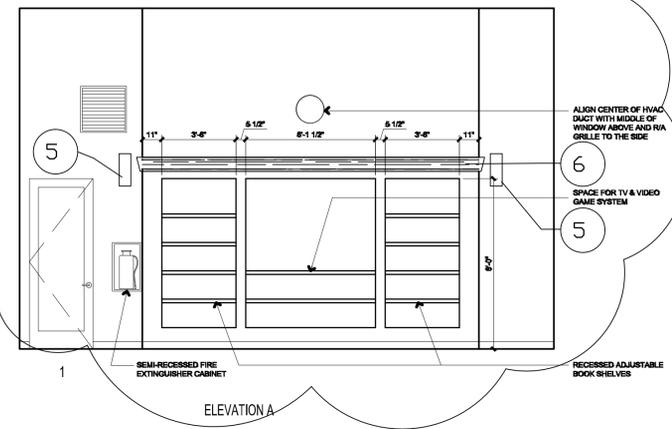

Jan 27, 2014 - 6:07pm \\SERVER\Server Drive D\Year 2011 Jobs\2011-09-3 - Community Blog\REVISED DRAWINGS FOR NEGOTIATED CONTRACT WITH VE LYONS\ARCHITECTURE\4.11 Finish Plan And Finish Schedule.dwg

01 FINISH SCHEDULE-UNITS A, B, C

SCALE: NO SCALE

NUMBER	NAME	FLOOR	CEILING	BASE	WALL				NOTES
					NORTH	SOUTH	EAST	WEST	
A201	LIVING ROOM	F1	C1	B4	W1, P1	W1, P1	W1, P1	W1, P1	
A202	DINING ROOM	F1	C1	B4	W1, P1	W1, P1	W1, P1	W1, P1	
A203	KITCHEN	F2	C1	B3	W1, P2	W1, P2	W1, P2	W1, P2	
A204	BEDROOM	F1	C1	B4	W1, P1	W1, P1	W1, P1	W1, P1	
A204A	CLOSET	F1	C1	B4	W1, P1	W1, P1	W1, P1	W1, P1	
A204AA	LAUNDRY	F2	C1	B3	W1, P2	W1, P2	W1, P2	W1, P2	
A205	BEDROOM	F1	C1	B4	W1, P1	W1, P1	W1, P1	W1, P1	
A205A	BATHROOM	F4	C1	B3	W1, P2	W1, P2	W1, P2	W1, P2	W2 AT TUBS/SHOWERS
A205B	CLOSET	F1	C1	B4	W1, P1	W1, P1	W1, P1	W1, P1	
A206	BEDROOM	F1	C1	B4	W1, P1	W1, P1	W1, P1	W1, P1	
A206A	BATHROOM	F4	C1	B3	W1, P2	W1, P2	W1, P2	W1, P2	W2 AT TUBS/SHOWERS
A206B	CLOSET	F1	C1	B4	W1, P1	W1, P1	W1, P1	W1, P1	
A207	DECK	F5	C1	---	---	---	---	---	
A207A	BATHROOM	F4	C1	B3	W1, P2	W1, P2	W1, P2	W1, P2	W2 AT TUBS/SHOWERS
A207B	CLOSET	F1	C1	B4	W1, P1	W1, P1	W1, P1	W1, P1	
A208	DECK	F5	---	---	---	---	---	---	DEXOTEX FINISH UNDER TILE
B201	LIVING ROOM	F1	C1	B4	W1, P1	W1, P1	W1, P1	W1, P1	
B202	DINING ROOM	F1	C1	B4	W1, P1	W1, P1	W1, P1	W1, P1	
B203	KITCHEN	F4	C1	B3	W1, P2	W1, P2	W1, P2	W1, P2	
B204	BATHROOM	F4	C1	B3	W1, P2	W1, P2	W1, P2	W1, P2	W2 AT TUBS/SHOWERS
B205	BEDROOM	F1	C1	B4	W1, P1	W1, P1	W1, P1	W1, P1	
B205A	CLOSET	F1	C1	B4	W1, P1	W1, P1	W1, P1	W1, P1	
B206	BATHROOM	F4	C1	B3	W1, P2	W1, P2	W1, P2	W1, P2	W2 AT TUBS/SHOWERS
B207B	CLOSET	F1	C1	B4	W1, P1	W1, P1	W1, P1	W1, P1	
B207C	CLOSET	F1	C1	B4	W1, P1	W1, P1	W1, P1	W1, P1	
B205A	CLOSET	F1	C1	B4	W1, P1	W1, P1	W1, P1	W1, P1	
B209	CLOSET	F1	C1	B4	W1, P1	W1, P1	W1, P1	W1, P1	
B209A	CLOSET	F1	C1	B4	W1, P1	W1, P1	W1, P1	W1, P1	
B206	DECK	F5	---	---	---	---	---	---	DEXOTEX FINISH UNDER TILE
C201	LIVING ROOM	F1	C1	B4	W1, P1	W1, P1	W1, P1	W1, P1	
C202	DINING ROOM	F1	C1	B4	W1, P1	W1, P1	W1, P1	W1, P1	
C203	KITCHEN	F2	C1	B3	W1, P2	W1, P2	W1, P2	W1, P2	
C204	CLOSET	F1	C1	B4	W1, P1	W1, P1	W1, P1	W1, P1	
C204A	CLOSET	F1	C1	B4	W1, P1	W1, P1	W1, P1	W1, P1	
C204B	CLOSET	F1	C1	B4	W1, P1	W1, P1	W1, P1	W1, P1	
C204C	BATHROOM	F2	C1	B4	W1, P2	W1, P2	W1, P2	W1, P2	W2 AT TUBS/SHOWERS
C205	BEDROOM	F1	C1	B4	W1, P1	W1, P1	W1, P1	W1, P1	
C206	BEDROOM	F1	C1	B4	W1, P1	W1, P1	W1, P1	W1, P1	
C206A	CLOSET	F1	C1	B4	W1, P1	W1, P1	W1, P1	W1, P1	
C206B	BEDROOM	F1	C1	B4	W1, P1	W1, P1	W1, P1	W1, P1	
C208	CLOSET	F1	C1	B4	W1, P1	W1, P1	W1, P1	W1, P1	
C208A	BATHROOM	F4	C1	B3	W1, P2	W1, P2	W1, P2	W1, P2	W2 AT TUBS/SHOWERS
C208B	CLOSET	F1	C1	B4	W1, P1	W1, P1	W1, P1	W1, P1	
C209	DECK	F5	---	---	---	---	---	---	DEXOTEX FINISH UNDER TILE

KEYNOTES

REVISIONS	BY
9/26/2011 - PLAN CHECK	G.O.
1/18/2011 - BIDDING	LR



GENERAL NOTES

CONTRACTOR SHALL BE RESPONSIBLE FOR VERIFICATION OF DIMENSION AND CLEARANCE REQUIREMENTS OF ALL EQUIPMENT. WHERE DIMENSIONS OR CLEARANCES CAUSE CONFLICT WITH OTHER INFORMATION CONTAINED WITHIN THE CONTRACT DOCUMENTS, CONTRACTOR SHALL VERIFY WITH ARCHITECT PRIOR TO PROCEEDING WITH WORK.

MAXIMUM FLAME SPREAD FOR INTERIOR FINISHES SHALL BE: CLASS X FOR EXIT WAYS; AND CLASS XI FOR ROOMS OR AREAS.

C. DO NOT COVER ANY SPRINKLER PIPING OR HARDWARE DURING CONSTRUCTION UNTIL SUCH PIPING AND HARDWARE HAS BEEN INSPECTED AND APPROVED.

SEE SHEET A9.1 FOR WINDOW AND DOOR SCHEDULES.

OAKLEY & OAKLEY
 ARCHITECTURAL & STRUCTURAL ENGINEERS
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 OAKLAND, CA 94612 DRIVE, STE. 615
 949
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 FAX 910-562-6043

ABBREVIATIONS

BASE:
RBT RUBBER TOPSET 4" HIGH.

ECB EPOXY COATING, COVED.
RBC RUBBER BASE, COVED.

FLOOR:
VCT VINYL COMPOSITE TILE.
LIN LINOLEUM SHEET.
TZF TERRAZZO W / INTERGAL BASE.
ECF EPOXY COATING W / INTERGAL BASE.
SEC SEALED EXPOSED CONCRETE.

WALLS:
PT PAINT.

FRP FIBER REINFORCED PANEL.

CEILING:
PT GYPSUM BOARD PAINT FINISH.
ACT SUSPEND ACOUSTICAL TILE CEILING.

LEGEND

	LINOLEUM
	EXPOSED CONCRETE
	EPOXY COATING W / INTEGRAL BASE
	VINYL COMPOSITE TILE



FINISH LEGENDS

FLOORS	BASE	WALLS	CEILING	PAINT
F1 CARPET	B1 4" MDF BASE	W1 GYPSUM BOARD, SPRAY TEXTURED	C1 GYPSUM BOARD, SPRAY TEXTURED	P1 PAINT FLAT LATEX
F2 SHEET VINYL		W2 PREFABRICATED TUB, SHOWER AND WALL FINISH		P2 PAINT SEMI GLOSS
F3 CONCRETE SMOOTH FINISH SEALED				
F4	B3 4" RUBBER BASE			
F5 RUBBER TILE BY OWNER	B4 2" WOOD BASE			

GENERAL FINISH NOTES



- PAINT HVAC REGISTERS TO MATCH THE COLOR OF THE WALL ON WHICH THEY OCCUR
- NOT USED
- SQUARE ALL OUTSIDE CORNERS AT WALL, CEILING HEADERS, ARCHES SOFFITS, NICHES, DOORS, WINDOWS, ETC.

PROJECT TITLE:
COMMUNITY CENTER
 HARBOR PARK APARTMENTS
 969 PORTER STREET, VALLEJO, CA 94560
 DRAWING TITLE:
FINISH SCHEDULE

Date:	04/17/2012
Scale:	AS NOTED
Drawn:	STAFF
Checked:	RY
Job No.:	2011-09

Sheet:
A4.11
Of _____ Sheets

REVISIONS	BY
9/26/2011 - PLAN CHECK	G.O.
01/20/2014 - BIDDING	LR
01/27/2014 - BIDDING	JU

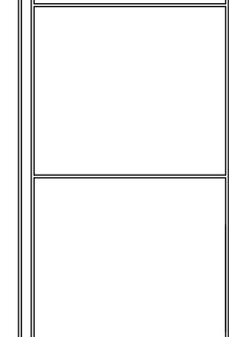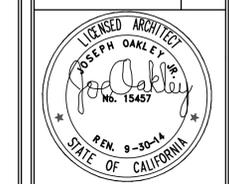

OAKLEY & OAKLEY
 ARCHITECTS & STRUCTURAL ENGINEERS
 7700 EGGWATER DRIVE, STE. 615
 OAKLAND, CA 94621
 TEL: 510.562.6043
 FAX: 510.562.6043

PROJECT TITLE:
COMMUNITY CENTER
 HARBOR PARK APARTMENTS
 969 PORTER STREET, VALLEJO, CA 94560
 DRAWING TITLE:
DOOR, WINDOW & FINISH SCHEDULE

Date: 08/30/2011
 Scale: AS NOTED
 Drawn: STAFF
 Checked: RY
 Job No.: 2011-09
 Sheet: **A4.10** of 10 Sheets

Commercial Hardware 1st Floor
 Hardware for exterior storefronts supplied by Glazing Contractor
 Lever exterior, panic hardware interior, Deadbolt
 Community Center Interior
 Interior Lock Specification:
 All Doors AL Series Neptune (NEP) Finish 626
 Door Closer:
 LCN 4030 F Parallel arm Non rated Silver 180 degree open
 HD09...
 Full Mortise 4.5x4.5 Standard Weight Brushed Chrome 260 McKinney TA2314
 Door Stops:
 Inco 4071 C Brushed Chrome
 Flush Bolts:
 Conventional


Designation		Door				Frame				Hardware				Notes				
Door #	Rm	Location	Size	Handing	Material	Rating	Glazing	Wall Size	Material	Type	Setline	Lockset	Closer	Door Stop	Threshold	Hinges	Weather Stripping	Notes
1	109	Interior	3-0x8-0x1-3/4	Right	SC Wood PG	NR	Full Lite wood frame	7-1/4"	AL White	Raco	none	AL70PD		Wall		2 Pair		Door is aluminum Raco door with Full Glass Light Clear
2	111	Interior	3-0x8-0x1-3/4	Left	SC Wood PG	NR	Full Lite wood frame	7-1/4"	AL White	Raco	3-0x8-0	AL70PD		Wall		2 Pair		Clear Glazing, Full Door Light, Full Sidelight
3	107	Interior	3-0x8-0x1-3/4	Left	SC Wood PG	NR	Full Lite wood frame	7-1/4"	AL White	Raco	2-0x8-0	AL70PD		Wall		2 Pair		Door is aluminum Raco door with Full Glass Light Clear
4	110	Interior	3-0x7-0x1-3/4	Right	SC Wood PG	NR	Full Lite wood frame	4-7/8"	AL White	Raco		AL70PD		Wall		1-1/2 Pair		Raco AL Frame
5	110	Interior	3-0x7-0x1-3/4	Right	SC Wood PG	NR	Full Lite wood frame	4-7/8"	AL White	Raco		AL70PD		Wall		1-1/2 Pair		Raco AL Frame
6	112	Interior	3-0x8-0x1-3/4	Right	AL	NR	Full Lite wood frame	7-1/4"	AL White	Raco		AL70PD		Wall		2 Pair		Clear Glazing, Full Door Light, Full Sidelight
7	109	Interior	3-0x8-0x1-3/4	Right	AL	NR	Full Lite wood frame	7-1/4"	AL White	Raco		AL70PD		Wall		2 Pair		Door is aluminum Raco door with Full Glass Light Clear
8	105	Interior	3-0x8-0x1-3/4	Right	AL	NR	Full Lite wood frame	4-7/8"	AL White	Raco	2-0x8-0	AL70PD		Wall		2 Pair		Door is aluminum Raco door with Full Glass Light Clear
9	Prep Area	Interior	3-0x8-0x1-3/4	Left	SC Wood PG	NR	Full Lite wood frame	4-7/8"	AL White	Raco		AL70PD		Wall		1-1/2 Pair		Raco AL Frame
10	104	Interior	3-0x7-0x1-3/4	Left	SC Wood PG	NR	Full Lite wood frame	4-7/8"	AL White	Raco		AL70PD	x	Wall		1-1/2 Pair		Raco AL Frame
11	103	Interior	3-0x7-0x1-3/4	Right	SC Wood PG	NR	Full Lite wood frame	4-7/8"	AL White	Raco		AL70PD	x	Wall		1-1/2 Pair		Raco AL Frame
12	100	Exterior	3-0x7-0x1-3/4	Left	HM	20 min		7-1/4"	HM	Welded		ALBPO						
13	102	Exterior	3-0x7-0x1-3/4	Left	HM	20 min		7-1/4"	HM	Welded		ALBPO						
14	UNK 2	Exterior	Pr 2-4x7-0x1-3/4		HM	20 min		7-1/4"	HM	Welded		ALBPO						Full Lower Doors w/ Admical and Concealed Flush Bolts
15	112	Exterior	Pr 3-0x8-0x1-3/4		Al Stone Front White	NR		3-0x8-0	AL White	Store Front System	See Window Sch.	Exterior Full Interior Panic	Surfmount ADA	2 ea Inco FS444	By Glazing Contractor	By Glazing Contractor		3 point lock with Schlage 5 pin Rim Cylinder. Keying and Keyway TBD
16	112	Exterior	Pr 3-0x8-0x1-3/4		Al Stone Front White	NR		4-3/4	AL White	Store Front System	See Window Sch.	Exterior Full Interior Panic	Surfmount ADA	2 ea Inco FS444	By Glazing Contractor	By Glazing Contractor		3 point lock with Schlage 5 pin Rim Cylinder. Keying and Keyway TBD
17	Hall	Exterior	3-0x8-0x1-3/4	Right	Al Stone Front White	NR		4-3/4	AL White	Store Front System		Lever Exterior Lever Interior	Surfmount ADA 180 Degree	By Glazing Contractor	By Glazing Contractor			Lock store room function
18	106	Exterior	3-0x8-0x1-3/4	Left	Al Stone Front White	NR		4-3/4	AL White	Store Front System		Lever Exterior Lever Interior	Surfmount ADA 180 Degree	By Glazing Contractor	By Glazing Contractor			Lock store room function
19	106	Exterior	3-0x8-0x1-3/4	Right	Al Stone Front White	NR		4-3/4	AL White	Store Front System		Lever Exterior Lever Interior	Surfmount ADA 180 Degree	By Glazing Contractor	By Glazing Contractor			Lock store room function

Designation		Door				Frame				Hardware				Notes				
Door #	Rm	Location	Size	Handing	Type	Rating	Material	Jamb	Material	Trim ext	Casing Int	Lockset	Closer	Door Stop	Threshold	Hinges	Weather Stripping	Notes
A1	A201	ENTRY	3-0x6-8x1-3/4	RH	6 panel Smooth Paint Grade	N/A	Fiberglass	6-9/16	Wood	Stucco Mold	2-1/4"	Schlage S-200 NEP 626 Interconnected	N/A	Base board Spring	Intagrat to Frame AL	Brushed Chrome		
A2	A206	Deck	6-0x6-8 x1-3/4	RH	3-0 Full Lite with 3-0 Full side lite	N/A	Fiberglass	6-9/16	Wood	Stucco Mold	2-1/4"	Schlage S-200 NEP 626 Interconnected	N/A	Base board Spring	Intagrat to Frame AL	Brushed Chrome		Glazing Every Star Low E Clear Class No Grids. Fixed Lite on Left From Exterior
A3	A208	Bath	2-10x6-8x1-3/8	RH	6 Panel HC	NA	Composite	4-9/16	Wood	2-1/4"	2-1/4"	Schlage S400 NEP 626	N/A	Base board Spring	Intagrat to Frame AL	Brushed Chrome		
A4	A204-AA	Closet	2-10x6-8x1-3/8	RH	6 Panel HC	NA	Composite	4-9/16	Wood	2-1/4"	2-1/4"	Schlage S400 NEP 626	N/A	Base board Spring	Intagrat to Frame AL	Brushed Chrome		
A5	A205	Bedroom	2-10x6-8x1-3/8	RH	6 Panel HC	NA	Composite	7-1/16	Wood	2-1/4"	2-1/4"	Schlage S400 NEP 626	N/A	Base board Spring	Intagrat to Frame AL	Brushed Chrome		
A6	A205	Bedroom	2-10x6-8x1-3/8	RH	6 Panel HC	NA	Composite	4-9/16	Wood	2-1/4"	2-1/4"	Schlage S400 NEP 626	N/A	Base board Spring	Intagrat to Frame AL	Brushed Chrome		
A7	A205B	Closet	2-10x6-8x1-3/8	RH	6 Panel HC	NA	Composite	4-9/16	Wood	2-1/4"	2-1/4"	Schlage S400 NEP 626	N/A	Base board Spring	Intagrat to Frame AL	Brushed Chrome		
A8	A205A	Bath	2-10x6-8x1-3/8	Pocket	6 Panel HC	NA	Composite	4-9/16	Wood	2-1/4"	2-1/4"	Schlage S400 NEP 626	N/A	Base board Spring	Intagrat to Frame AL	Brushed Chrome		
A9	A205B	Closet	2-10x6-8x1-3/8	LH	6 Panel HC	NA	Composite	7-1/8	Wood	2-1/4"	2-1/4"	Schlage S400 NEP 626	N/A	Base board Spring	Intagrat to Frame AL	Brushed Chrome		
A10	A207	Bedroom	2-10x6-8x1-3/8	LH	6 Panel HC	NA	Composite	4-9/16	Wood	2-1/4"	2-1/4"	Schlage S400 NEP 626	N/A	Base board Spring	Intagrat to Frame AL	Brushed Chrome		
A11	A207A	Closet	2-6x6-8x1-3/8	RH	6 Panel HC	NA	Composite	4-9/16	Wood	2-1/4"	2-1/4"	Schlage S400 NEP 626	N/A	Base board Spring	Intagrat to Frame AL	Brushed Chrome		
A12	A207B	Closet	2-6x6-8x1-3/8	RH	6 Panel HC	NA	Composite	4-9/16	Wood	2-1/4"	2-1/4"	Schlage S400 NEP 626	N/A	Base board Spring	Intagrat to Frame AL	Brushed Chrome		
A13	A207-A	Bath	2-8x6-8x1-3/8	RH	6 Panel HC	NA	Composite	4-9/16	Wood	2-1/4"	2-1/4"	Schlage S400 NEP 626	N/A	Base board Spring	Intagrat to Frame AL	Brushed Chrome		
A14	A208	Deck	2-8x6-8x1-3/4	RH	Full Lite	NA	Fiberglass	6-9/16	Wood	Stucco Mold	2-1/4"	Schlage S-200 NEP 626 Interconnected	N/A	Base board Spring	Intagrat to Frame AL	Brushed Chrome		Glazing Every Star Low E Clear Class No Grids

Designation		Door				Frame				Hardware				Notes				
Door #	Rm	Location	Size	Handing	Type	Rating	Material	Jamb	Material	Trim ext	Casing Int	Lockset	Closer	Door Stop	Threshold	Hinges	Weather Stripping	Notes
B1	B202	ENTRY	3-0x6-8x1-3/4	LH	6 panel Smooth Paint Grade	N/A	Fiberglass	6-9/16	Wood	Stucco Mold	2-1/4"	Schlage S-200 NEP 626 Interconnected	N/A	Base board Spring	Intagrat to Frame AL	Brushed Chrome		
B2	B206	Deck	6-0x6-8 x1-3/4	LH	3-0 Full Lite with 3-0 Full side lite	N/A	Fiberglass	6-9/16	Wood	Stucco Mold	2-1/4"	Schlage S-200 NEP 626 Interconnected	N/A	Base board Spring	Intagrat to Frame AL	Brushed Chrome		Glazing Every Star Low E Clear Class No Grids. Fixed Lite on Right From Exterior
B3	B205	Bedroom	2-6x6-8x1-3/8	LH	6 Panel HC	NA	Composite	7-1/8	Wood	2-1/4"	2-1/4"	Schlage S400 NEP 626	N/A	Base board Spring	Intagrat to Frame AL	Brushed Chrome		
B4	B204	Bath	2-4x6-8x1-3/8	Pocket	6 Panel HC	NA	Composite	4-9/16	Wood	2-1/4"	2-1/4"	Schlage S400 NEP 626	N/A	Base board Spring	Intagrat to Frame AL	Brushed Chrome		
B5	B205A	Closet	Par 4-6x6-8x1-3/8	Bi Pass	6 Panel HC	NA	Composite	Wood				Cup Pulls	N/A	NA	NA	NA	NA	Provide Bi Pass Hardware
B6	B207	Bedroom	2-6x6-8x1-3/8	RH	6 Panel HC	NA	Composite	6-9/16	Wood	2-1/4"	2-1/4"	Schlage S400 NEP 626	N/A	Base board Spring	Intagrat to Frame AL	Brushed Chrome		
B7	B209	Bath	2-4x6-8x1-3/8	RH	6 Panel HC	NA	Composite	4-9/16	Wood	2-1/4"	2-1/4"	Schlage S400 NEP 626	N/A	Base board Spring	Intagrat to Frame AL	Brushed Chrome		
B8	B205A	Closet	2-4x6-8x1-3/8	LH	6 Panel HC	NA	Composite	4-9/16	Wood	2-1/4"	2-1/4"	Schlage S400 NEP 626	N/A	Base board Spring	Intagrat to Frame AL	Brushed Chrome		
B9	B207C	Closet	Par 2-6x6-8x1-3/8	Bi Pass	6 Panel HC	NA	Composite	Wood				Cup Pulls	N/A	NA	NA	NA	NA	Provide Bi Pass Hardware
B10	A208	Deck	2-8x6-8x1-3/4	RH	Reverse Full Lite	NA	Fiberglass	6-9/16	Wood	Stucco Mold	2-1/4"	Schlage S-200 NEP 626 Interconnected	N/A	Base board Spring	Intagrat to Frame AL	Brushed Chrome		Glazing Every Star Low E Clear Class No Grids

Designation		Door				Frame				Hardware				Notes				
Door #	Rm	Location	Size	Handing	Type	Rating	Material	Jamb	Material	Trim ext	Casing Int	Lockset	Closer	Door Stop	Threshold	Hinges	Weather Stripping	Notes
C1	C201	ENTRY	3-0x6-8x1-3/4	LH	6 panel Smooth Paint Grade	N/A	Fiberglass	6-9/16	Wood	Stucco Mold	2-1/4"	Schlage S-200 NEP 626 Interconnected	N/A	Base board Spring	Intagrat to Frame AL	Brushed Chrome		
C2	C206	Bedroom	2-6x6-8x1-3/8	RH	6 Panel HC	NA	Composite	7-9/16	Wood	2-1/4"	2-1/4"	Schlage S400 NEP 626	N/A	Base board Spring	Intagrat to Frame AL	Brushed Chrome		
C3	C205A	Bath	2-4x6-8x1-3/8	Pocket	6 Panel HC	NA	Composite	4-9/16	Wood	2-1/4"	2-1/4"	Schlage S400 NEP 626	N/A	Base board Spring	Intagrat to Frame AL	Brushed Chrome		
C4	C206B	Closet	Par 2-6x6-8x1-3/8	Bi Pass	6 Panel HC	NA	Composite	Wood				Cup Pulls	N/A	NA	NA	NA	NA	Provide Bi Pass Hardware
C5	C201 under stair	Closet	2-6x6-8x1-3/8	RH	6 Panel HC	NA	Composite	6-9/16	Wood	2-1/4"	2-1/4"	Schlage S400 NEP 626	N/A	Base board Spring	Intagrat to Frame AL	Brushed Chrome		
C6	C206B	Closet	Par 2-6x6-8x1-3/8	Bi Pass	6 Panel HC	NA	Composite	Wood				Cup Pulls	N/A	NA	NA	NA	NA	Provide Bi Pass Hardware
C7	C204	Bedroom	2-6x6-8x1-3/8	RH	6 Panel HC	NA	Composite	4-9/16	Wood	2-1/4"	2-1/4"	Schlage S400 NEP 626	N/A	Base board Spring	Intagrat to Frame AL	Brushed Chrome		
C8	C204C	Bath	2-4x6-8x1-3/8	LH	6 Panel HC	NA	Composite	4-9/16	Wood	2-1/4"	2-1/4"	Schlage S400 NEP 626	N/A	Base board Spring	Intagrat to Frame AL	Brushed Chrome		
C9	C204B	Closet	2-6x6-8x1-3/8	LH	6 Panel HC	NA	Composite	4-9/16	Wood	2-1/4"	2-1/4"	Schlage S400 NEP 626	N/A	Base board Spring	Intagrat to Frame AL	Brushed Chrome		
C10	C208	Bedroom	2-6x6-8x1-3/8	LH	6 Panel HC	NA	Composite	4-9/16	Wood	2-1/4"	2-1/4"	Schlage S400 NEP 626	N/A	Base board Spring	Intagrat to Frame AL	Brushed Chrome		
C11	C205A	Bath	2-4x6-8x1-3/8	RH	6 Panel HC	NA	Composite	4-9/16	Wood	2-1/4"	2-1/4"	Schlage S400 NEP 626	N/A	Base board Spring	Intagrat to Frame AL	Brushed Chrome		
C12	C206B	Closet	Par 2-6x6-8x1-3/8	Bi Pass	6 Panel HC	NA	Composite	Wood				Cup Pulls	N/A	NA	NA	NA	NA	Provide Bi Pass Hardware
C13	A206	Deck	6-0x6-8 x1-3/4	LH	3-0 Full Lite with 3-0 Full side lite	N/A	Fiberglass	6-9/16	Wood	Stucco Mold	2-1/4"	Schlage S-200 NEP 626 Interconnected	N/A	Base board Spring	Intagrat to Frame AL	Brushed Chrome		Glazing Every Star Low E Clear Class No Grids. Fixed Lite on Right From Exterior

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01 BUILDING SECTION
SCALE: 1/4" = 1'-0"

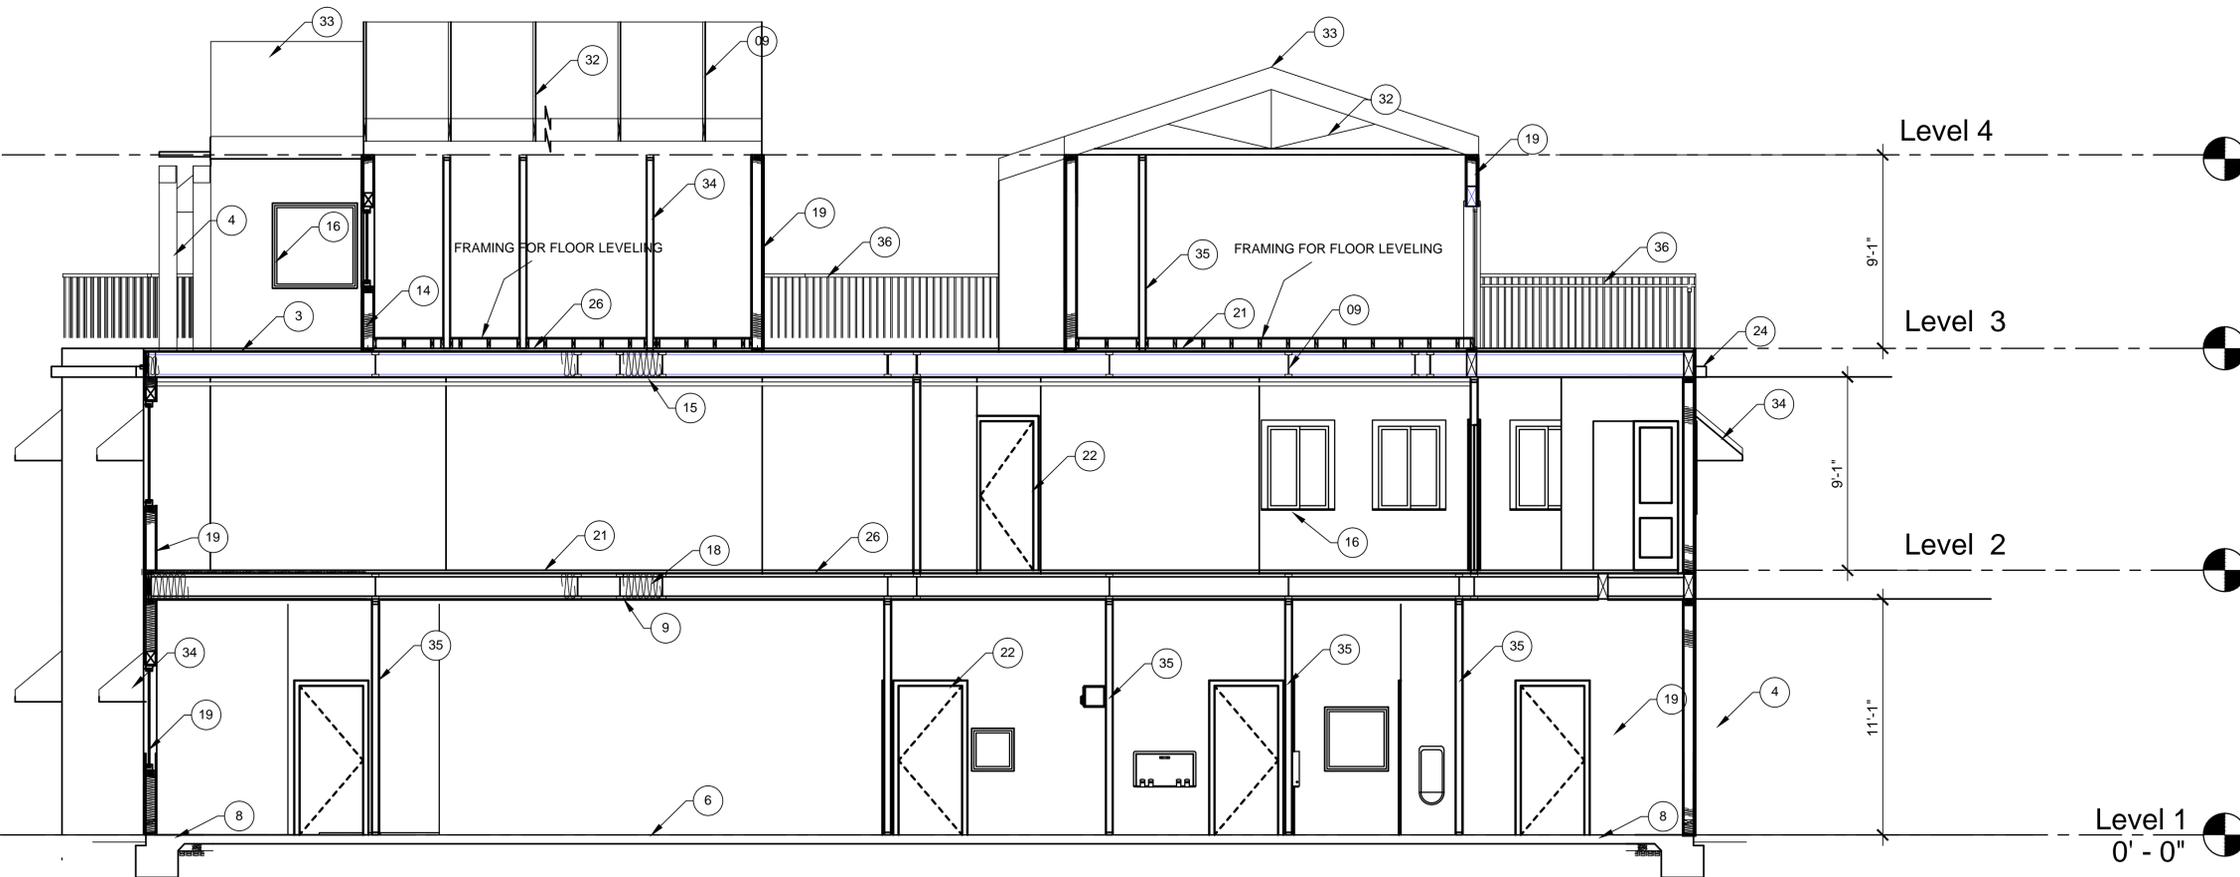GENERAL NOTES


- A. ALL DIMENSIONS ARE TO FACE OF STUD OR CENTERLINE OF PARTITION WALL, INTERIOR COLUMN/ WINDOW/ DOOR UNLESS OTHERWISE NOTED.
- B. DETAILS ARE KEYED AND NOTED "TYPICAL" ONLY ONCE ON THE PLANS WHEN THEY FIRST OCCUR, AND ARE REPRESENTATIVE OF SIMILAR CONDITIONS THROUGHOUT, UNLESS OTHERWISE NOTED.

KEYNOTES

- | | | | |
|----------------------------------------------------------------------------------------------------------------------------------------------------------------------------------------------------------------------------------------------------------------------------------------------------------------------------------------------------------------------------------------------------------------------------------------------------------------------------------------------------------------------------------------------------------------------------------------|-------------------------------------------------------------------------------------------------------------------------------------------------------------------------------------------------------------------------------------------------------------------------------------------------------------------------------------------------------------------------------------------------------------------------------------------------------------------------------------------------------------------------------------------------------------------------------|---------------------------------------------------------------------------------------------------------------------------------------------------------------------------------------------------------------------------------------------------------------------------------------------------------------------------------------------------------------------------------------------------------------------------------------------------------------------------------------------------------------------------|-----------------------------------------------------------------------------------------------------------------------------------------------------------------------------------------------------------------------------------------------------------------------------------------------------------------|
| <ul style="list-style-type: none"> 01 CEMENT PLASTER 0/2 LAYERS GRADE D BLDG. PAPER/0 1/2" PLYWD. 2 ALUMINUM STOREFRONT SYSTEM. SEE DET. SHEET AB.1 3 BUILT UP ROOFING 4 WD. TRELLIS. 5 ROOF CRICKET. 6 CONCRETE SLAB-ON-GRADE. SSD 7 STEEL BEAM. SSD 8 CONCRETE FOOTING. SSD 9 T.J.I. JOISTS @ 16 & 24" O.C. MAX. SSD. 10 5/8 THK. PLYWOOD SHEATING. SSD. 11 ALUMINUM WINDOW SYSTEM. 12 5/8" THK. PLYWD. SHEATING. 13 WD. HEADER. SEE STRUCTURAL DWGS. | <ul style="list-style-type: none"> 14 STEEL COLUMN. SSD. 15 5/8" THK. TYPE "X" GYPSUM BD. 16 VINYL WINDOW. 17 5/8" THK. GYPSUM BD. 18 ROOF INSULATION PER TITLE 24 19 2X6 WD. STUD FRAMING. SSD. 20 BATT INSULATION PER TITLE 24 21 FINISH FLOOR. SEE FINISH SCHEDULE A4.1 22 WOOD DOOR. SEE SHEET A9.1 23 ROOF DRAIN AND OVERFLOW. 24 EPS TRIM. 25 2" ALUMINUM REVEAL. 26 1-1/2" GYP.GRETE. SEE STRUCTURAL DWGS. 27 PLASTER WEEP SCREED. | <ul style="list-style-type: none"> 28 WD. BEAM. SEE SSD 29 MTL. GA. DOWNSPOUT 30 SHEET METAL CAP FLASHING /0 BUILT UP ROOFING 31 SLOPE ROOF TO DRAIN AT 1/4" PER FOOT 32 PREFABRICATED ROOF TRUSSES @ 24" O.C. 33 ASPHLT SHINGLES OVER 5/8" PLYWOOD (32/16) OVER 15 LB. FELT 34 WINDOW AWNINGS 35 2X4 WOOD STUDS WITH 5/8" TYPE X GYP. BD. EACH SIDE. 36 METAL RAILING 37 FLOOR FURRING FOR ROOF SLOPE AND FLOOR LEVELING | <ul style="list-style-type: none"> 38 RIPPED 2X @ 16" O.C. 39 2X4 SLEEPERS @ 24" O.C. 40 5/8" PLYWOOD WITH 100 @ 6" O.C. AT PANEL EDGES 41 3-10D TOES @ EACH SLEEPER 42 2X SOLID LEDGER WITH 6-16D EA STUD 43 2-16D EACH JOIST BELOW ROOF SHEATHING |
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LEGEND

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9/26/2011 - PLAN CHECK	G.O.

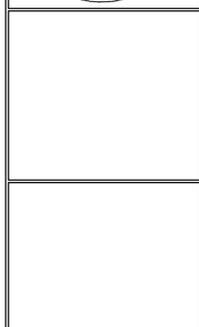


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PROJECT TITLE:
COMMUNITY CENTER
HARBOR PARK APARTMENTS
959 PORTER STREET, VALLEJO, CA 94560
DRAWING TITLE:
BUILDING SECTIONS

Date:	04/17/2012
Scale:	AS NOTED
Drawn:	STAFF
Checked:	RY
Job No.:	2011-09
Sheet:	A7.1
Of	Sheets

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01/18/2014 - BIDDING	LR.



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PROJECT TITLE:
COMMUNITY CENTER
 HARBOR PARK APARTMENTS
 959 PORTER STREET, VALLEJO, CA 94560
 DRAWING TITLE:
BUILDING SECTION

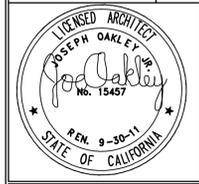Date:	04/17/2012
Scale:	AS NOTED
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Job No.:	2011-09
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Of	Sheets



01 BUILDING SECTION
SCALE: 1/4" = 1'-0"

GENERAL NOTES

- A. ALL DIMENSIONS ARE TO FACE OF STUD OR CENTERLINE OF PARTITION WALL, INTERIOR COLUMN/ WINDOW/ DOOR UNLESS OTHERWISE NOTED.
- B. DETAILS ARE KEYED AND NOTED "TYPICAL" ONLY ONCE ON THE PLANS WHEN THEY FIRST OCCUR, AND ARE REPRESENTATIVE OF SIMILAR CONDITIONS THROUGHOUT, UNLESS OTHERWISE NOTED.



KEYNOTES

- | | | | |
|----------------------------------------------------------------|-------------------------------------------|--------------------------------------------------------------------|---------------------------------------------------|
| 01 CEMENT PLASTER 0/2 LAYERS GRADE D BLDG. PAPER/0 1/2" PLYWD. | 14 STEEL COLUMN. SSD. | 28 WD. BEAM. SEE SSD | 38 RIPPED 2X @ 16" O.C. |
| 2 ALUMINUM STOREFRONT SYSTEM. SEE DET. SHEET A8.1 | 15 5/8" THK. TYPE " X" GYPSUM BD. | 29 MTL. GA. DOWNSPOUT | 39 2X4 SLEEPERS @ 24" O.C. |
| 3 BUILT UP ROOFING | 16 VINYL WINDOW. | 30 SHEET METAL CAP FLASHING /O TPO ROOFING O/ 1 LAYER OF BITUTHENE | 40 5/8" PLYWOOD WITH 100 @ 6" O.C. AT PANEL EDGES |
| 4 WD. TRELLIS. | 17 5/8" THK. GYPSUM BD. | 31 SLOPE ROOF DRAIN 1/2"=1'-0" | 41 3-100 TOES @ EACH SLEEPER |
| 5 ROOF CRICKET. | 18 ROOF INSULATION PER TITLE 24 | 32 PREFABRICATED ROOF TRUSSES @ 24" O.C. | 42 2X SOLID LEDGER WITH 6-160 EA STUD |
| 6 CONCRETE SLAB-ON-GRADE. SSD | 19 2X6 WD. STUD FRAMING. SSD. | 33 ASPHLT SHINGLES OVER 5/8" PLYWOOD (32/16) OVER 15 LB. FELT | 43 2-160 EACH JOIST BELOW ROOF SHEATHING |
| 7 STEEL BEAM. SSD | 20 BATT INSULATION PER TITLE 24 | 34 WINDOW AWNINGS | |
| 8 CONCRETE FOOTING, SSD | 21 FINISH FLOOR. SEE FINISH SCHEDULE A4.1 | 35 2X4 WOOD STUDS WITH 5/8" TYPE X GYP. BD. EACH SIDE. | |
| 9 T.J.I. JOISTS @ 16 & 24" O.C. MAX. SSD. | 22 WOOD DOOR. SEE SHEET A9.1 | 36 METAL RAILING | |
| 10 3/4 THK. PLYWOOD SHEATING. SSD. | 23 ROOF DRAIN AND OVERFLOW. | 37 FLOOR FURRING FOR ROOF SLOPE AND FLOOR LEVELING | |
| 11 ALUMINUM WINDOW SYSTEM. | 24 EPS TRIM. | | |
| 12 3/4" THK. PLYWD. SHEATING. | 25 2" ALUMINUM REVEAL. | | |
| 13 WD. HEADER. SEE STRUCTURAL DWGS. | 26 1-1/2" GYP.CRETE. SEE STRUCTURAL DWGS. | | |
| | 27 PLASTER WEEP SCREED. | | |

LEGEND


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DOOR MARK	DOOR										FRAME			HARDWARE GROUP	SIGNAGE	FIRE RATING	REMARKS
	TYPE	NOMINAL SIZE			MTL	FIN	GLASS	LOUVER		CORE	DETAILS						
		WIDTH PER LEAF	HT	THK				W	HT		JAMB	HEAD	SILL				
UNITS A, B, C																	
1	1	3'-0"	6'-8"	1 3/4"	FG	PAINT		-	-	SC	11/9.2	5/9.2	21/9.2	1		3" UNDERCUT AT DOORS AT CARPET FINISH	
2	2	3'-0"	6'-8"		WOOD	PAINT	TEMP										
3	3	2'-4"	6'-8"		FG OR	PAINT				HC/SS	12/9.2	6/9.2					
					MDF												
4	4	2'-6"	6'-8"	1 3/4"	FG OR	PAINT		-	-	HC/SS	12/9.2	6/9.2					
					MDF												
5	5	2'-10"	6'-8"		FG OR	PAINT				HC/SS	12/9.2	6/9.2					
					MDF												
6	6	2'-10"	6'-8"	1 3/4"	FG OR	PAINT				HC/SS	12/9.2	6/9.2					
					MDF												
7	5	2'-10"	6'-8"			PAINT				HC/SS	12/9.2	6/9.2					
					MDF												
8	5	2'-10"	6'-8"		FG OR	PAINT				HC/SS	12/9.2	6/9.2					
					MDF												

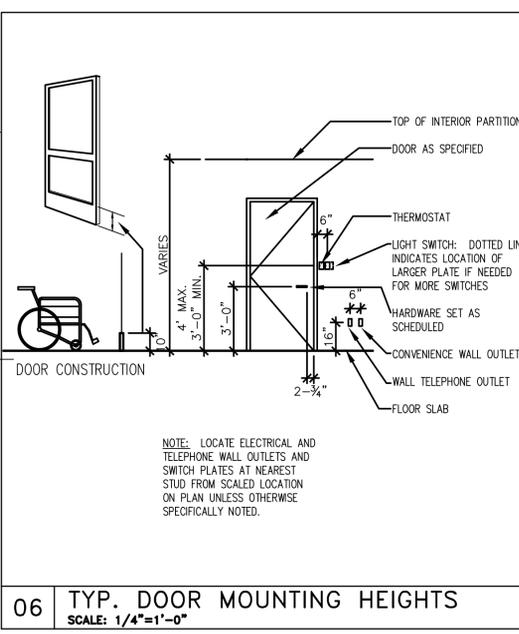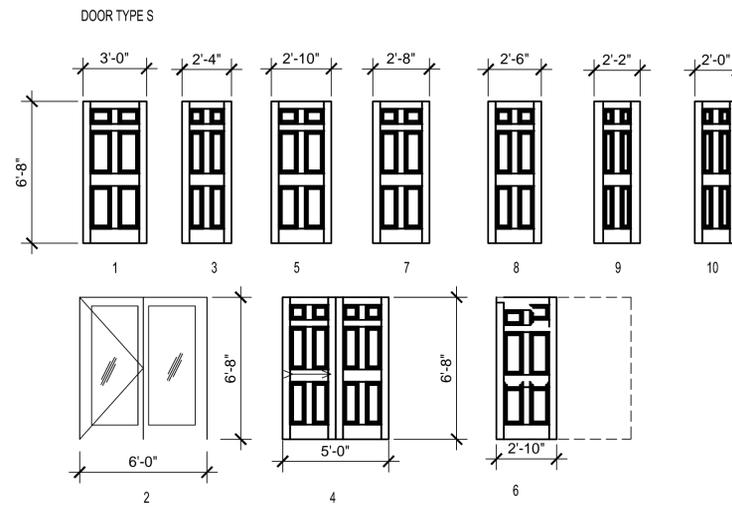

06 TYP. DOOR MOUNTING HEIGHTS
SCALE: 1/4"=1'-0"

01 DOOR SCHEDULE

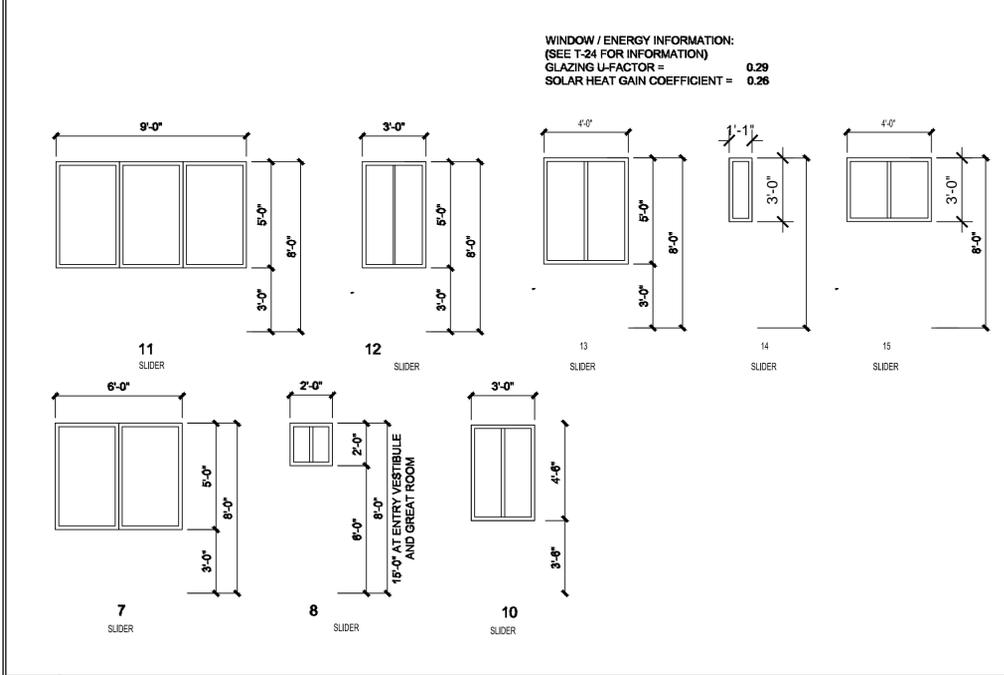

04 WINDOW TYPE

02 FRAME AND DOOR TYPES

- A THRESHOLD HEIGHT SHALL NOT EXCEED 1/2" MAX. (ABOVE FLOOR AND LANDING ON BOTH SIDES) AT BUILDING ENTRANCE AND ALL DOORS, SEE DET. 21/A9.2
- B FOR DOOR FINISHES REFER TO SPECIFICATION.
- C SEE 6/A9.1 FOR TYP. MOUNTING HEIGHTS FOR DOOR HARDWARE.
- D ALL HARDWARE AT ACCESSIBLE DOORS SHALL COMPLY W/ CBC, CHAPTER 10 AND TITLE 24 (1,2).
- E ALL DOOR FRAMES SHALL BE INSTALLED WITH 3 DOOR SILENCERS U.O.N.
- F EXIT DOORS SHALL BE OPERABLE FROM THE INSIDE WITHOUT THE USE OF KEY OR SPECIAL EFFORT PER LOCAL CODE. LEVER TYPE HARDWARE SHALL BE USED THROUGHOUT - SCHLAGE RHODES LEVER, U.O.N. AND WHICH WILL COMPLY WITH CBC 1003.3.1.8
- G MAXIMUM EFFORT TO OPERATE DOORS SHALL NOT EXCEED 5 POUNDS FOR EXTERIOR DOORS AND 5 POUNDS FOR INTERIOR DOORS. WHEN FIRE DOORS ARE REQUIRED, THE MAXIMUM EFFORT TO OPERATE DOOR MAY BE INCREASED NOT TO EXCEED 15 POUNDS.
- H WHILE THE HARDWARE SCHEDULE IS INTENDED TO COVER ALL DOORS OF THE BUILDING, AND TO ESTABLISH A TYPE AND STANDARD OF QUALITY, IT SHALL BE THE SPECIFIC DUTY AND RESPONSIBILITY OF THE FINISH HARDWARE SUPPLIER TO EXAMINE THE PLANS AND SPECIFICATIONS, AND FURNISH PROPER HARDWARE FOR ALL OPENINGS WHETHER LISTED OR NOT.

03 GENERAL NOTES

- ABBREVIATIONS**
- I IF THERE ARE OMISSIONS IN HARDWARE GROUPS, THEY SHALL BE CALLED TO THE ATTENTION OF THE ARCHITECT/ENGINEER FOR INSTRUCTIONS.
 - J ALL DOORS SWINGING OVER CARPETED AREAS SHALL BE UNDERCUT TO CLEAR FINISHED FLOOR.
 - K PROVIDE INTERNATIONAL SYMBOL OF ACCESSIBILITY AT THE MAIN ENTRANCE. (MOUNT @ 60" A.F.F.) PER 2007 CBC 1117B.5.
 - L X
 - M HARDWARE GROUP: REFER TO SPECIFICATION FOR DESCRIPTION OF HARDWARE CONTAINED WITHIN GROUPING.
 - N CONTRACTOR TO VERIFY ALL ROUGH OPENING DIMENSIONS AS REQUIRED TO MATCH DOOR SIZE SHOWN.
 - P FOR DOOR AND FRAME DETAILS REFER TO SHEET AX.1
 - Q ROOM NUMBERS AND BUILDING SIGNAGE TO BE VANDAL RESISTANT.
 - R ALL INTERIOR DOORS TO BE STAVE CORE HOOD DOORS.
 - S PROVIDE WEATHER STRIPPING AT ALL EXTERIOR DOORS.
- WD WOOD
MTL METAL
DH DOOR HEIGHT, SEE SCHEDULE
PT PAINT
LG LAMINATED GLASS
HM HOLLOW METAL DOOR
ANOD ANODIZED
PF PREFINISHED
FB FIBERGLASS
MDF MOLDED WOOD COPOSITE
PF PREFINISHED
SC SOLID CORE
HC/SS HOLLOW CORE, SOLID STILE

05 WINDOW SCHED. SYMBOL


WINDOW MARK	WINDOW TYPE	SIZE		FRAME TYPE	MATERIAL	GLAZING				DETAILS				RATING	REMARKS
		WIDTH	HEIGHT			SINGLE	DOUBLE	TEMP	LOW E	HEAD	JAMB	SILL	MULL		
G	7	6'-0"	5'-0"		VINYL	X	X			10/CD1	10/CD1	22/CD1			
M	11	9'-0"	5'-0"		VINYL	X	X	X		10/CD1	10/CD1	22/CD1			
N	12	3'-0"	5'-0"		VINYL	X	X	X		10/CD1	10/CD1	22/CD1			
O	7	6'-0"	5'-0"		VINYL	X	X			10/CD1	10/CD1	16/CD1			
P	7	3'-0"	8'-0"		ALUM	X	X			10/CD1	10/CD1	16/CD1			
Q	13	4'-0"	5'-0"		VINYL	X	X			10/CD1	10/CD1	22/CD1			
R	14	1'-0"	5'-0"		VINYL	X	X			10/CD1	10/CD1	22/CD1			
S	15	4'-0"	3'-0"		VINYL	X	X			10/CD1	10/CD1	22/CD1			

05 WINDOW SCHED. SYMBOL

WINDOW NOTES:

- INSTALL DEVICES WHICH ALLOW WINDOWS TO BE LOCKED FROM THE INTERIOR
 - ALL WINDOWS SHALL BE DUAL GLAZED WITH WEATHER-STRIPPED DOOR INFILTRATION FRAMES MEETING ANSI AIR INFILTRATION STANDARDS.
 - SAFETY GLAZING SHALL BE INSTALLED IN THE FOLLOWING LOCATIONS: PER (2010 CBC 2406.3)
 - 1. GLAZING IN SWINGING DOORS EXCEPT JALOUSIES
 - 2. GLAZING IN FIXED AND SLIDING PANELS OF SLIDING AND BI-FOLD CLOSET DOOR ASSEMBLIES
 - 3. GLAZING IN STORM DOORS
 - 4. GLAZING IN UNFRAMED SWINGING DOORS
 - 5. GLAZING IN DOORS AND ENCLOSURES FOR HOT TUBS, WHIRLPOOLS, SAUNAS, STEAM ROOMS, BATHTUBS AND SHOWERS. GLAZING IN ANY PORTION OF A BUILDING WALL ENCLOSING THESE COMPARTMENTS WHERE THE BOTTOM EXPOSED EDGE OF GLAZING IS LESS THAN 60" ABOVE A STANDING SURFACE.
 - 6. GLAZING IN INDIVIDUAL FIXED OR OPERABLE PANEL ADJACENT TO A DOOR WHERE THE NEAREST EXPOSED EDGE OF THE GLAZING IS WITHIN A 24" ARC OF EITHER VERTICAL EDGE OF THE DOOR IN A CLOSED POSITION AND WHERE THE BOTTOM EXPOSED EDGE OF GLAZING IS LESS THAN 60" ABOVE THE WALKING SURFACE.
- EXCEPTION:
AN INTERVENING WALL BETWEEN DOOR & GLAZING

REVISIONS	BY
9/26/2011 - PLAN CHECK	G.O.

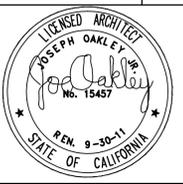

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PROJECT TITLE:
COMMUNITY CENTER
 HARBOR PARK APARTMENTS
 969 PORTER STREET, VALLEJO, CA 94560
 DRAWING TITLE:
DOOR & WINDOW SCHEDULE

Date: 04/17/2012
 Scale: AS NOTED
 Drawn: STAFF
 Checked: RY
 Job No.: 2011-09
 Sheet:

A9.1
 of Sheets

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9/26/2011 - PLAN CHECK	G.O.




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PROJECT TITLE:
COMMUNITY CENTER
 HARBOR PARK APARTMENTS
 9069 PORTER STREET, VALLEJO, CA 94580
 DRAWING TITLE:
ARCHITECTURAL DETAILS


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 Drawn: STAFF
 Checked: RY
 Job No.: 2011-09
 Sheet:

A9.2


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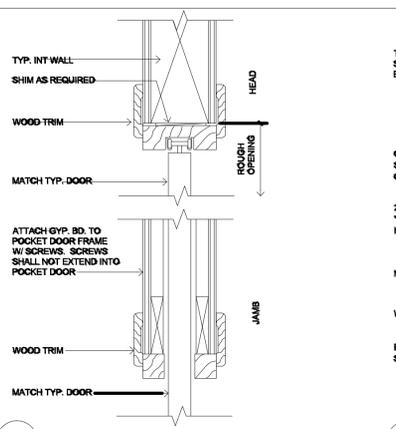
1 WINDOW JAMB
SCALE 3" = 1'-0"

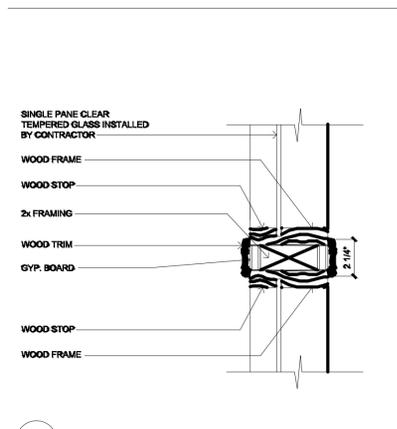


2 SILL / HEAD DETAIL
SCALE 3" = 1'-0"

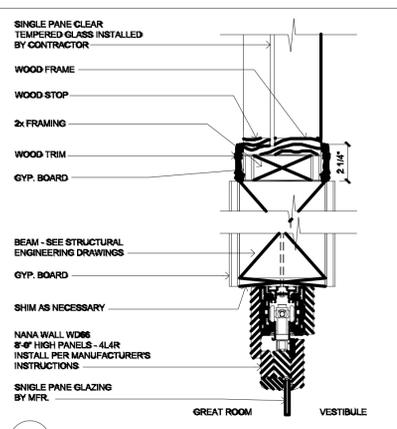


3 WINDOW SILL
SCALE 3" = 1'-0"

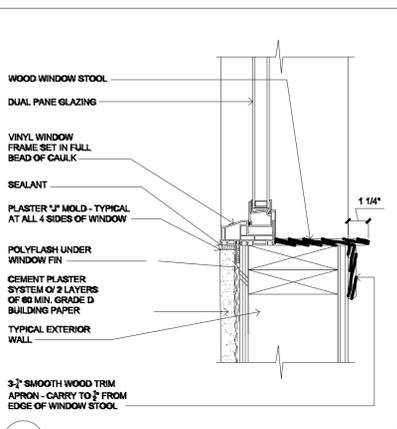


4 POCKET DOOR
SCALE 3" = 1'-0"

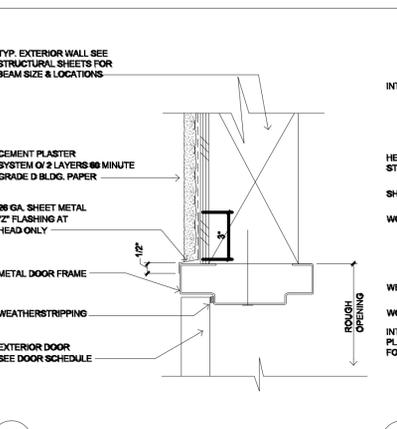


5 DOOR HEAD
SCALE 3" = 1'-0"

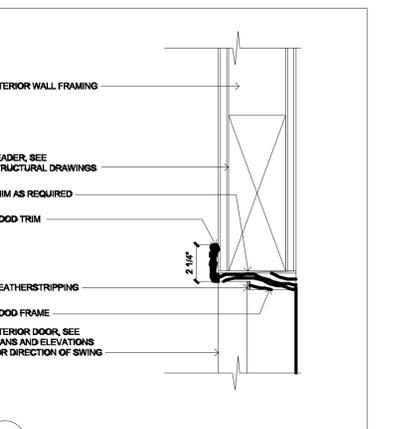


6 DOOR HEAD / JAMB SIMILAR
SCALE 3" = 1'-0"

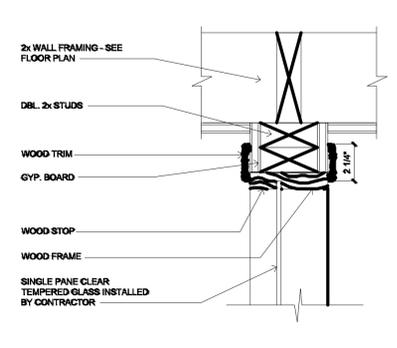


7 WINDOW JAMB / HEAD SIMILAR
SCALE 3" = 1'-0"

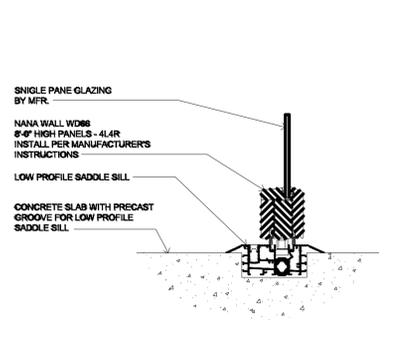


8 SILL DETAIL
SCALE 3" = 1'-0"

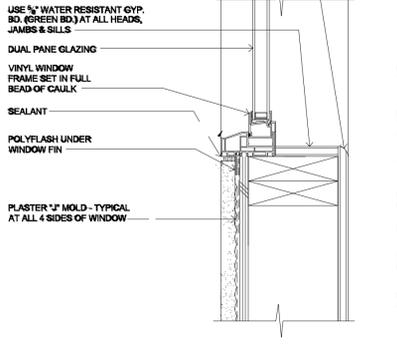


9 WINDOW SILL
SCALE 3" = 1'-0"

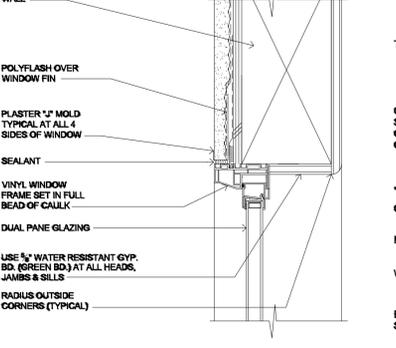


10 WINDOW HEAD / JAMB SIMILAR
SCALE 3" = 1'-0"

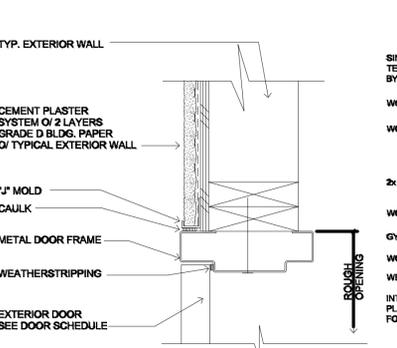


11 DOOR JAMB
SCALE 3" = 1'-0"

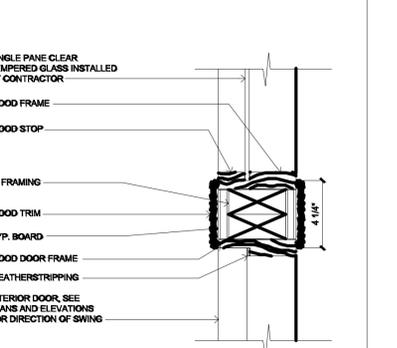


12 DOOR / WINDOW JAMB
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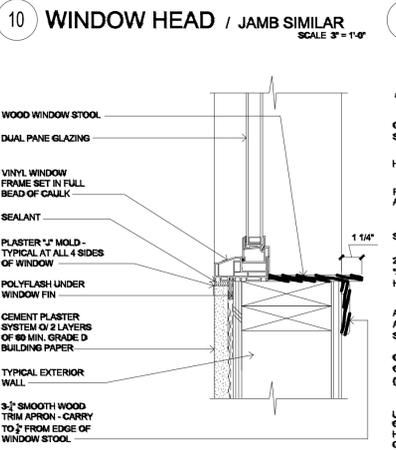
13 CONCRETE PARKING STOP
SCALE 1/2" = 1'-0"

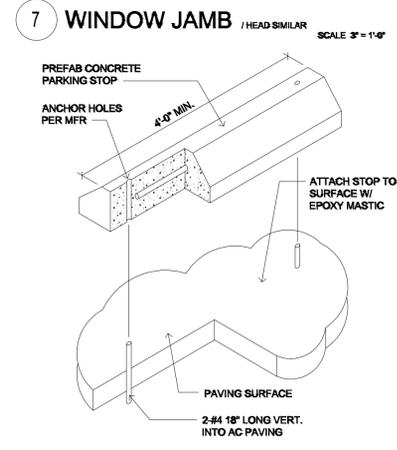


14 SITE STAIR SECTION
SCALE 1/2" = 1'-0"

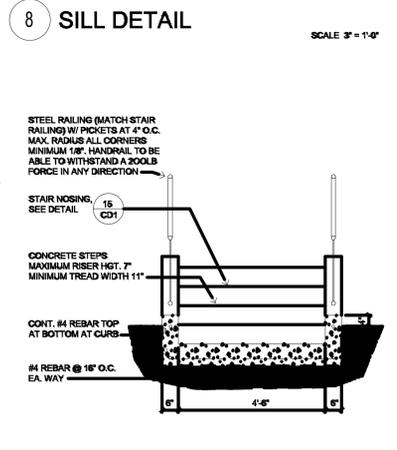


15 EXT. STAIR NOSING
SCALE 6" = 1'-0"

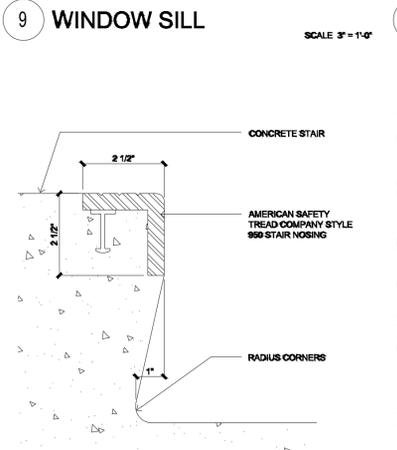


16 WINDOW SILL
SCALE 3" = 1'-0"

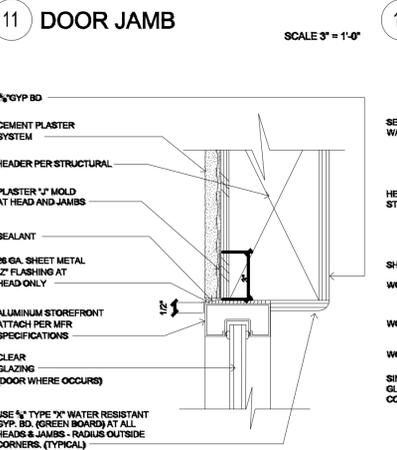


17 STOREFRONT HEAD
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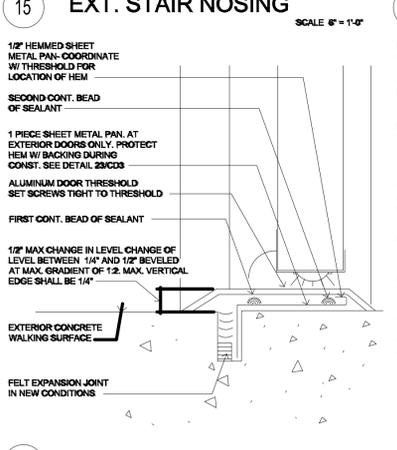
18 WINDOW HEAD / JAMB SIMILAR
SCALE 3" = 1'-0"

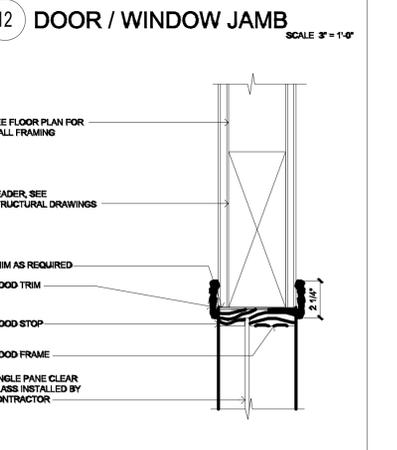


19 SITE STAIR SECTION
SCALE 1/2" = 1'-0"

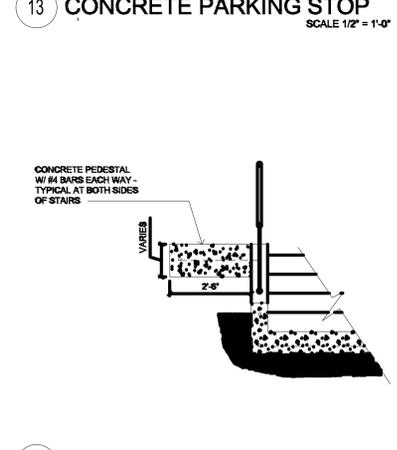


20 SITE STAIR
SCALE 1/2" = 1'-0"

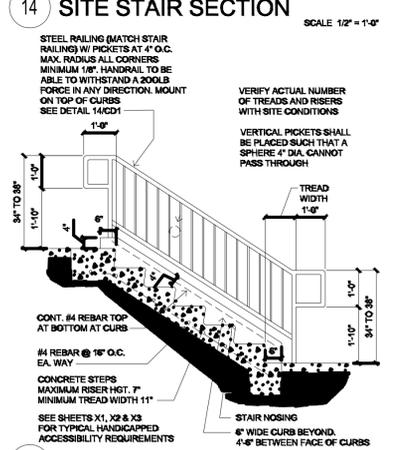


21 DOOR THRESHOLD
SCALE 6" = 1'-0"

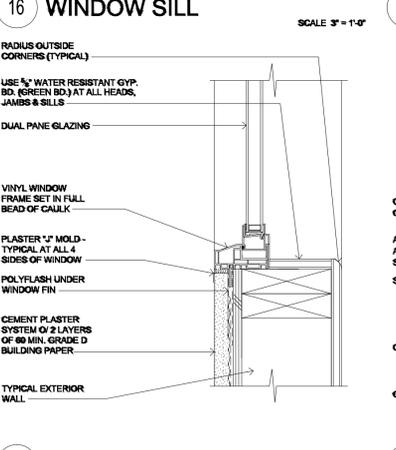

22 WINDOW SILL
SCALE 3" = 1'-0"

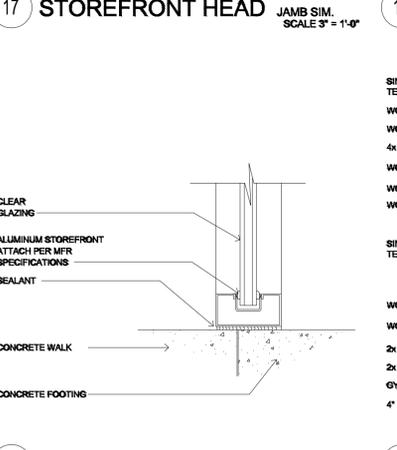

23 STOREFRONT SILL
SCALE 3" = 1'-0"

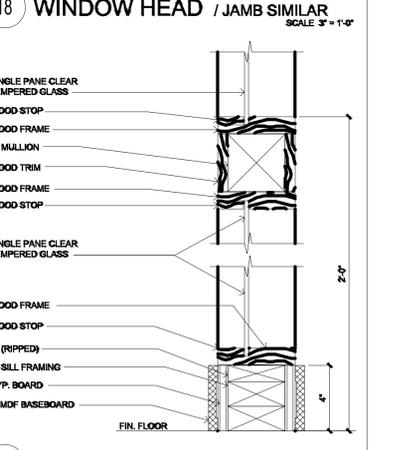

27 WINDOW SILL
SCALE 3" = 1'-0"

REVISIONS	BY
9/26/2011 - PLAN CHECK	G.O.




JOSEPH OAKLEY
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 OAKLEY, CA 94621
 P. 925.262.6228
 F. 925.262.6043

PROJECT TITLE:
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 HARBOR PARK APARTMENTS
 9069 PORTER STREET, VALLEJO, CA 94580
 DRAWING TITLE:
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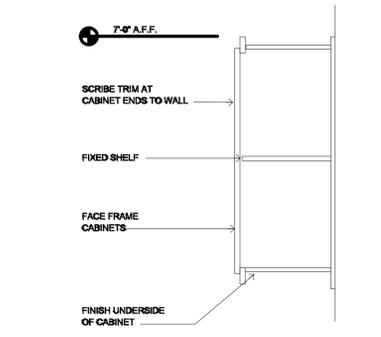
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 Scale: AS NOTED
 Drawn: STAFF
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 Job No.: 2011-09
 Sheet:

A9.3


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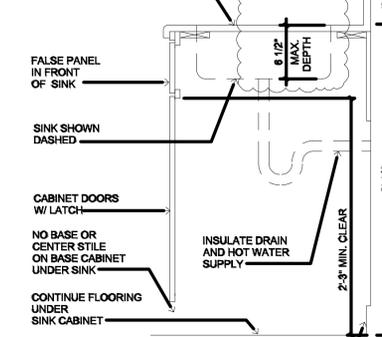
1 ATTIC ACCESS HATCH
SCALE 3\"/>

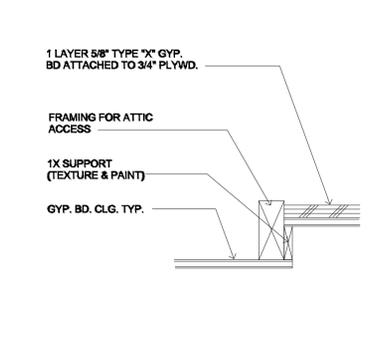


2 UPPER CABINET
SCALE 1 1/2\"/>




3 CABINET AT WALL
FULL SCALE

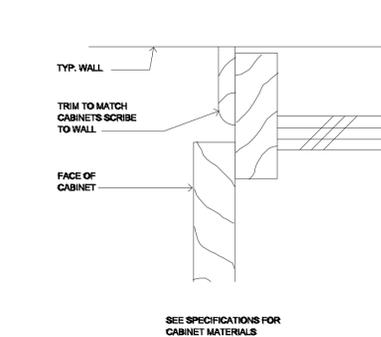


4 BASE CABINET
WHEEL CHAIR ACCESSIBLE
SCALE 1 1/2\"/>

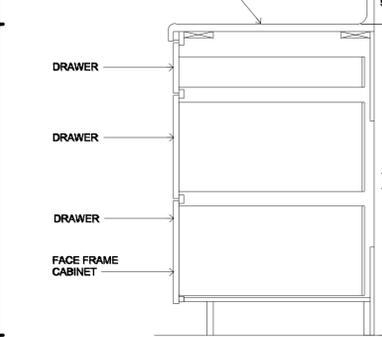

5 BASE CABINET
SCALE 1 1/2\"/>

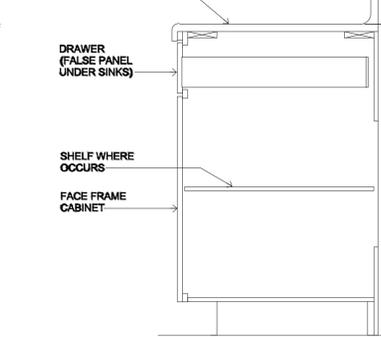


6 BASE CABINET
SCALE 1 1/2\"/>

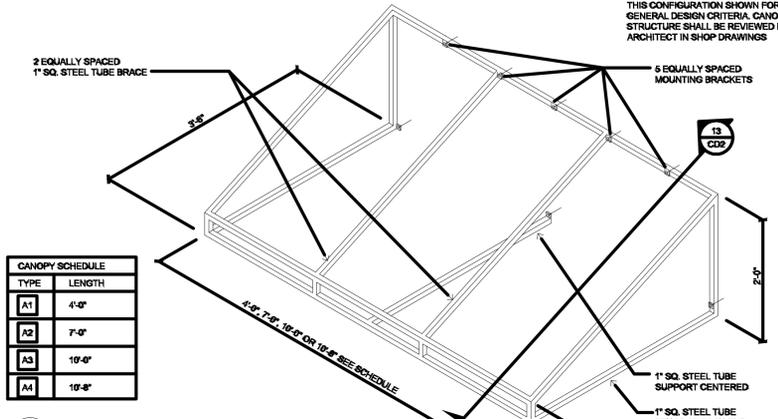


7 CANOPY
NO SCALE


CANOPY SCHEDULE	
TYPE	LENGTH
A1	4'-0"
A2	7'-0"
A3	10'-0"
A4	10'-0"

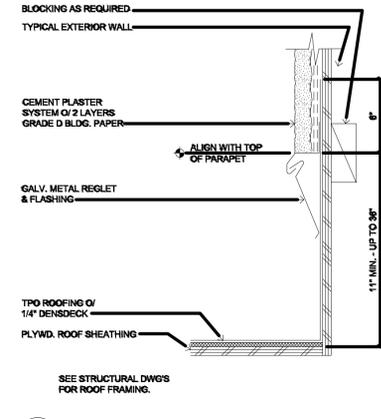


9 ROOF @ WALL
SCALE 3\"/>

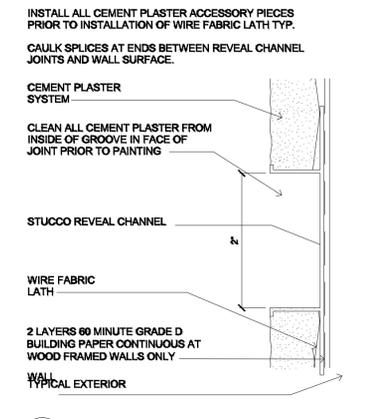


10 REVEAL
FULL SCALE

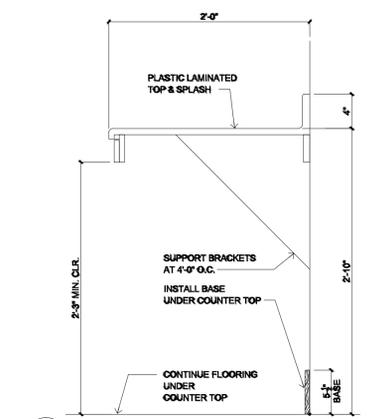


11 WORK COUNTER
SCALE 1 1/2\"/>

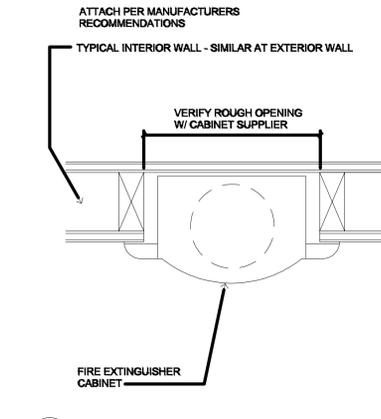


12 FIRE EXTINGUISHER CABINET
SCALE 3\"/>

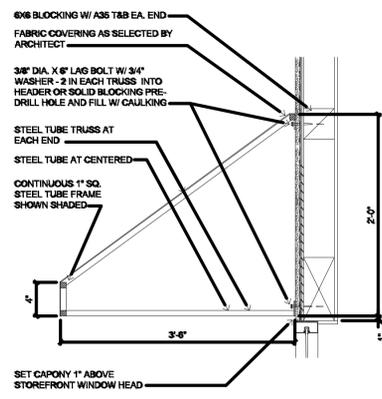


13 CANOPY SECTION I
SCALE 1\"/>

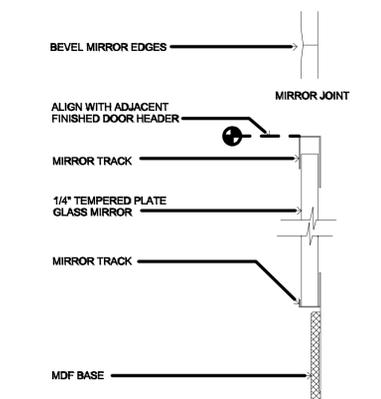


14 EXERCISE MIRROR
FULL SCALE

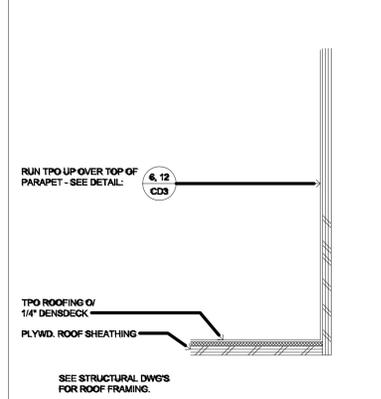


15 ROOF @ PARAPET
SCALE 3\"/>

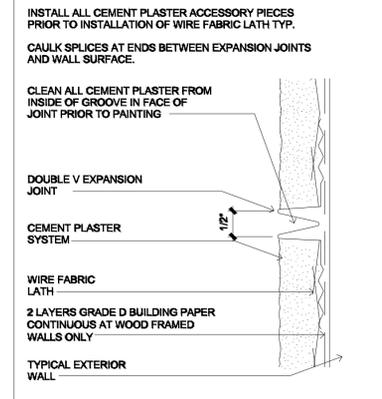


16 EXPANSION JOINT
FULL SCALE

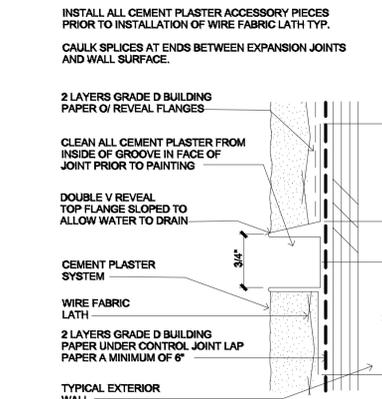


17 HORIZONTAL CONTROL JOINT
FULL SCALE

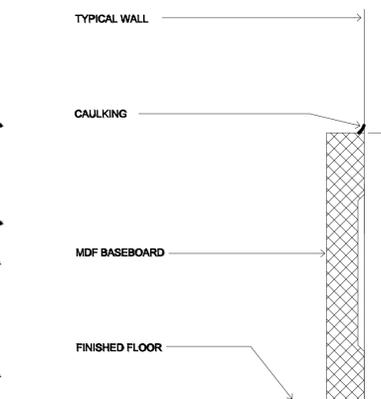


18 BASEBOARD
FULL SCALE

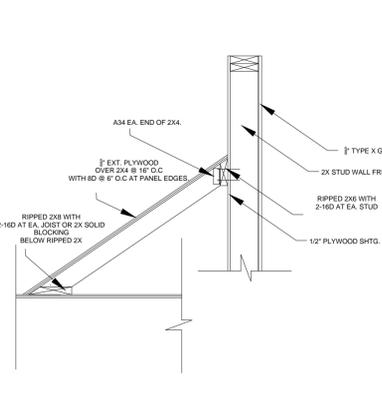


19 TYPICAL CRICKET DETAIL
NO SCALE

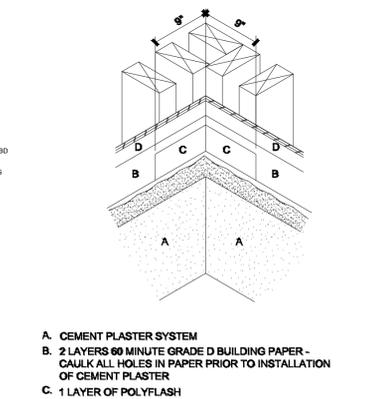


20 INSIDE CORNER
NO SCALE

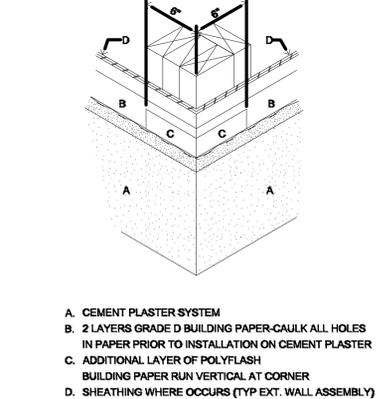


21 OUTSIDE CORNER
NO SCALE

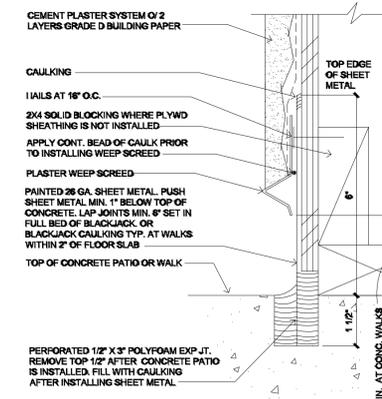

22 PATIO / WALK TO WALL
SCALE 6\"/>

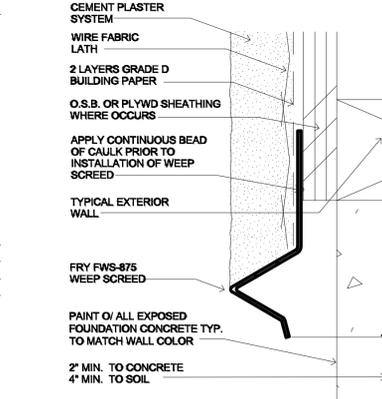





23 DRIP SCREED
FULL SCALE

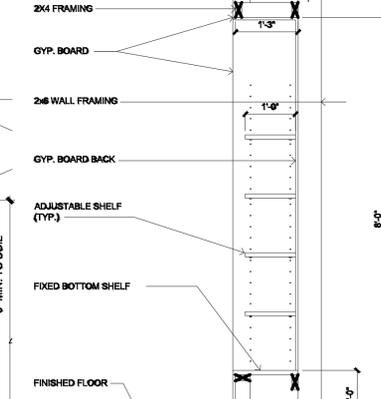




24 BUILT-IN SHELVING
SCALE 3/4\"/>

Jan 20, 2014 - 6:08am \\Server\server drive d\Year 2011_Jobs\2011-09-3 - Community Blog\REVISED DRAWINGS FOR NEGOTIATED CONTRACT WITH WE LYONS\ARCHITECTRA9.3.dwg

Jun 20, 2014 - 7:02am Z:\Year 2011\Jobs\2011-09-3 - Community Bldg\REVISED DRAWINGS FOR NEGOTIATED CONTRACT WITH VE LYONS\ARCHITECTURE\A9.41.dwg

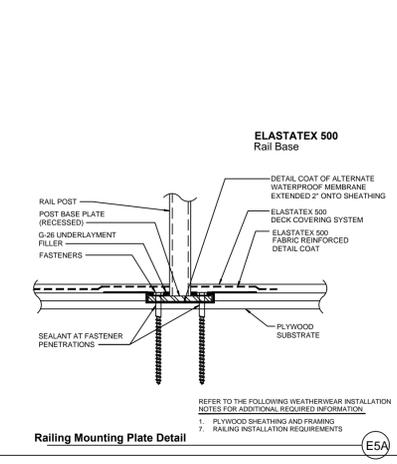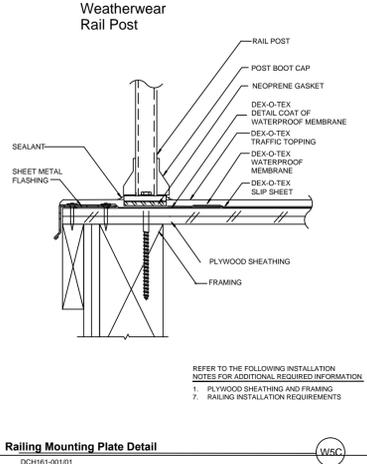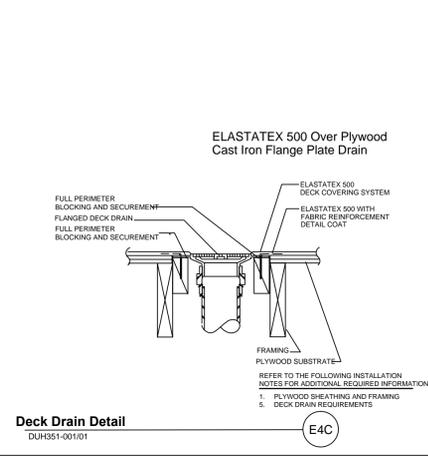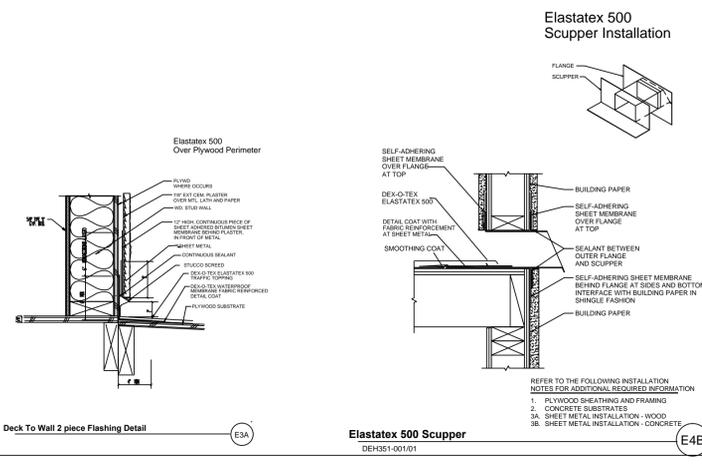

TYPICAL ARCHITECTURAL DETAILS AT DEXOTEX WALK DECK FINISH

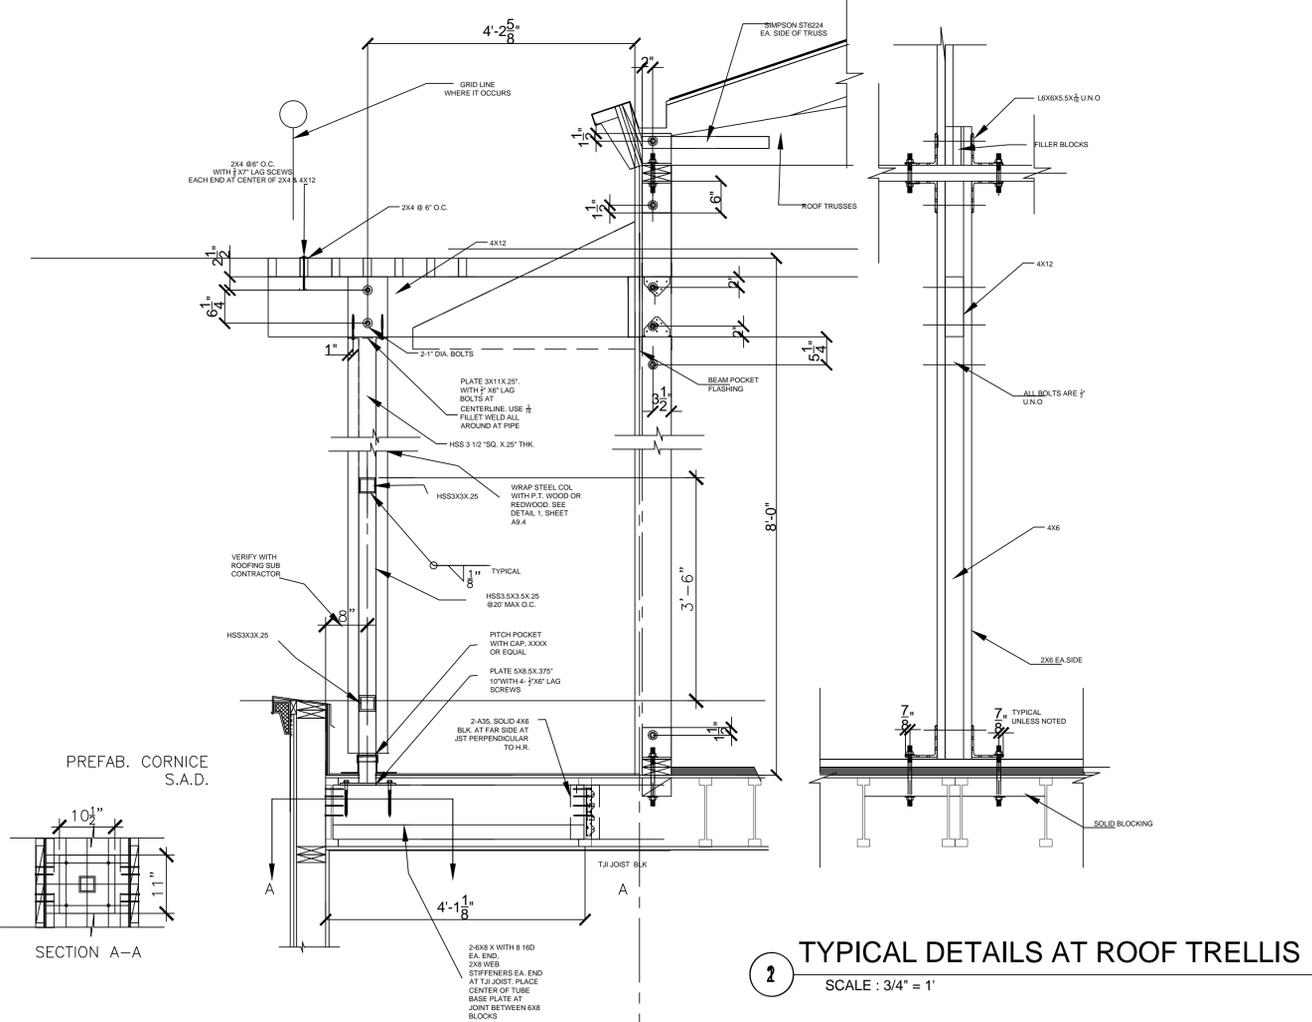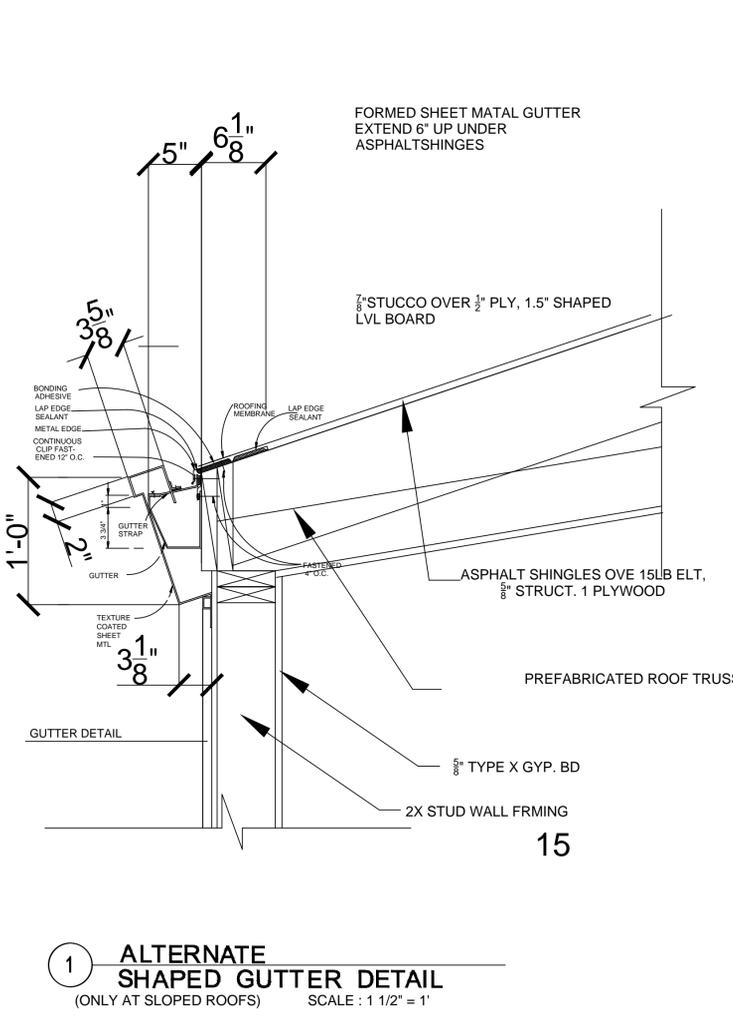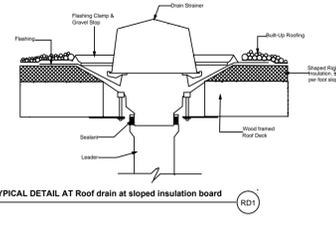

REVISIONS	BY
9/26/2011 - PLAN CHECK	G.O.




OAKLEY & OAKLEY
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 7700 EDgewater Drive, Ste. 615
 Irvine, CA 92618
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 FAX: 949.262.6043


COMMUNITY CENTER
 HARBOR PARK APARTMENTS
 969 PORTER STREET, VALLEJO, CA 94560
 PROJECT TITLE:
 DRAWING TITLE:
ARCHITECTURAL DETAILS

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Scale:	AS NOTED
Drawn:	STAFF
Checked:	RY
Job No.:	2011-09
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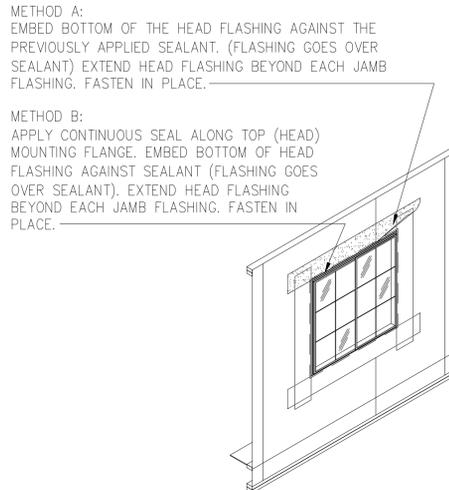
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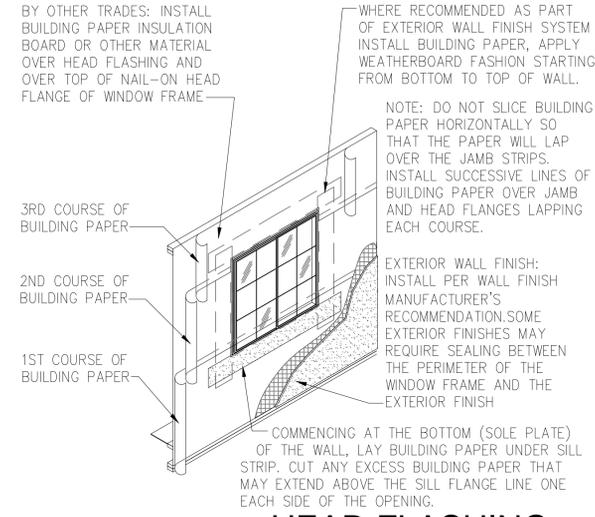
JAMB FLASHING 21
N.T.S.

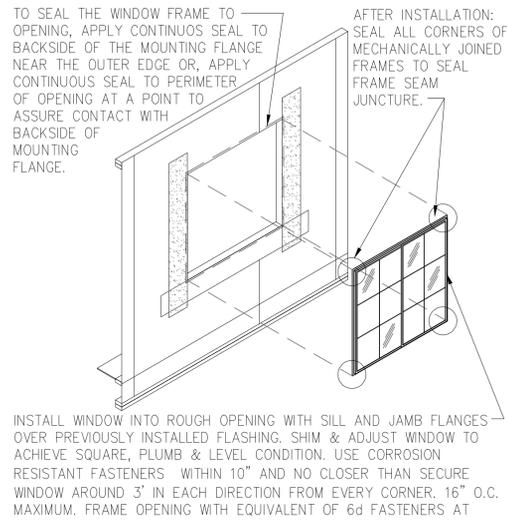


JAMB FLASH. 22
N.T.S.

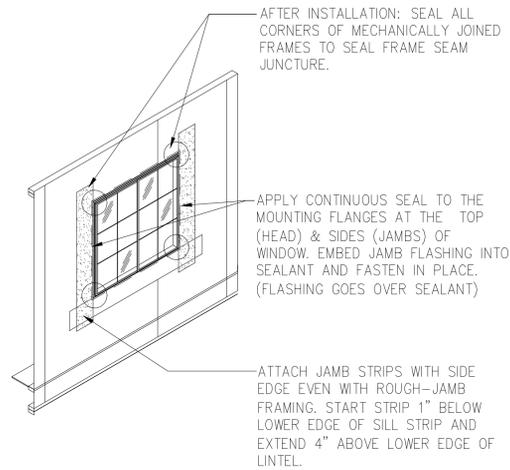


PRIM. WEATHER BARRIER 23
N.T.S.



HEAD FLASHING 24
N.T.S.

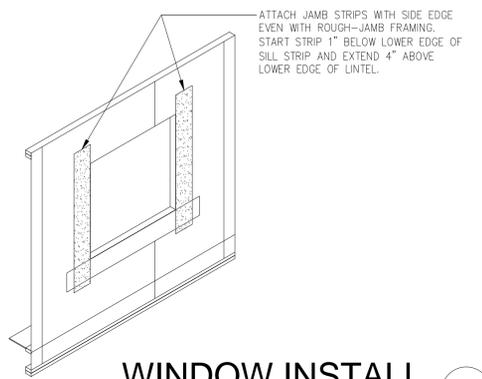

WINDOW INSTALL. 20
N.T.S.

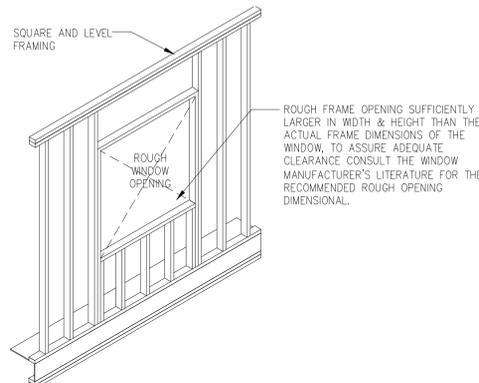


WINDOW FLASHING NOTES:


LINE-WIRE, WHEN USED AS BACKING TO SUPPORT BUILDING PAPER BENEATH WIRE LATH (NETTING) FOR PORTLAND CEMENT PLASTER (STUCCO) SHALL BE INSTALLED AS FOLLOWS:

1. WIRE GAUGE, SPACING AND ATTACHMENT SHALL BE IN ACCORDANCE WITH THE REQUIREMENTS OF THE SPECIFICATIONS
2. PERIPHERAL FLASHING AT ALL EDGES OF WALL OPENINGS MUST COVER THE WIRE BACKING.
3. NO ATTACHMENT DEVICES NOR THE WIRE BACKING SHALL COVER OR PENETRATE THE FLASHING MATERIAL.

WINDOW FLASHING NOTES 25
N.T.S.

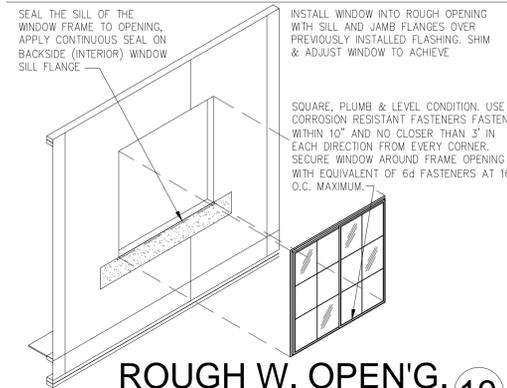

ROUGH W. OPEN'G. 19
N.T.S.

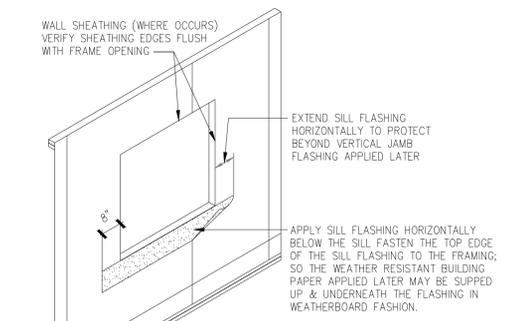

SILL FLASHING 18
N.T.S.

REVISIONS	BY
9/26/2011 - PLAN CHECK	G.G.



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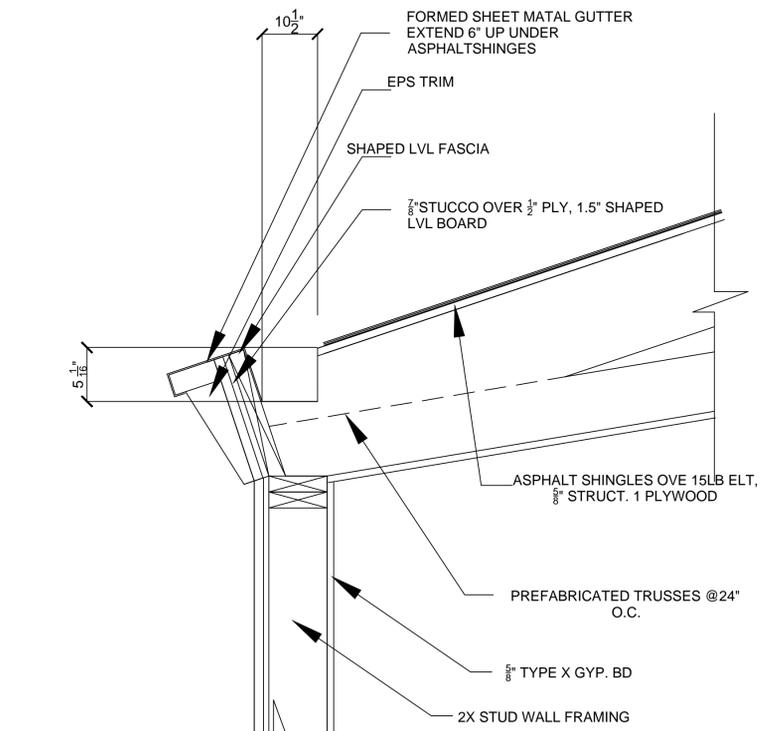
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COMMUNITY CENTER
HARBOR PARK APARTMENTS
969 PORTER STREET, VALLEJO, CA 94560

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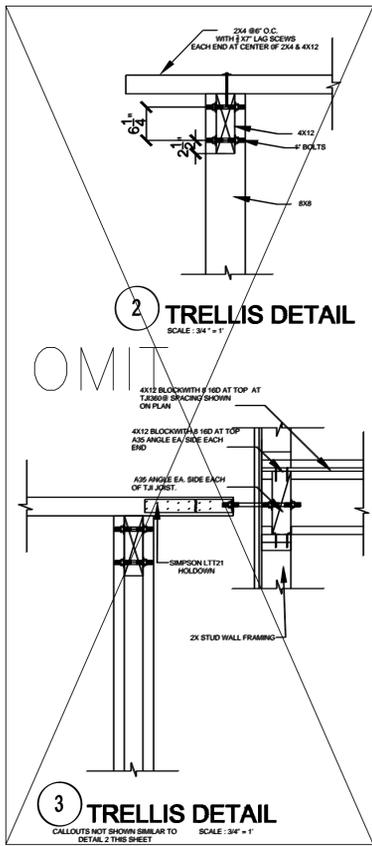
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Job No.: 2011-09

Sheet:
A9.42
Of _____ Sheets

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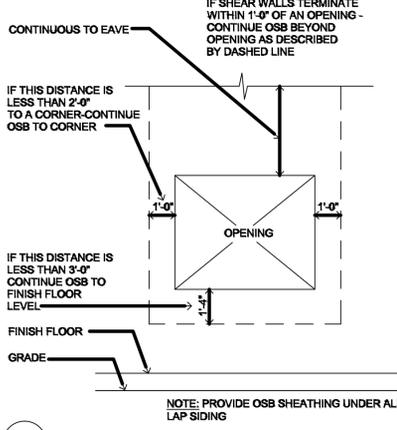
1 SHAPED GUTTER DETAIL
SCALE: 1 1/2" = 1"
SEE DETAIL 1/A9.41 FOR SHEET METAL ALTERNATE




2 TRELLIS DETAIL
SCALE: 3/4" = 1"

1. USE 26 GAUGE (U.N.O.) BONDERIZED GALVANIZED SHEET METAL.
2. SOLDER ALL SHEET METAL JOINTS IN SHOP FABRICATED COMPONENTS.
3. LAP SHEET METAL JOINTS 6" WITH SOLID BED OF SEALANT CONTINUOUS SANDWICHED BETWEEN SHEET METAL PICES.
4. VERIFY BY FIELD MEASUREMENT ALL DIMENSIONS PRIOR TO MANUFACTURE OF ANY SHEET METAL PIECES.
5. MACHINE BEND ALL CORNERS.
6. CLEAN ALL SHEET METAL PRIOR TO INSTALLING WATERPROOF MEMBRANE.
7. USE SIMILAR DETAILING ON SHEET METAL NOT SHOWN.


4 SHEET METAL REQUIREMENTS
NO SCALE



10 OSB AROUND OPENINGS
NO SCALE

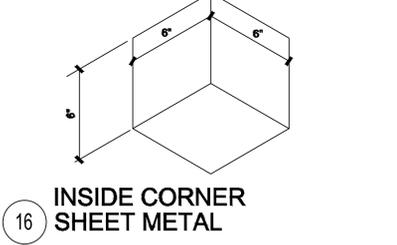


17 OUTSIDE CORNER SHEET METAL AT CONCRETE PATIOS
NO SCALE

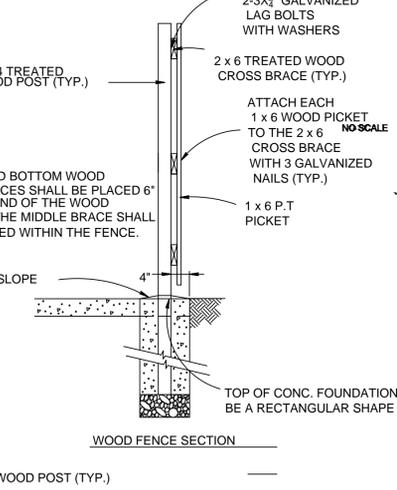


23 SHEET METAL PAN 1ST FLR EXTERIOR DOORS
NO SCALE




5 JOINT COVER
SCALE 3" = 1'-0"

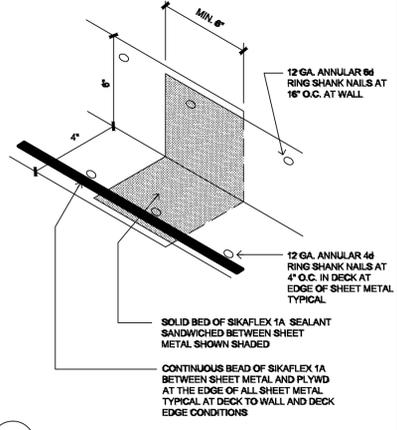


11 SHEET METAL OVERLAP
NO SCALE

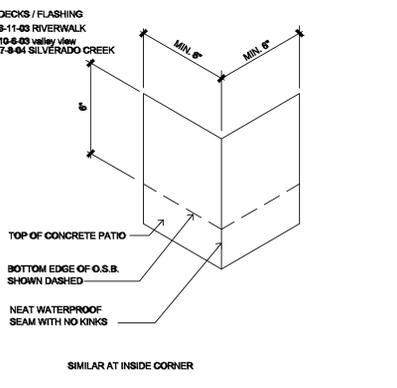


18 SCUPPER @ PARAPET
SCALE 3" = 1'-0"

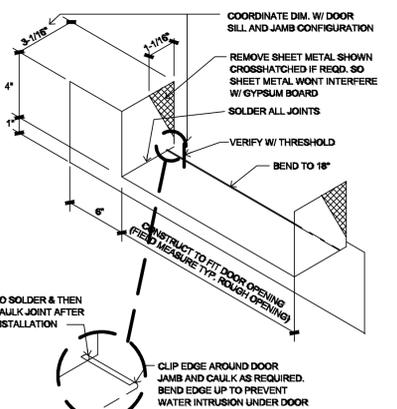


27 SHEET METAL SCUPPER
NO SCALE

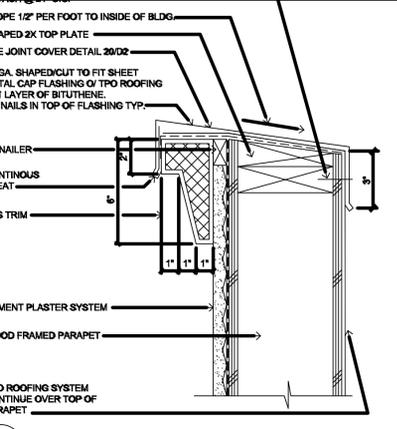


6 PARAPET
SCALE 3" = 1'-0"

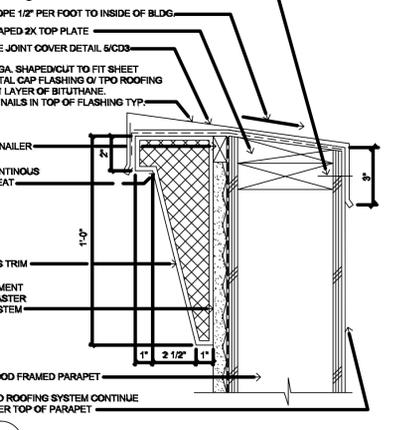

12 PARAPET
SCALE 3" = 1'-0"

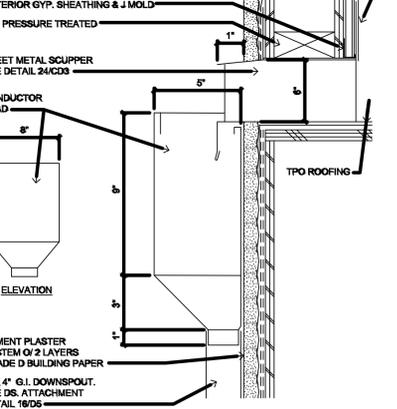


18 SCUPPER @ PARAPET
SCALE 3" = 1'-0"

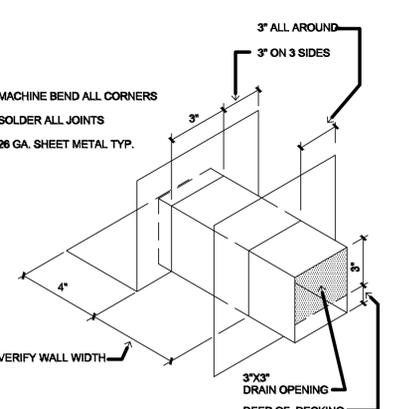

27 SHEET METAL SCUPPER
NO SCALE




7 TRELLIS DETAIL
SCALE: 3/4" = 1"

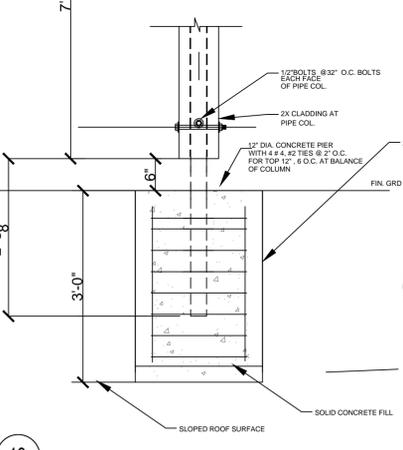

13 TRELLIS DETAIL COLUMN FOOTING AT SLOPED ROOF
SCALE: 3/4" = 1'-0"


8 TRELLIS DETAIL
SCALE: 3/4" = 1"

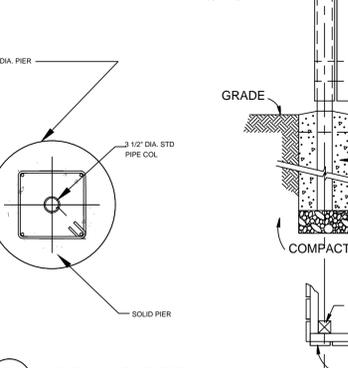

14 TRELLIS DETAIL
SCALE: 3/4" = 1"



15 TRELLIS DETAIL
SCALE: 3" = 1'-0"

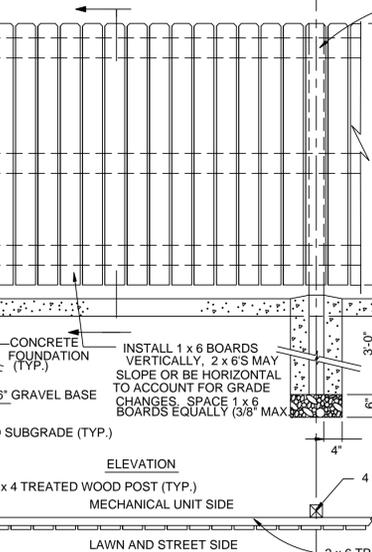

15 TRELLIS DETAIL
SCALE: 3" = 1'-0"












REVISIONS	BY
9/26/2011 - PLAN CHECK	G.O.

JOSEPH OAKLEY
REGISTERED ARCHITECT
NO. 15457
EXPIRES 9-30-11
STATE OF CALIFORNIA

PROJECT TITLE:
COMMUNITY CENTER
HARBOR PARK APARTMENTS
969 PORTER STREET, VALLEJO, CA 94560
DRAWING TITLE:
ARCHITECTURAL DETAILS

Date:	04/17/2012
Scale:	AS NOTED
Drawn:	STAFF
Checked:	RY
Job No.:	2011-09
Sheet:	A9.4

Jan 20, 2014 - B:\ban\server\drive.d\Year 2011\Jobs\2011-093 - Community Bldg\REVISED DRAWINGS FOR NEGOTIATED CONTRACT WITH VE LYDINS\ARCHITECT\9519.dwg

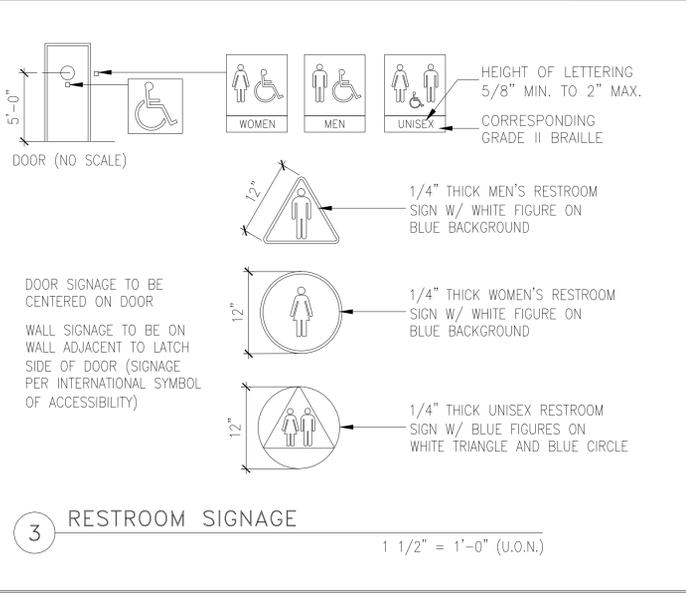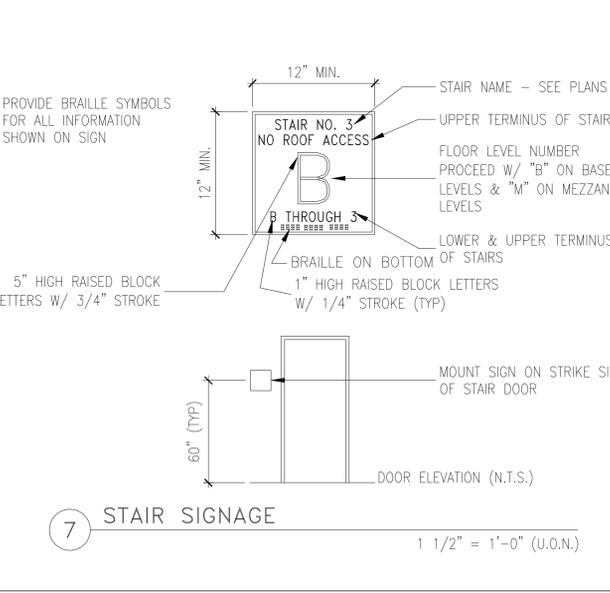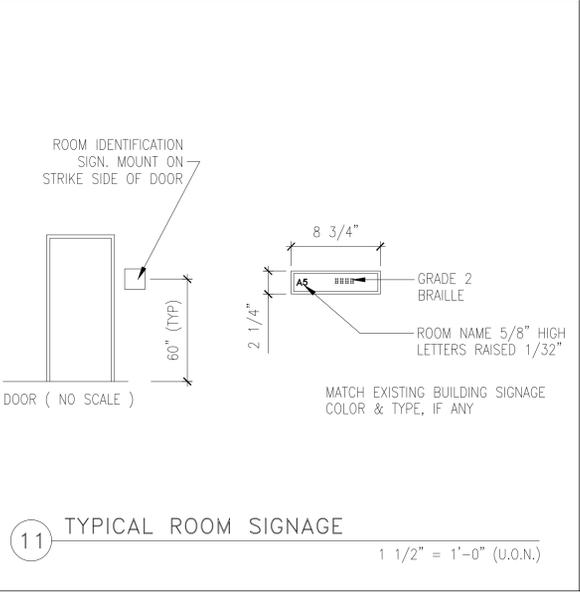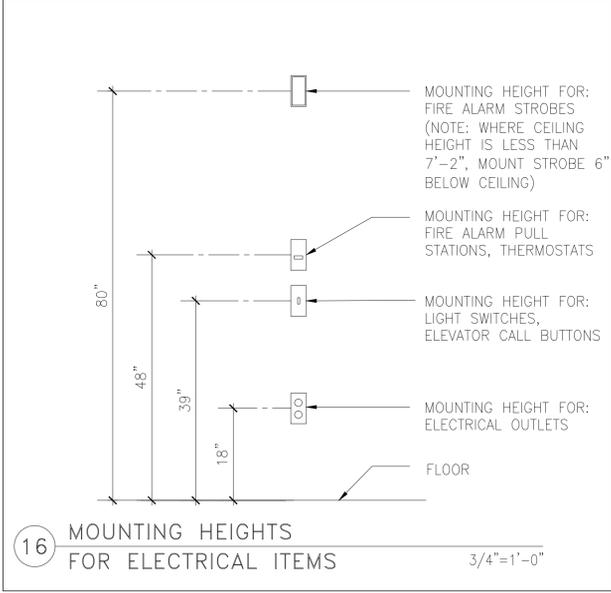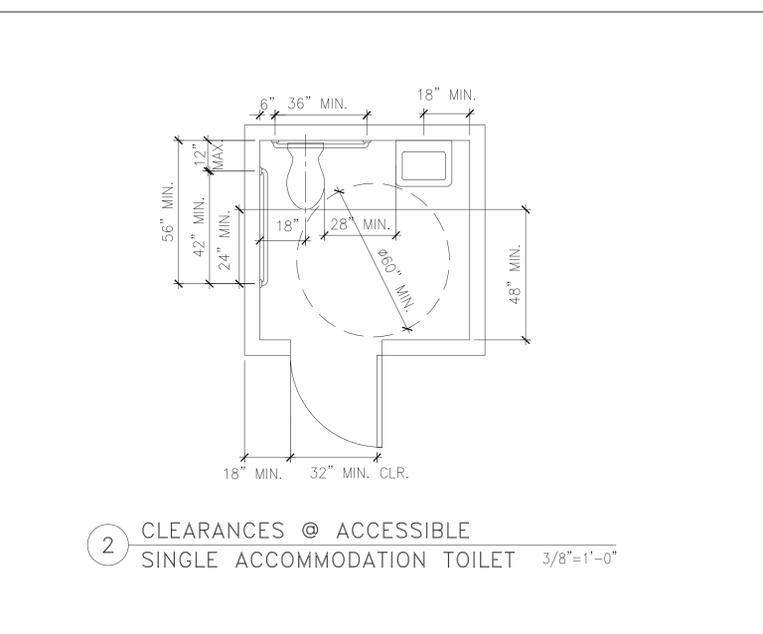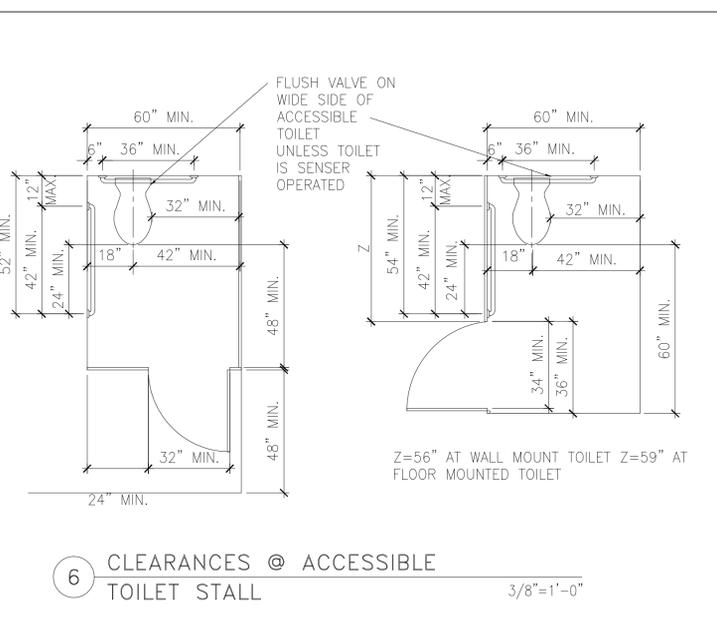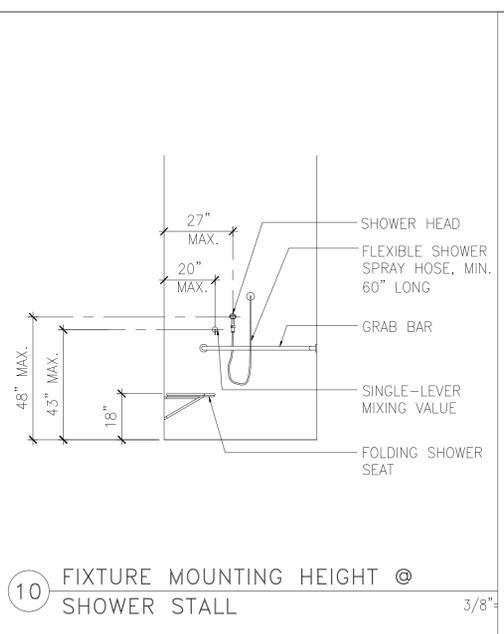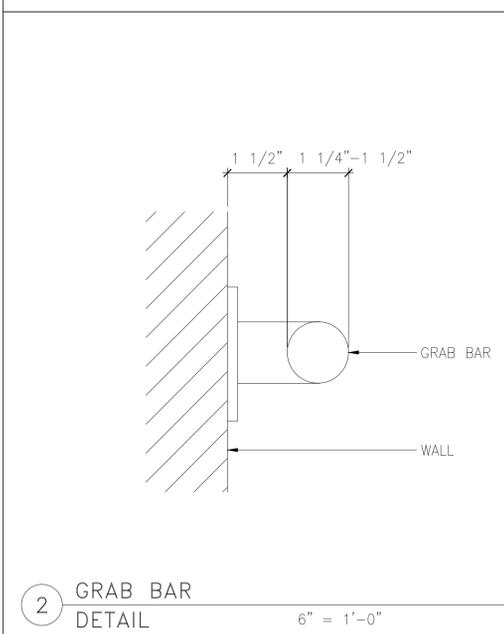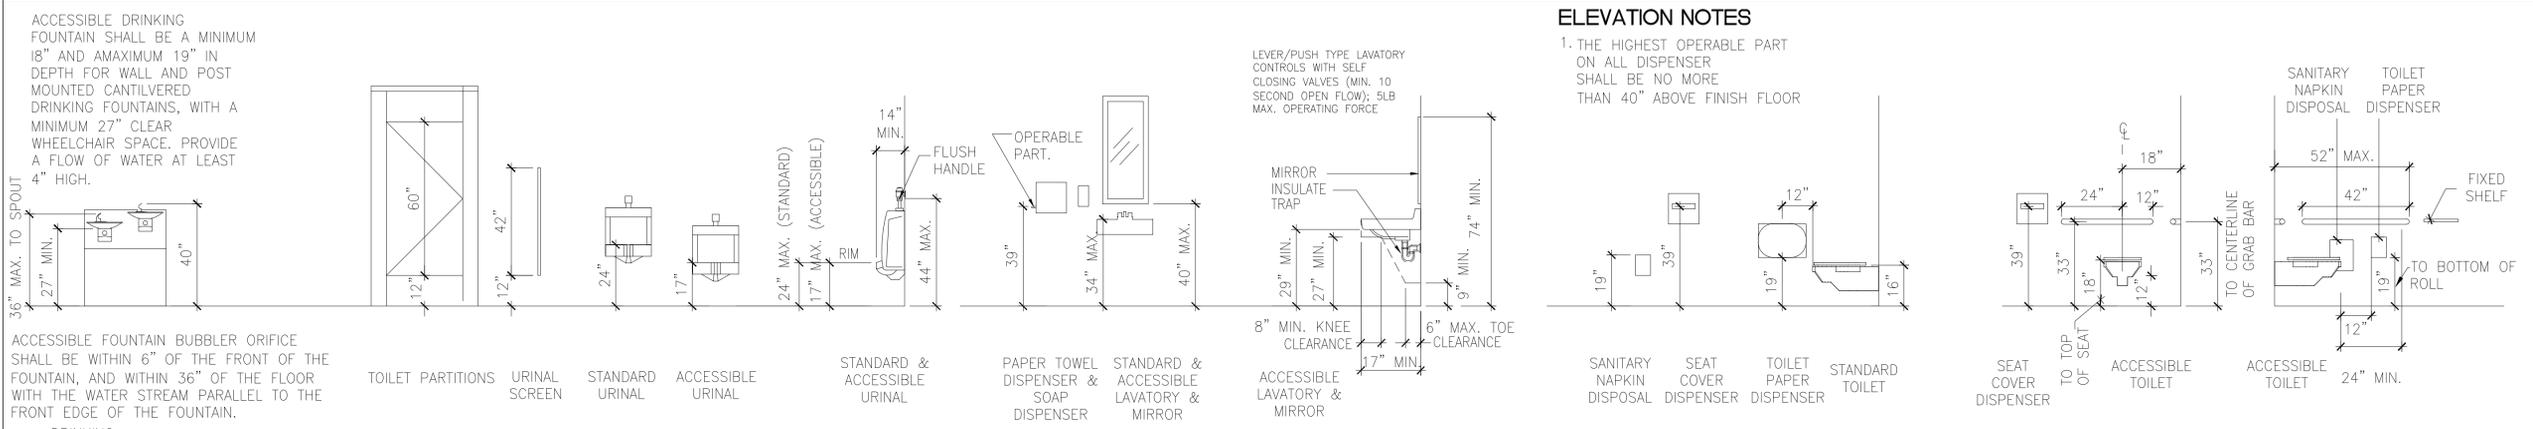


REVISIONS	BY
9/26/2011 - PLAN CHECK	G.O.

OAKLEY & OAKLEY
 ARCHITECTURAL & STRUCTURAL ENGINEERS
 7700 EDGEWATER DRIVE, SUITE 615
 OAKLAND, CA 94628
 FAX 510-562-6043

PROJECT TITLE:
COMMUNITY CENTER
 HARBOR PARK APARTMENTS
 969 PORTER STREET, VALLEJO, CA 94580
 DRAWING TITLE:
ADA REQUIREMENTS

Date:	04/17/2012
Scale:	AS NOTED
Drawn:	STAFF
Checked:	RY
Job No.:	2011-09
Sheet:	A9.5

Jan 27, 2014 - 8:44pm \\SERVER\Server Drive D\Year 2011 Jobs\2011-09-3 - Community Bldg\REVISED DRAWINGS FOR NEGOTIATED CONTRACT WITH W. LYONS\STRUCTURAL\S1.2 - CURRENT 6-01-2013 2nd Floor Framing Plan_082012.dwg

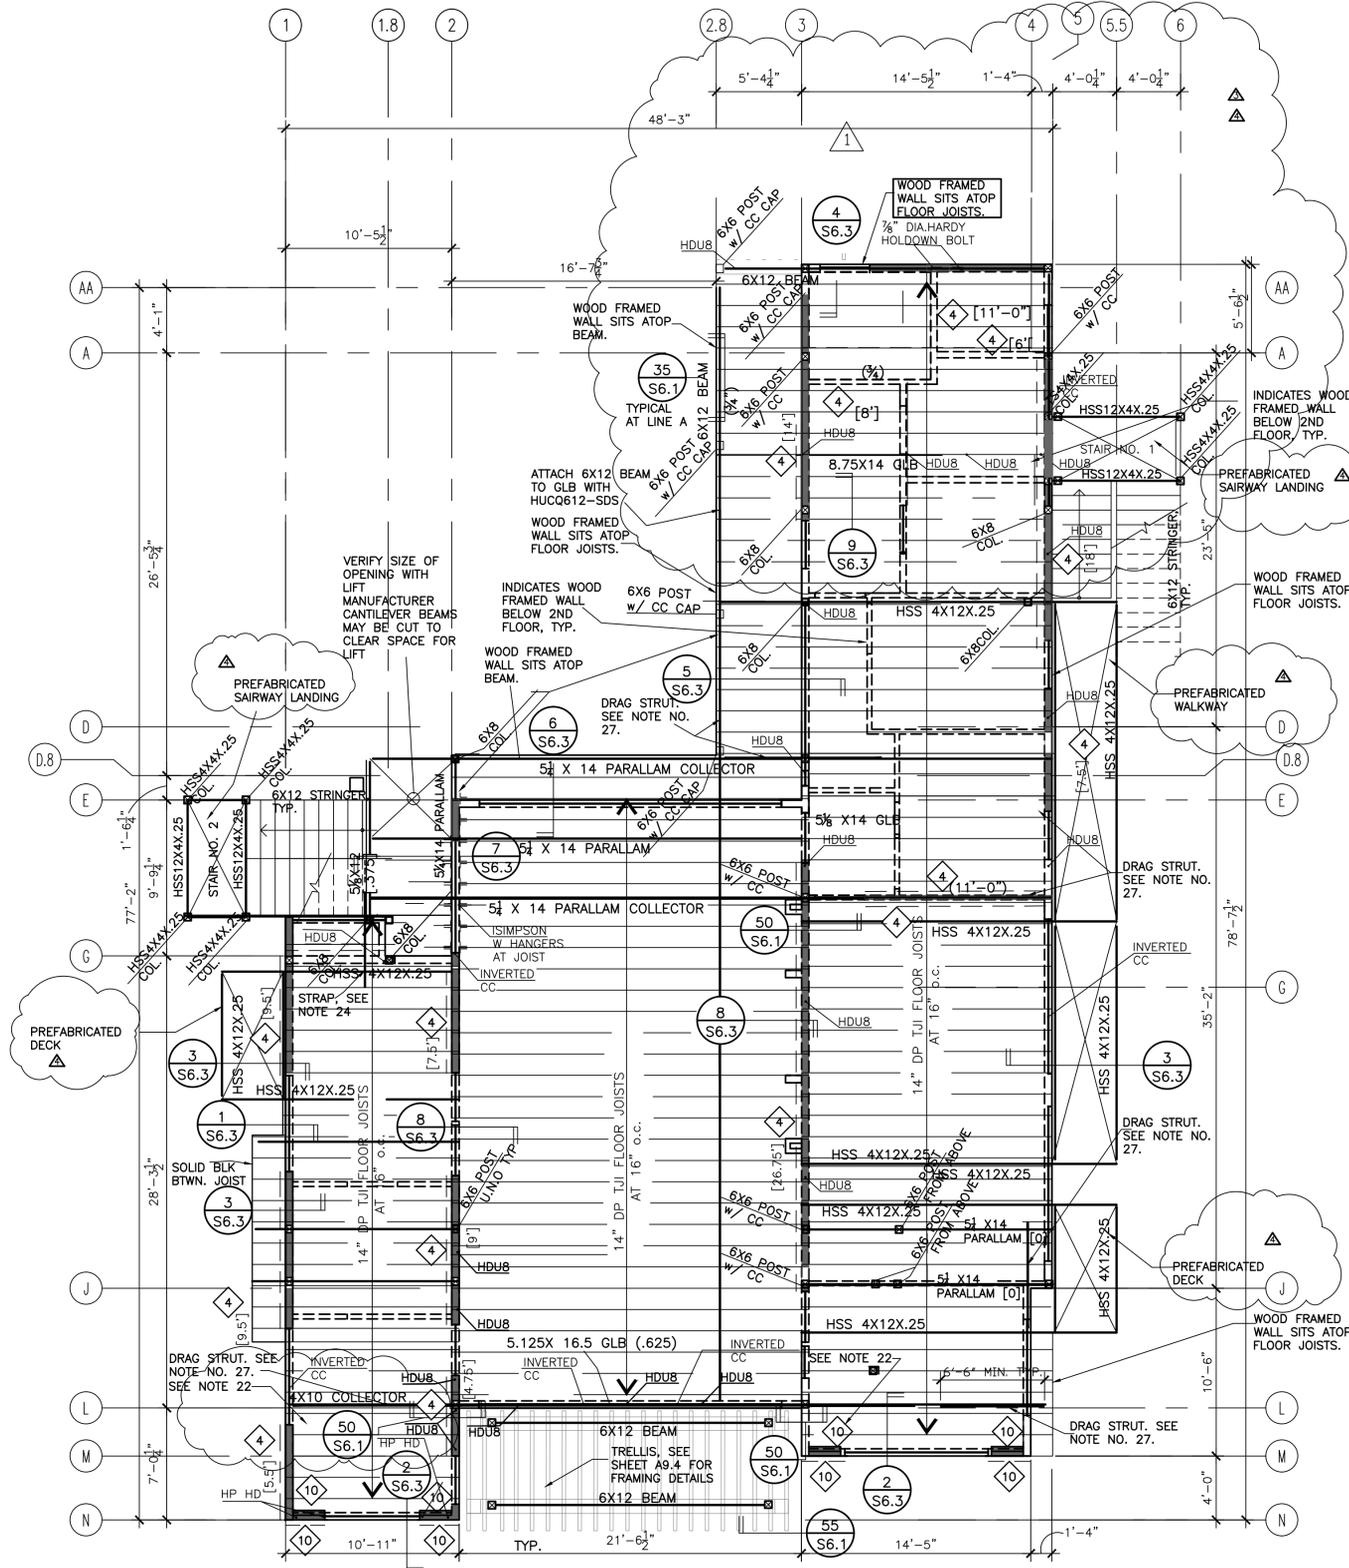

01 COMMUNITY CENTER 2ND FLOOR FRAMING PLAN
 SCALE: 3/16" = 1'-0" NOTE ALL PLYWOOD EDGES SHALL BE BLOCKED AT WALL, ROOF AND FLOOR SHEATHING EXCEPT ROOF ABOVE THIRD FLOOR

2ND FLOOR FRAMING NOTES

1. SEE GENERAL NOTES ON SHEET S0.1.
2. SEE TYPICAL WOOD DETAILS ON SHEET S6.1 AND S6.2.
3. SEE ARCHITECTURAL DRAWINGS FOR FINISHED FLOOR ELEVATIONS.
4. MARKS "TJI" ETC. INDICATE WOOD TRUSS JOIST.
5. NEW STRUCTURAL WOOD WALLS ARE SHOWN THUS: OR THUS: ON PLAN AND SHALL BE AS FOLLOWS:
 2X6 AT 16" o.c. FROM GROUND/FDN TO 2ND FLOOR
 2X6 AT 16" o.c. FROM 2ND FLOOR TO THE ROOF.

 USE 3X STUDS ALL ALL WOOD FRAMED SHEAR WALLS.
 SEE ARCHITECTURAL DRAWINGS FOR NON-LOAD BEARING PARTITIONS.
6. DENOTES (N) 15/32" THK. STRUCTURAL I PLYWOOD SHEAR WALL. AS REQUIRED. PLYWOOD EXTENDS FULL HEIGHT OF THE WALL. SEE DETAILS AND SCHEDULE ON SHEET S1-04.
7. FLOOR TO FLOOR HOLDOWN TIES ARE REQUIRED AT EACH END OF SHEAR WALL AND AT LOCATIONS NOTED THUS: . ALL HOLDOWNS TO BE ON 6x6 POST U.N.O. SEE DETAILS ON SHEET S3.1, AND S6.1 AND S6.2
8. WHERE METAL FRAMING CONNECTORS ARE REQUIRED, "SIMPSON" CONNECTORS ARE DENOTED.
9. ON PLAN INDICATES 6X6 POST U.N.O.
10. SEE FOR HEADER SIZES NOT CALLED OUT ON PLAN
11. SEE ARCH. DWGS. FOR SLOPES OF ROOFS/EXTERIOR DECKS.
12. ALL GLULAM BEAMS 24F-V4
13. [X] INDICATES CAMBER IN GLULAM BEAMS
14. SEE ARCH. DWGS. FOR EXACT LOCATION OF WINDOWS & DOORS.
15. ALL FLOOR JOIST ARE 14" DEEP U.N.O. WITH 1/2" LIGHTWEIGHT CONCRETE TOPPING OVER 3/4" CDX PLYWOOD.
16. AT SHEAR WALL TYPE AND PROVIDE HARDY PANEL PER THE WIDTHS INDICATED ON THE SHEAR WALL SCHEDULE SHOWN ON SHEET S6.2. PROVIDE ASSOCIATED HOLDOWNS, SILL ANCHORAGE AND SHEAR TRANSFER DETAILS PER THE MANUFACTURES STANDARD DETAILS.
17. WHERE NOTED ON PLAN AS "HP HD" INDICATES HARDY PANEL HOLDOWN. PROVIDE HARDY PANEL FLOOR TO FLOOR HOLDOWN PER THE MANUFACTURES STANDARD DETAILS.
18. WHERE NOTED ON PLAN AS "HP HD*" INDICATES HARDY PANEL HOLDOWN THAT RESTS ATOP A BEAM. PROVIDE HARDY PANEL FLOOR TO BEAM HOLDOWN PER THE MANUFACTURES STANDARD DETAILS.
19. NOT USED.
20. ALL TJI'S ARE TJI/360, TYP. U.N.O..
21. 6X6 POST FROM ABOVE
22. PROVIDE BLOCKING @ 4'-0" O.C. IN-BETWEEN JOISTS BLOCK ALL PLYWOOD EDGES
23. DOUBLE JOIST UNDER ALL PARALLEL PARTITIONS.
24. 10' LONG CMST12 STRAP. CENTER STRAP AT END OF BEAM AND PROVIDE FULL BLOCKING AT FLOOR JOIST
25. NOT USED.
26. FOR STAIR 1 AND STAIR 2 FRAMING PLANS AND ELEVATIONS, SEE SHEET S5.1.
27. INDICATES DRAG STRUT/CHORD USING CMST12 CONT. STRAP. SEE FOR CONNECTION INFO. EXTEND STRAP ACROSS ENTIRE DIAPHRAGM U.N.O.



REVISIONS	BY
9/26/2011 - PLAN CHECK	G.O.
2/3/2012 - 3RD STRY	RT.J
ADDED NOTE FOR POST FROM ABOVE AND SUPPOR BEAMS	
ENLARGED ELECTRIC ROOM	
ADDED PREFABRICATED STAIRS AND BALCONY	
REVISED FLOOR FRAMING RIDING	




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 REGISTERED PROFESSIONAL ENGINEERS
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 P.O. BOX 9870
 P.A. 94616-9870

PROJECT TITLE:
COMMUNITY CENTER
 HARBOR PARK APARTMENTS
 969 PORTER STREET, VALLEJO, CA 94560
 DRAWING TITLE:
2ND FLOOR FRAMING PLAN

Date:	08/30/2011
Scale:	AS NOTED
Drawn:	STAFF
Checked:	RY
Job No.:	2011-09
Sheet:	

S1.2
 of Sheets

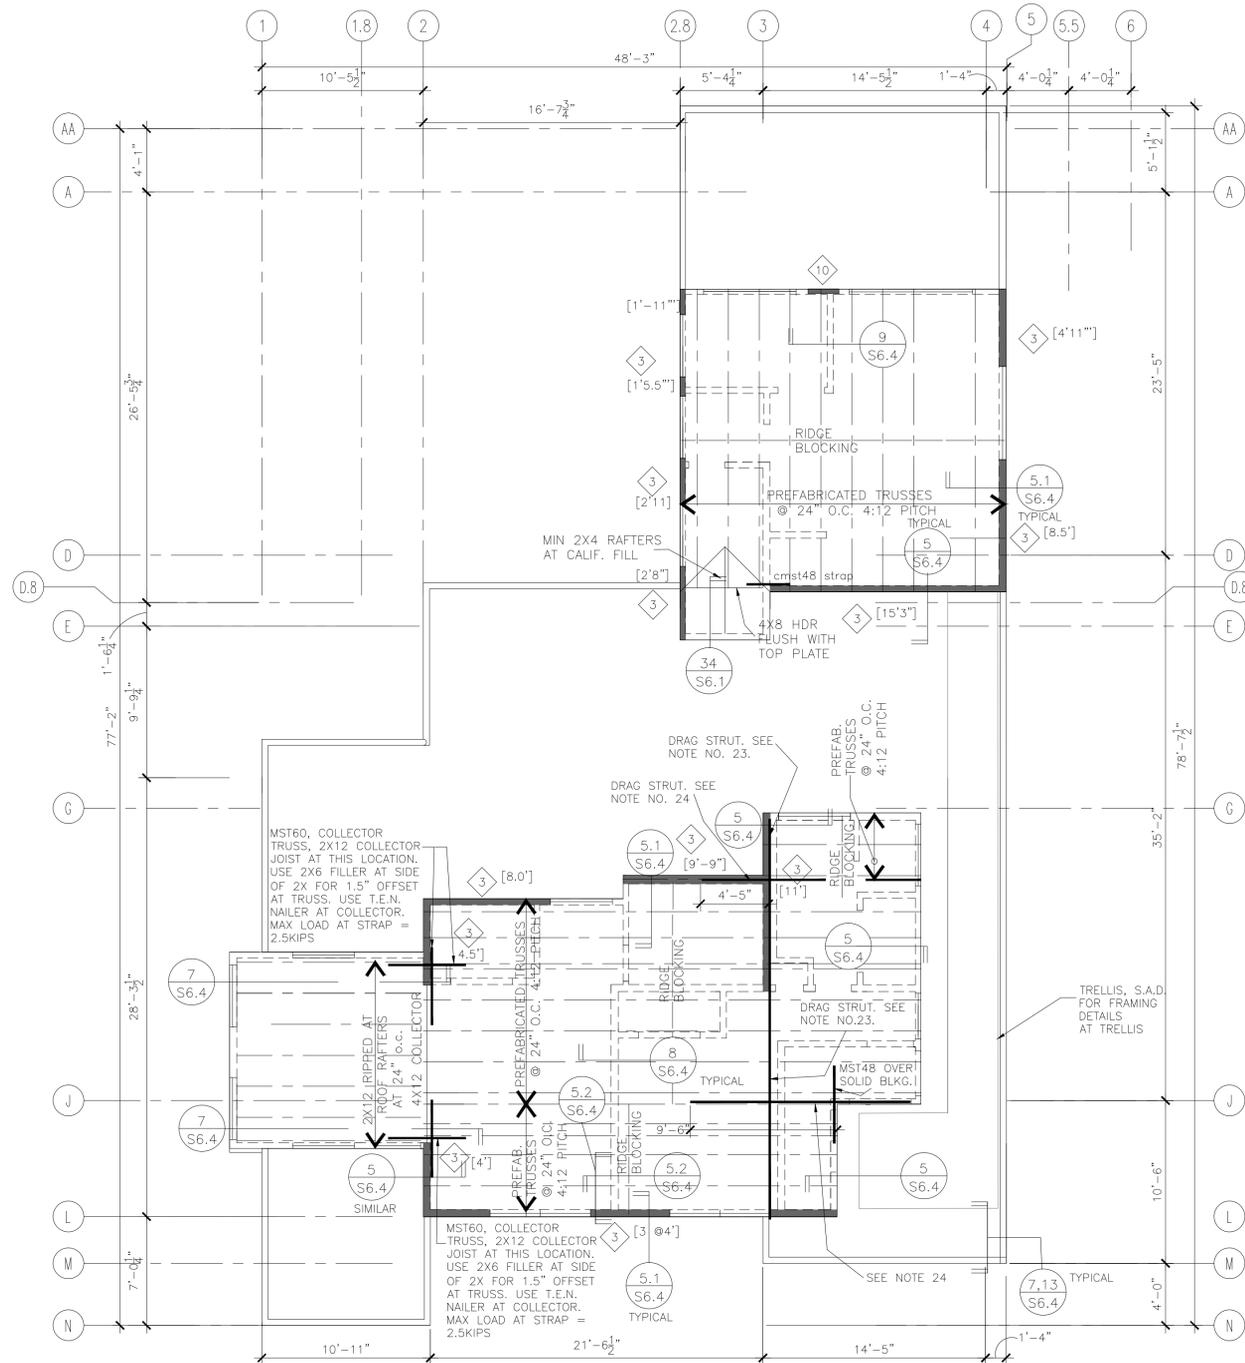

01 **COMMUNITY CENTER ROOF FRAMING PLAN**
 SCALE: 1/4" = 1'-0" UNLESS NOTED OTHERWISE, MIN HEADERS AT OPENINGS AT SHOWN THIS SHEET SHALL BE 6X8 AT EXTERIOR WALLS, 4X8 AT INTERIOR WALLS



ROOF FRAMING NOTES

- SEE GENERAL NOTES ON SHEET S0.1.
- SEE TYPICAL WOOD DETAILS ON SHEETS S6.1 AND S6.3.
- WHERE NOTED ON PLAN, PROVIDE 2x12 TAPERED TO 2x10 AT 24" O.C. SEE ARCH.
- STRUCTURAL WOOD WALLS SUPPORTING THE ROOF ARE SHOWN THUS: OR THUS: WHERE PARAPET OCCURS. SEE ARCHITECTURAL DRAWINGS FOR NON-LOAD BEARING PARTITIONS.
- WHERE NEW METAL FRAMING CONNECTORS ARE REQUIRED, "SIMPSON" CONNECTORS ARE DENOTED.
- NOT USED.
- SEE FOR HEADER SIZES NOT CALLED OUT ON PLAN
- SEE ARCH. DWGS. FOR SLOPES OF ROOFS.
- ALL GLULAM BEAMS 24F-V4
- [X] INDICATES CAMBER IN GLULAM BEAMS
- SEE ARCH. DWGS. FOR EXACT LOCATION OF WINDOWS AND DOORS.
- INDICATES NEW SHEAR WALL. SEE SCHEDULE ON SHEET S6.2.
- ALL NEW WOOD FRAMED BEARING WALLS ARE 2x6 @ 16" O.C. TYP. U.N.O. USE 3x6 STUDS AT SHEAR WALLS
- AT SHEAR WALL TYPE AND PROVIDE HARDY PANEL PER THE WIDTHS INDICATED ON THE SHEAR WALL SCHEDULE SHOWN ON SHEET S6.2. PROVIDE ASSOCIATED HOLDOWNS, SILL ANCHORAGE AND SHEAR TRANSFER DETAILS PER THE MANUFACTURES STANDARDS.
- NOT USED.
- ALL TJI'S ARE TJI/360, TYP U.N.O.
- WHERE NOTED ON PLAN PROVIDE 11 7/8" DP TJI JOIST AT 24" o.c..
- ROOF SHEATHING IS 5/8" STRUCT 1 PLYWOOD w/ 10d NAILS AT 4" o.c., PROVIDE BLOCKING.
- NOT USED.
- U.N.O. TOP PLATE SPLICES ALONG GRIDLINES THAT ARE SHEARWALLS SHALL BE MST48
- USE 8'-0" LONG CMST12 BOTH WAYS, CENTER ON CORNER BLOCK FLOOR JOISTS AS REQUIRED
- NOT USED.
- INDICATES DRAG STRUT/CHORD USING CMST12 CONT. STRAP. SEE FOR CONNECTION INFO.
- DESIGN TRUSSES AT STRUT LOCATIONS FOR 2.5 KIP LOAD AT TOP CHORD. USE CMST12 STRAP AS TENSION TIE UNLESS NOTED OTHERWISE
- WHERE NOTED ON PLAN INDICATES EXTENT OR TAPERED INSULATION. SEE ARCHITECTURAL DRAWING FOR ADDITIONAL INFORMATION
- FOR STAIR 1 AND STAIR 2 FRAMING DETAILS AND ELEVATIONS, SEE SHEET S5.1

REVISIONS	BY
9/26/2011 - PLAN CHECK	G.O.










OAKLEY & OAKLEY
 ARCHITECTURAL & STRUCTURAL ENGINEERS
 7700 EDGEWATER DRIVE, STE. 615
 SAN DIEGO, CA 92121
 P.O. BOX 510762
 SAN DIEGO, CA 92162
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PROJECT TITLE:
COMMUNITY CENTER
 HARBOR PARK APARTMENTS
 959 PORTER STREET, VALLEJO, CA 94580
 DRAWING TITLE:
ROOF FRAMING PLAN


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Job No.:	2011-09
Sheet:	

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 of Sheets

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REVISIONS	BY
9/26/2011 - PLAN CHECK	G.O.

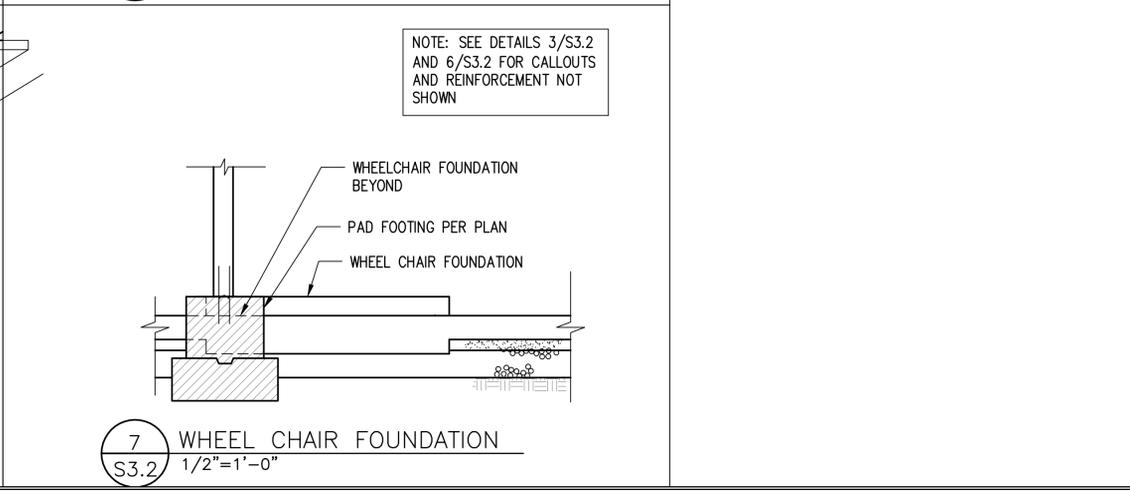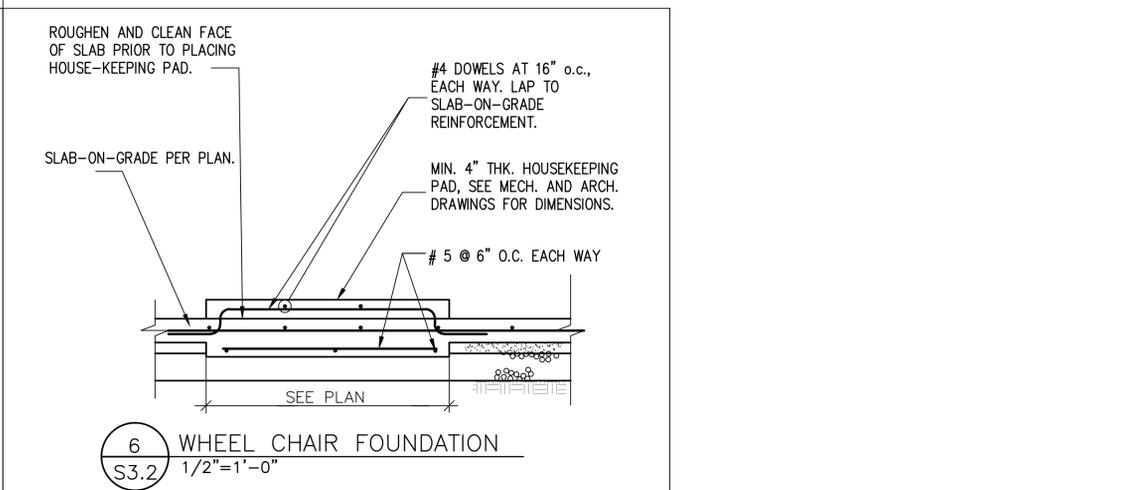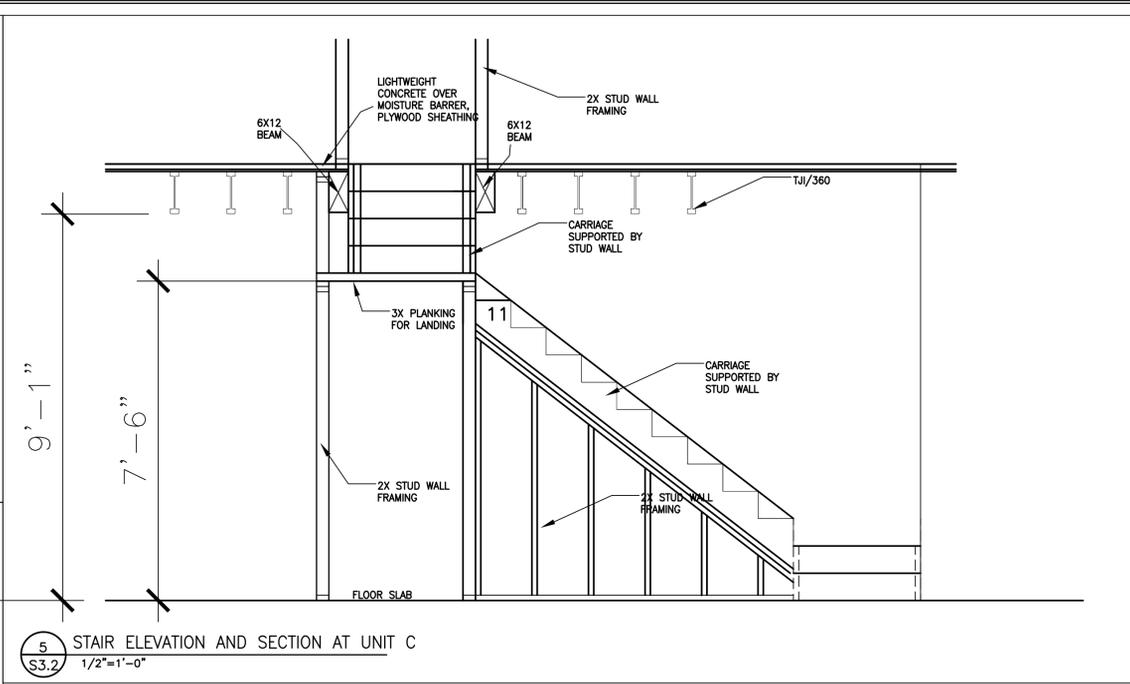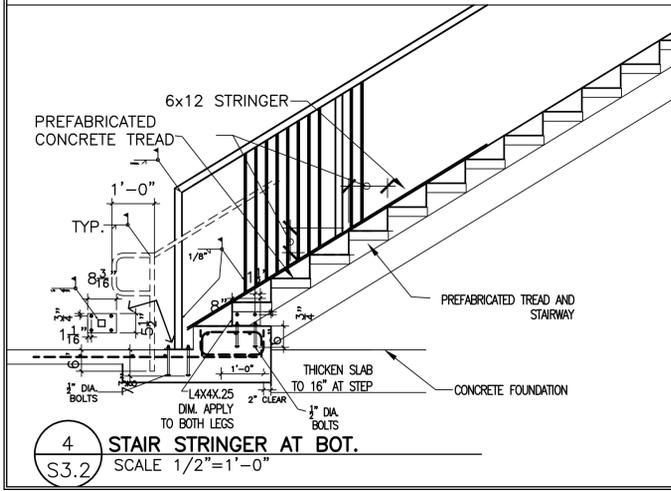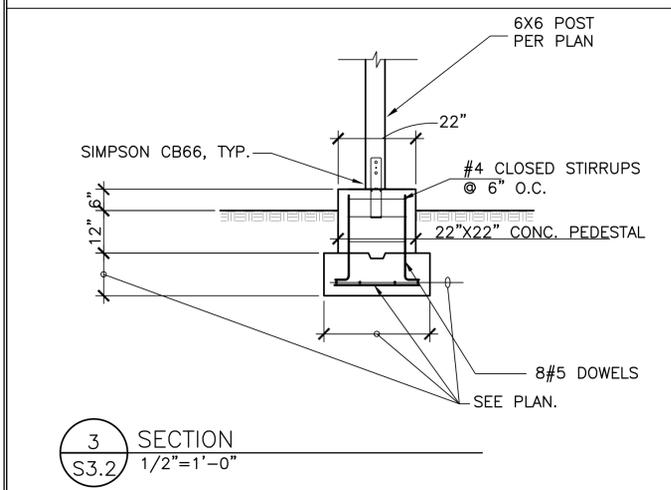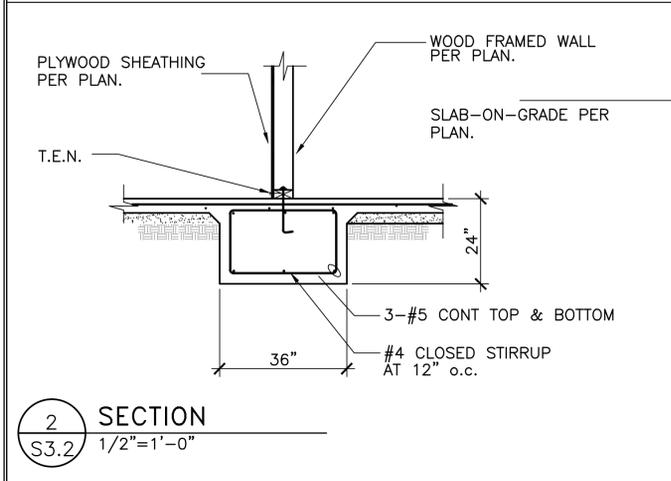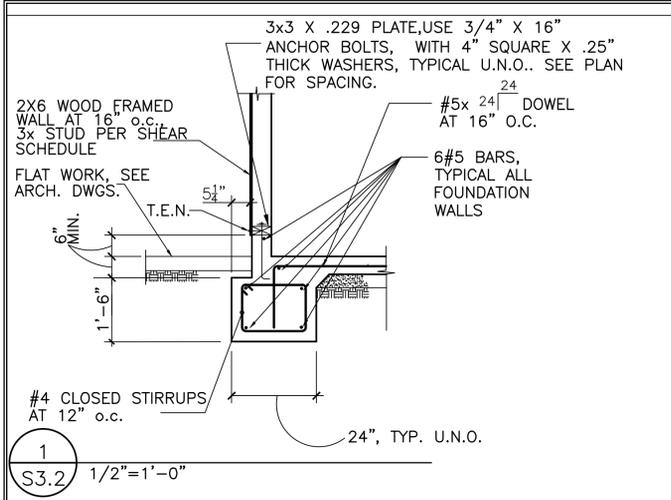



PROJECT TITLE:
COMMUNITY CENTER
 HARBOR PARK APARTMENTS
 969 PORTER STREET, VALLEJO, CA 94560
 DRAWING TITLE:
FOUNDATION DETAILS

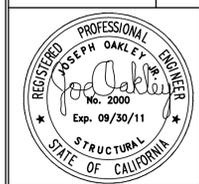OAKLEY & OAKLEY
 ARCHITECTS & STRUCTURAL ENGINEERS
 1000 S. GAVIN AVENUE, SUITE 615
 OAKLAND, CA 94612
 TEL: 510.862.6043
 FAX: 510.862.6043


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 Drawn: STAFF
 Checked: RY
 Job No.: 2011-09
 Sheet:

S3.2
 OF Sheets

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REVISIONS	BY
9/26/2011 - PLAN CHECK	G.O.
1-8-14 BIDDING	T.G.
1-27-14 BIDDING	J.O.










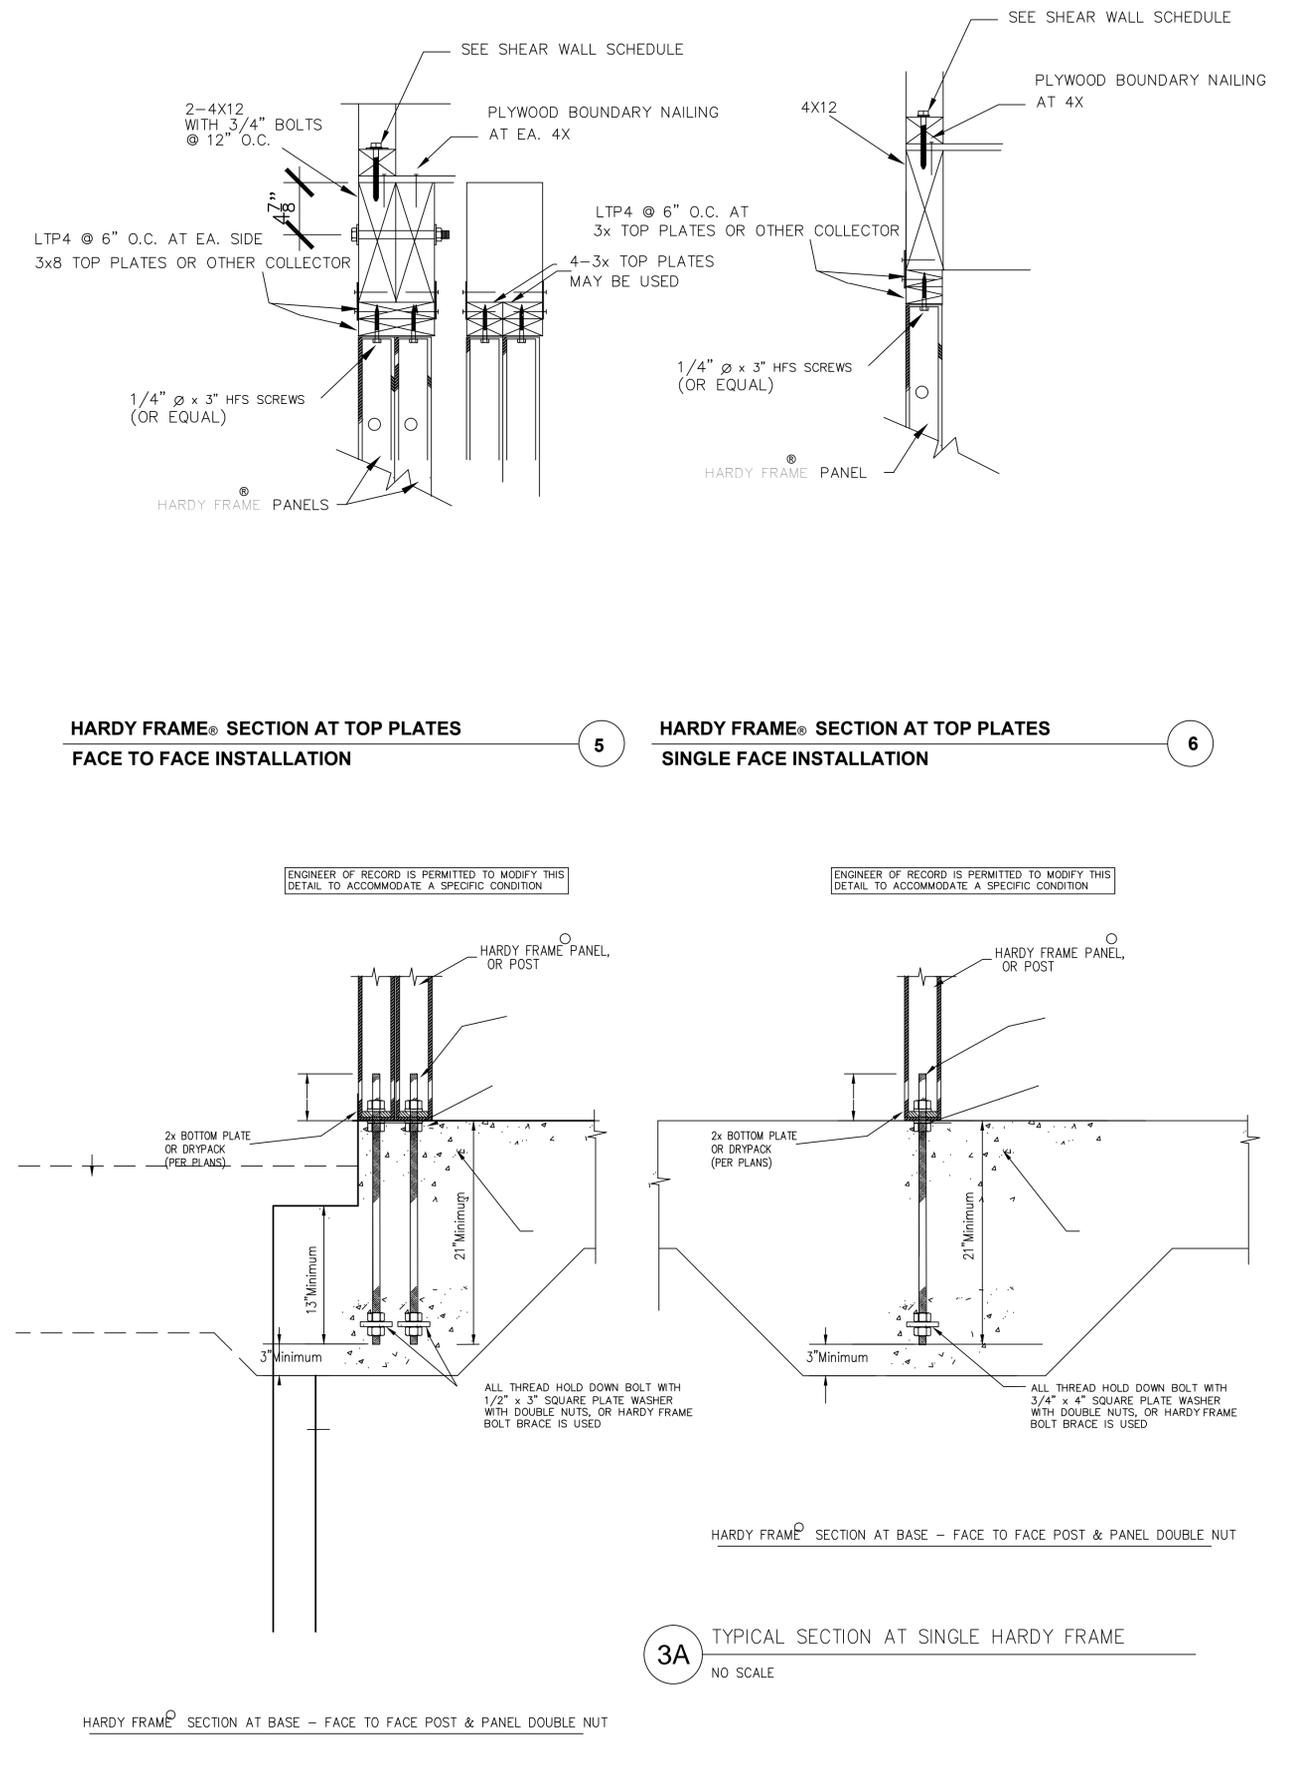
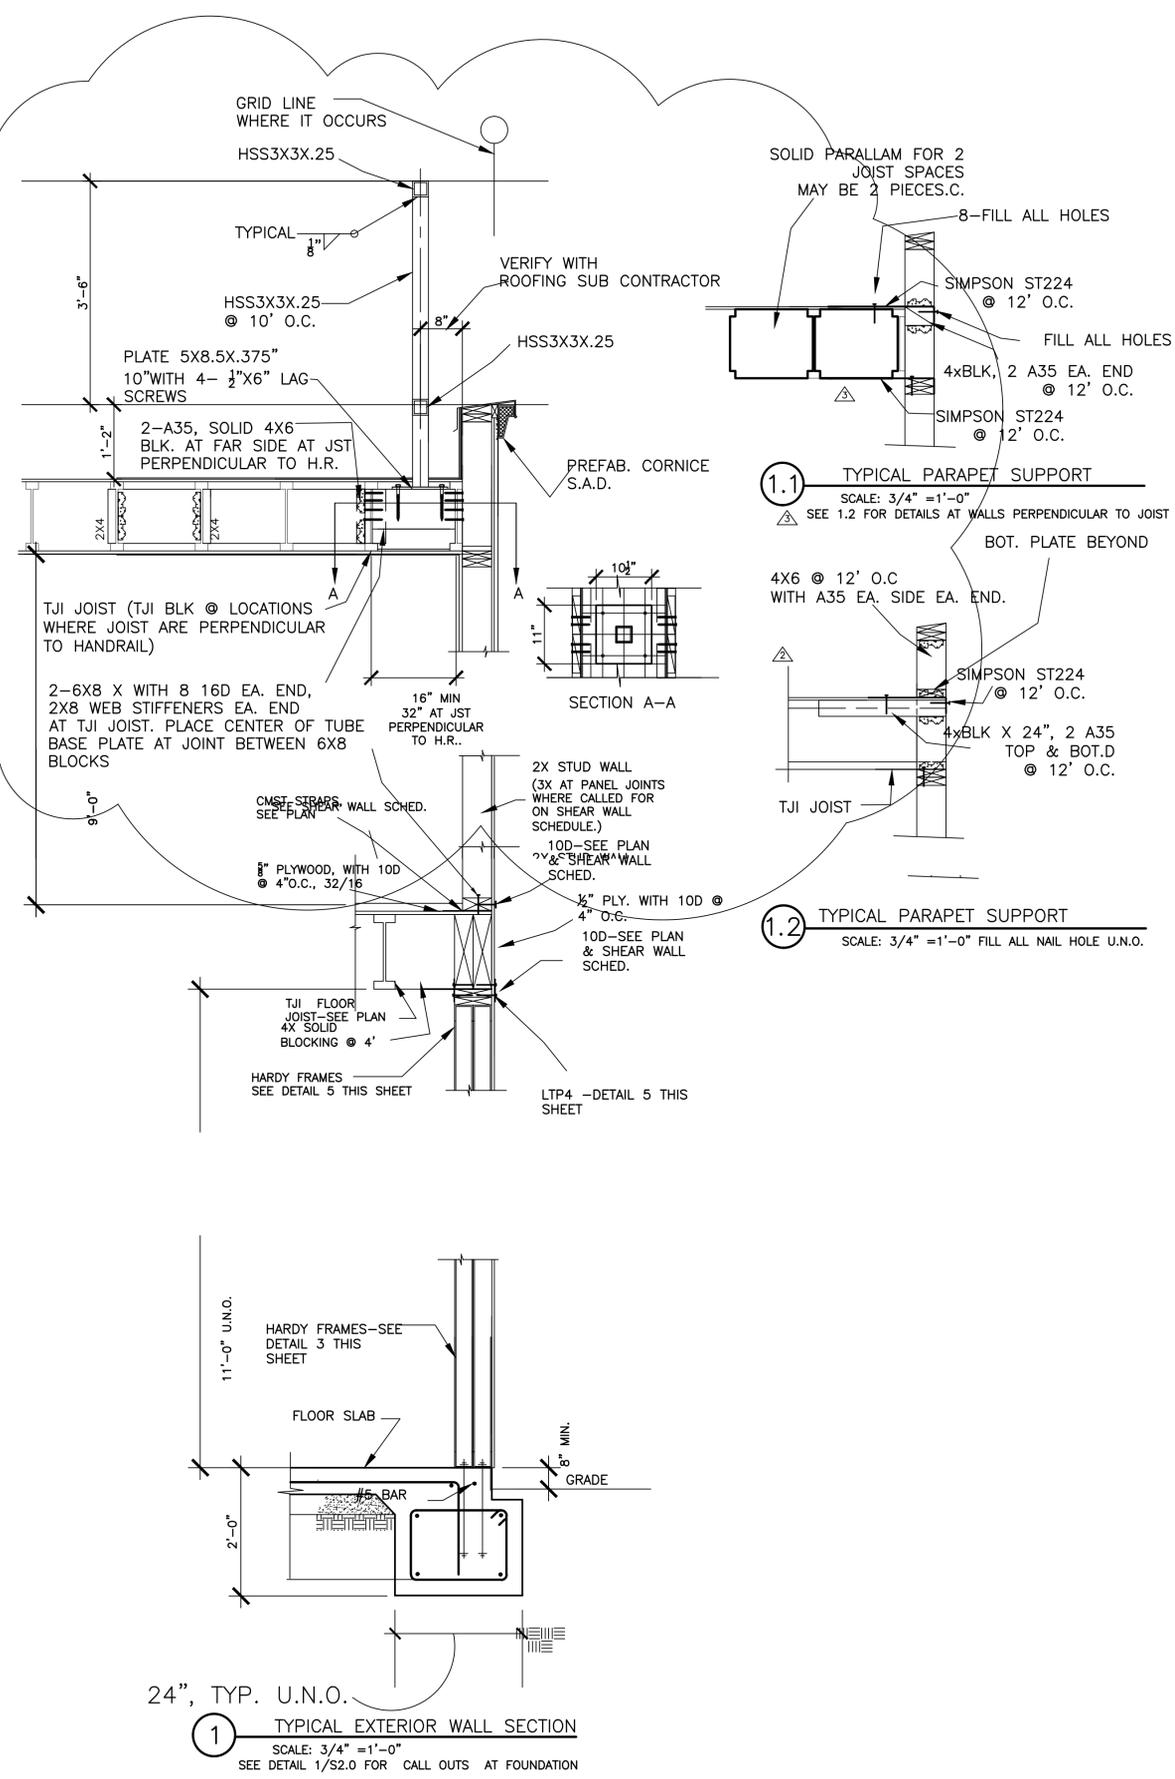


OAKLEY & OAKLEY
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 7700 GENEVA DRIVE, SUITE 615
 OAKLAND, CA 94621
 P.O. BOX 9510, 95626-0043

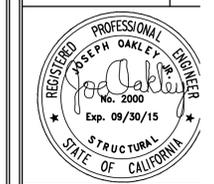
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COMMUNITY CENTER
 HARBOR PARK APARTMENTS
 969 PORTER STREET, VALLEJO, CA 94560
 DRAWING TITLE:

Date:	08/30/2011
Scale:	AS NOTED
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Job No.:	2011-09
Sheet:	S3.21

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REVISIONS	BY
9/26/2011 - PLAN CHECK	G.O.

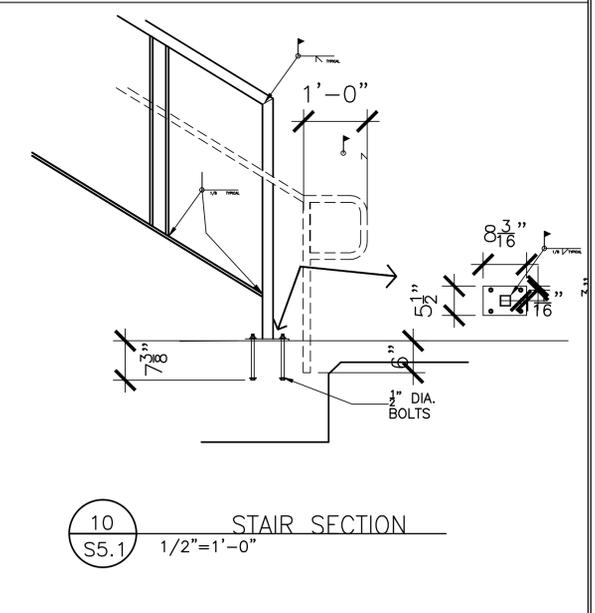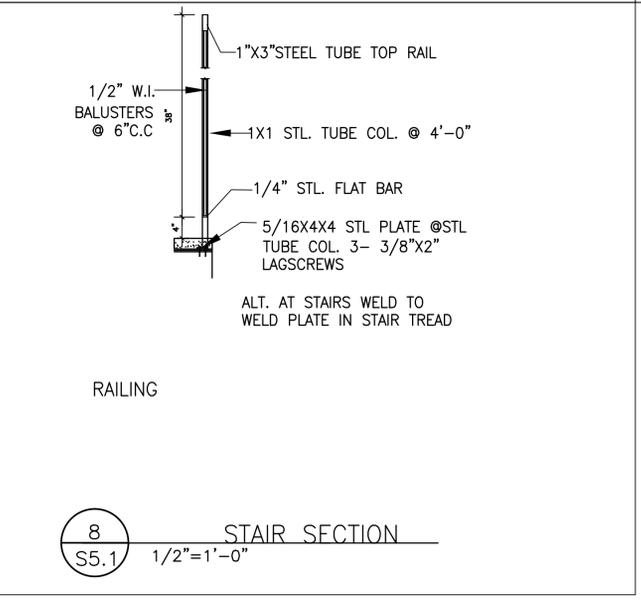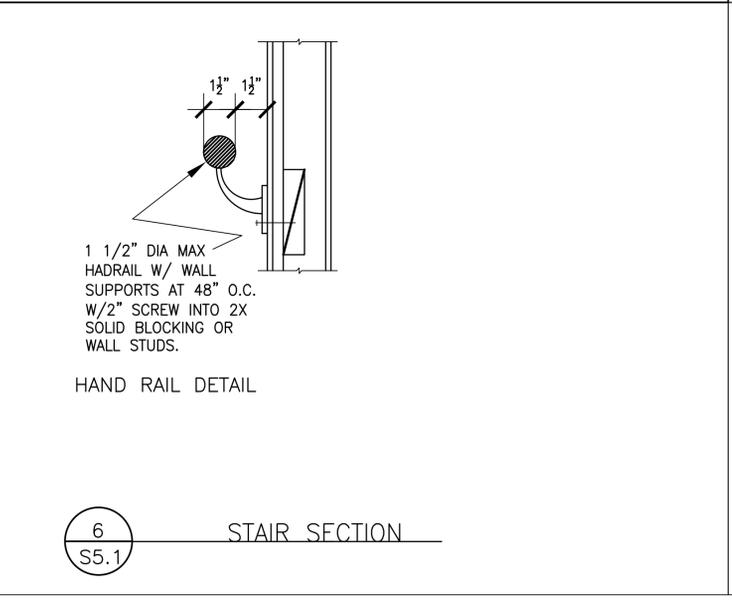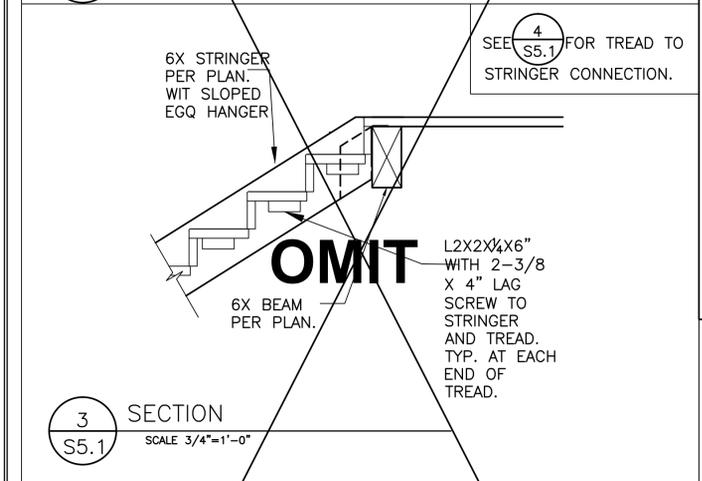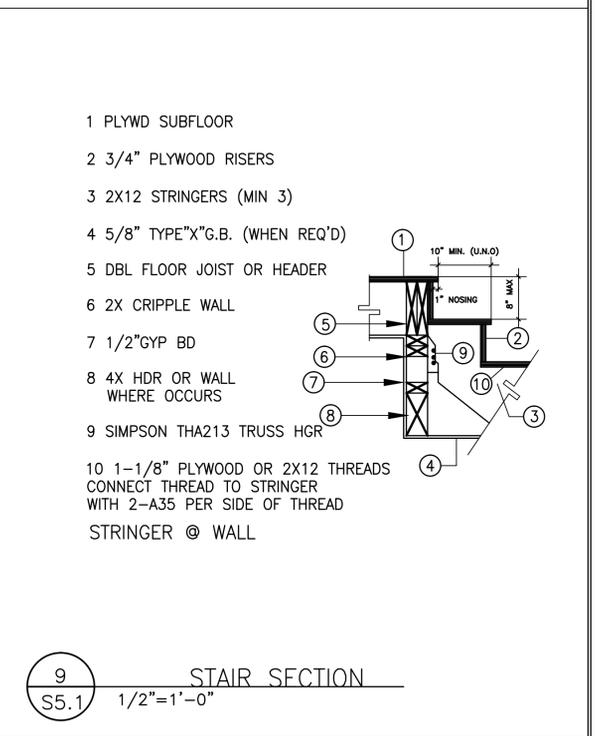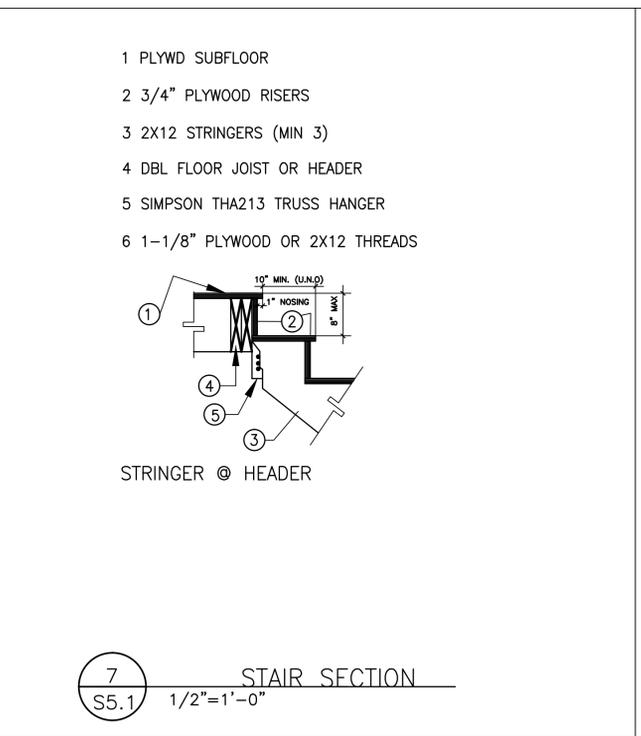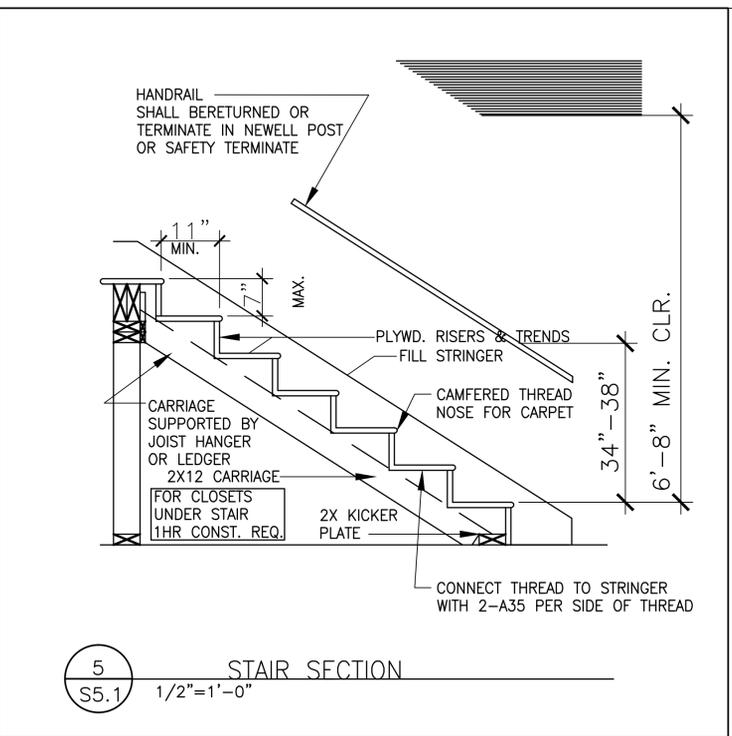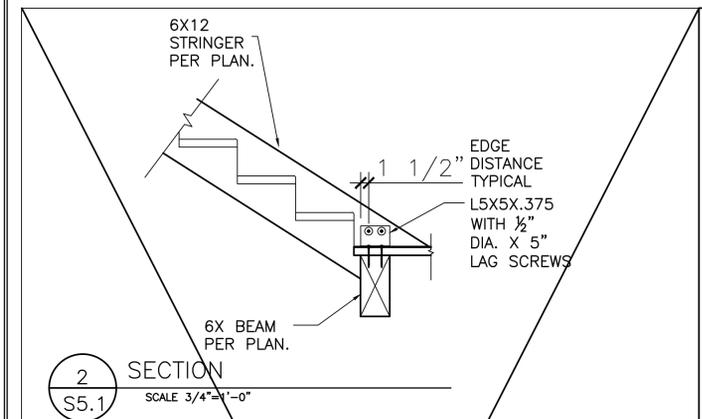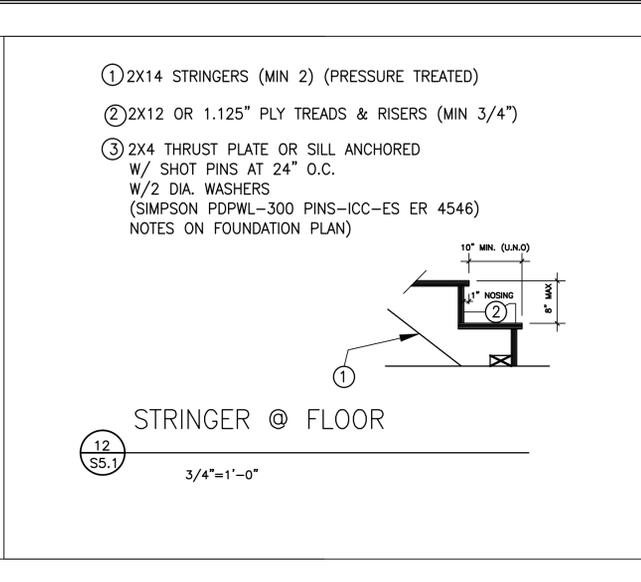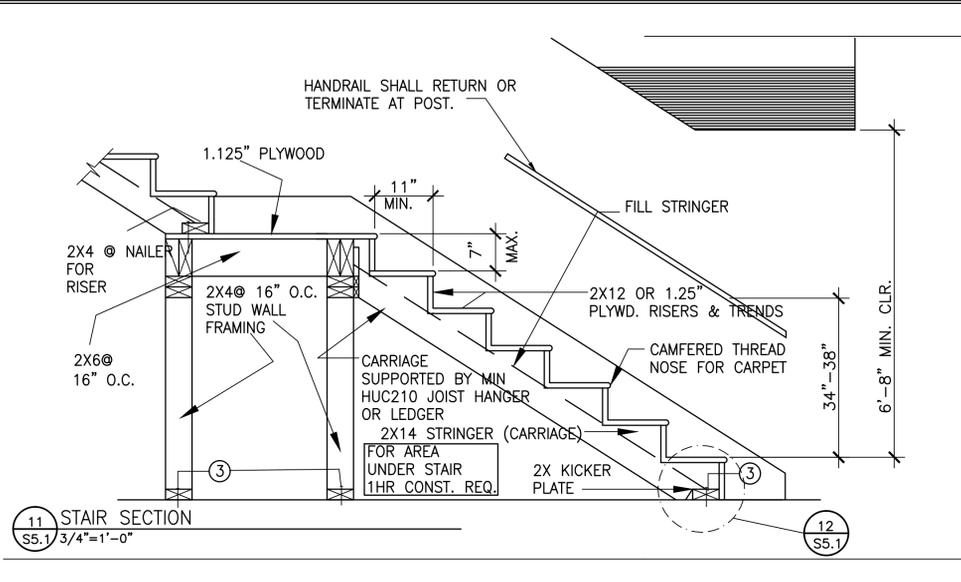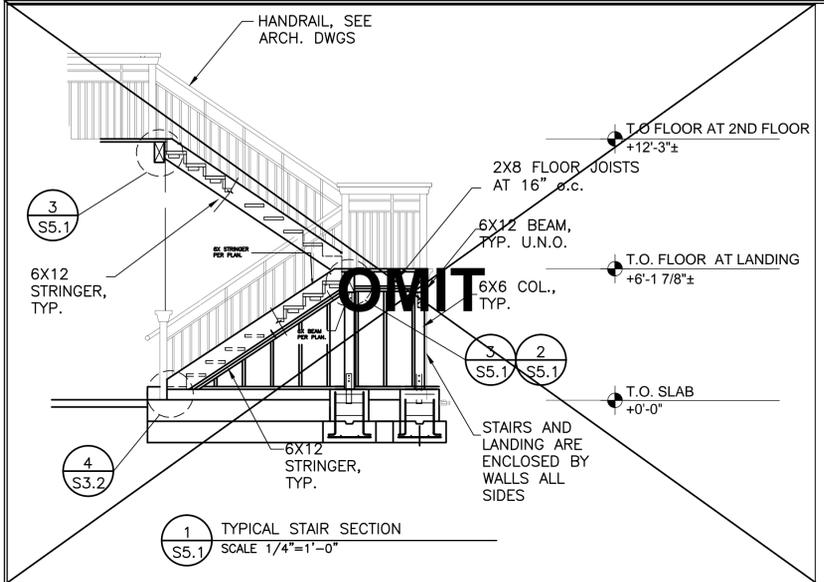


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COMMUNITY CENTER
HARBOR PARK APARTMENTS
969 PORTER STREET, VALLEJO, CA 94560

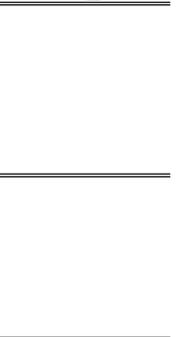DRAWING TITLE:
STEEL FRAMING DETAILS


REGISTERED PROFESSIONAL ENGINEER
JOSEPH OAKLEY
No. 2000
Exp. 09/30/11
STRUCTURAL
STATE OF CALIFORNIA

Date:	08/30/2011
Scale:	AS NOTED
Drawn:	STAFF
Checked:	RY
Job No.:	2011-09
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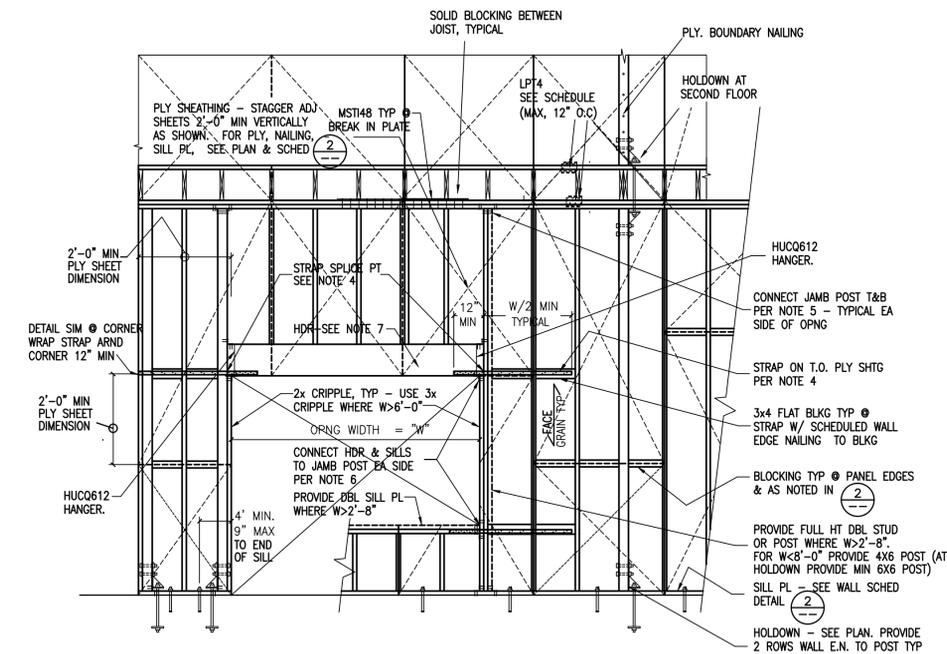


3A TYPICAL SHEARWALL DETAIL-WALL PERPENDICULAR TO TRUSSES
SCALE 3/4"=1'-0"

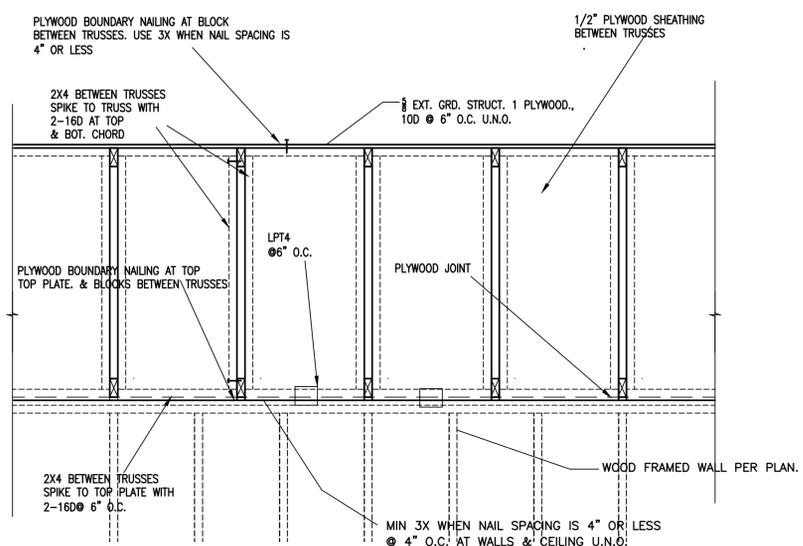


- 1 EXTEND SHEAR WALL NAILING AS WALL BELOW
- 2 SHEAR WALL-SEE SCHEDULE, SHT S6.2
- 3 CONTINUOUS CS16, DR CMST STRAP (LENGTH AS SHOWN ON FRAMING PLAN)
- 4 2x4 BLOCKING FLAT BETWEEN TRUSSES WITH PANEL EDGE NAILING
- 5 TRUSSES, BOT. & TOP CHORD
- 6 RDP DIAPHRAGM EDGE NAIL'G AT COLLECTOR; CDD NOT JOINT PLYWD. AT COLLECTOR
- 7 10D AT 4" O.C.
- 8 ST6236
- 9 2x NAILERS & FILLER (IF REQUIRED) NAILED TOGETHER W/SILL NAIL'G

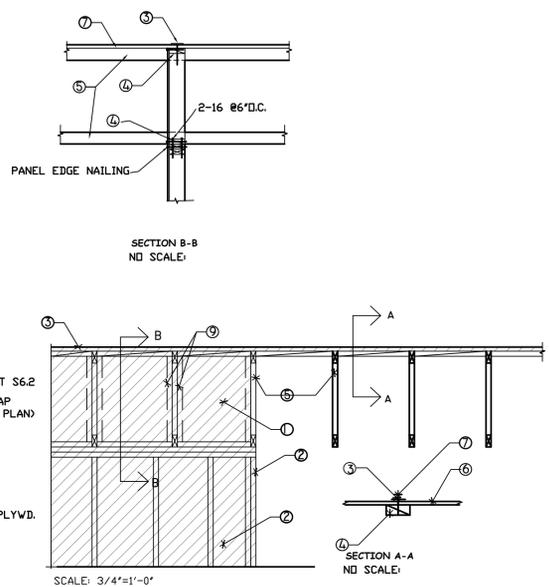
3B SHEAR WALL EXTENSION & COLLECTOR DETAIL-TRUSSES/JOIST PERPENDICULAR TO SHEAR WALL
SCALE 3/4"=1'-0"




1A TYPICAL SHEAR WALL FRAMING DETAIL-NEW WOOD FRAMED WALL
SIM @ NON-BEARING WALLS

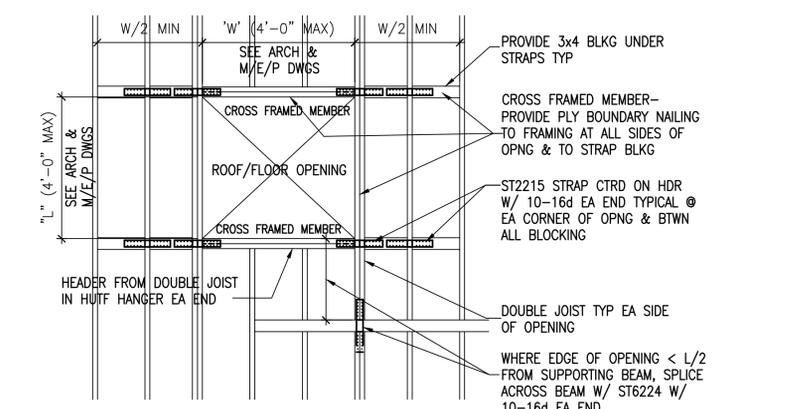

4 TYP ROOF OPENING DETAIL

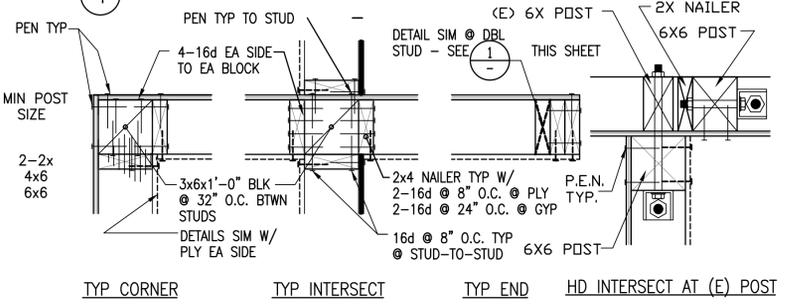

TYP CORNER TYP INTERSECT TYP END HD INTERSECT AT (E) POST

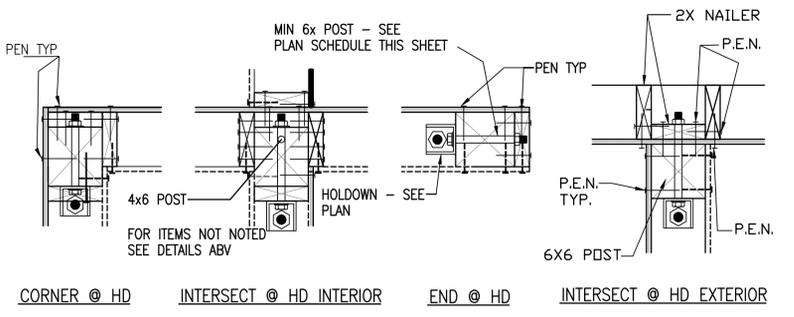

CORNER @ HD INTERSECT @ HD INTERIOR END @ HD INTERSECT @ HD EXTERIOR

5 TYP SECTIONS - WALL INTERSECTIONS

SYM.	SHEARWALL DESCRIPTION	TOP R SHEAR TRANSFER	SILL PLATE ANCHORAGE		LPT4 OR LPT5
			ANCHOR BOLTS (SEE NOTE 11)	SILL ATTACH. LAG SCREWS	
1	15/32" CDX PLYWOOD (1) SIDE W/ 10d @ 6" o.c.. USE 2x WALL AND 2x SOLE PLATE.	SEE PLAN	3/4" A.B. AT 36" o.c.	*	@ 12" O.C.
2	15/32" CDX PLYWOOD (1) SIDE W/ 10d @ 4" o.c.. USE 3x WALL AND 3x SOLE PLATE.	SEE PLAN	3/4" A.B. AT 30" o.c.	*	@ 12" O.C.
3	15/32" CDX PLYWOOD (1) SIDE W/ 10d @ 3" o.c.. USE 3x WALL AND 3x SOLE PLATE.	SEE PLAN	3/4" A.B. AT 18" o.c.	3/8"x5" LONG @ 5" o.c.	@ 12" O.C.
4	15/32" CDX PLYWOOD (1) SIDE W/ 10d @ 2" o.c.. USE 3x WALL AND 3x SOLE PLATE.	SEE PLAN	3/4" A.B. AT 12" o.c.	3/8"x5" LONG @ 4" o.c.	@ 6" O.C.
5	15/32" CDX PLYWOOD (2) SIDE W/ 10d @ 6" o.c.. USE 2x WALL AND 2x SOLE PLATE.	SEE PLAN	3/4" A.B. AT 36" o.c.	*	@ 6" O.C.
6	15/32" CDX PLYWOOD (2) SIDE W/ 10d @ 4" o.c.. USE 3x WALL AND 3x SOLE PLATE.	SEE PLAN	3/4" A.B. AT 30" o.c.	*	@ 6" O.C. AT EA. SIDE
7	15/32" CDX PLYWOOD (2) SIDE W/ 10d @ 3" o.c.. USE 3x WALL AND 3x SOLE PLATE.	SEE PLAN	3/4" A.B. AT 18" o.c.	3/8"x5" LONG @ 5" o.c.	@ 6" O.C. AT EA. SIDE
8	15/32" CDX PLYWOOD (2) SIDE W/ 10d @ 2" o.c.. USE 3x WALL AND 3x SOLE PLATE.	SEE PLAN	3/4" A.B. AT 12" o.c.	3/8"x5" LONG @ 4" o.c.	@ 6" O.C. AT EA. SIDE
9	12" WIDE HARDY PANEL	SEE PLAN	SEE PLAN	SEE PLAN	
10	24" WIDE HARDY PANEL	SEE PLAN	SEE PLAN	SEE PLAN	

- NOTES:**
- NOT USED.
 - APA RATED PANELS SHALL BE CDX OF THE FOLLOWING MATERIALS:
PLYWOOD (NER-108)
ORIENTED STRAND BOARD (NER-Q397)
WAFERBOARD (NER-124)
 - NAILING INDICATED IS TYP. EDGE NAILING, FOR FIELD NAILING 10d @ 12" O.C.
 - ALL HOLDOWNS EXCEPT MA4 ARE PLACED ON 6X6 POSTS TYP. U.N.O.
 - STAGGER JOINT AND SILL & NAILING.
 - NOT USED
 - FURNISH 3x MEMBERS AT ALL SHEAR WALLS, TYP. U.N.O.
 - NAILS SHALL BE STAGGERED ON EACH SIDE OF SIDE OF STUD WHERE PLYWOOD PANELS ARE APPLIED ON BOTH SIDES OF WALL
 - * = NOT APPLICABLE
 - NOT USED
 - AT ALL ANCHOR BOLTS AT SILL PLATES PROVIDE A MINIMUM 3X3X0.229 THK PLATE WASHER WITH NUT.

NOTE:

UNDERDRIVEN NAILS ARE REQUIRED TO BE DRIVEN BY HAMMER SO THAT THE HEAD OF THE NAIL IS FLUSH WITH THE TOP SURFACE OF THE PLYWOOD.


MACHINE NAILING SHALL BE USED ONLY WHERE THE BACK SIDE CAN BE INSPECTED FOR "SHINERS".

"SHINERS" OR NAILS WHICH DO NOT PENETRATE FULLY INTO FRAMING OR BLOCKING SHALL BE REMOVED AND REPLACED. ALL REMEDIAL NAILING SHALL BE BY HAND.

IF ANY FRAMING MEMBERS, BLOCKING OR JOISTS RECEIVING THE POINTS OF NAILS, ARE DAMAGED (SPLIT, NAILS HIT TO CLOSE, ETC.) THEY SHALL BE REMOVED AND REPLACED.

GUN NAILING FOR TOE NAIL, END NAIL AND SLANT DRIVEN NAIL ARE NOT PERMITTED.


2 SHEAR WALL SCHEDULE & NOTES

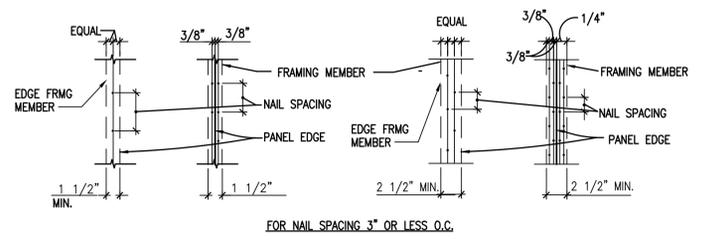

3 TYP. PLYWOOD EDGE NAILING
NO SCALE

- TYPICAL WALL FRAMING NOTES:**
- LOCATE MECH OPENINGS IN NON-SHEAR WALLS WHERE POSSIBLE.
 - MECH OPENINGS IN SHEAR WALLS TO BE LOCATED 1'-6" MIN. FROM HOLD DOWN ANCHOR LOCATIONS.
 - ALL NAILING NOT SHOWN IS PER NAILING SCHEDULE ON S0.1 OR AS DETAILED ELSEWHERE.
 - PROVIDE STRAPS @ T&B CORNERS OF ALL SHEAR WALL OPENINGS PER THE FOLLOWING SCHEDULE:
• OPNG < 4'-0" WIDE: CS20 STRAP W/ MIN 10-8d EA SIDE OF SPLICE PT
• OPNG > 4'-0" WIDE: CS16 STRAP W/ MIN 16-8d EA SIDE OF SPLICE PT
DISTRIBUTE NAILING EVENLY ALONG BLKG W/ 6-8d MINIMUM TO EA BLOCK FACE. SEE DETAIL 1.
 - CONNECT JAMB POSTS T&B AS FOLLOWS:
• W<4'-0" WIDE: TOENAIL PER SCHED
• W<8'-0" WIDE: A23 CLIP T&B
SEE DRAWINGS FOR OTHER CONDITIONS
 - CONNECT HDRS & SILLS TO FULL HEIGHT JAMB POSTS (SOLID POST & BUILT-UP POSTS USING 2X6'S OR 3X6'S) EA SIDE AS FOLLOWS:
• W<4'-0" WIDE: NAIL PER SCHED
• W<6'-0" WIDE: A23 CLIP 1 SIDE OF HDRS/SILL
• W<8'-0" WIDE: A23 CLIP EA SIDE OF HDRS/SILL
SEE DRAWINGS FOR OTHER CONDITIONS
 - UNLESS OTHERWISE SHOWN ON PLAN, PROVIDE HEADERS @ T.O. OPNGS AS FOLLOWS:
• W<4'-0" WIDE: HDR DEPTH = 6" NOM
• W<6'-0" WIDE: HDR DEPTH = 8" NOM
• W<8'-0" WIDE: HDR DEPTH = 10" NOM
HEADERS TO BE SOLID TIMBERS W/ THICKNESS SAME AS WALL STUDS. SEE 43 FOR ADDITIONAL INFORMATION.

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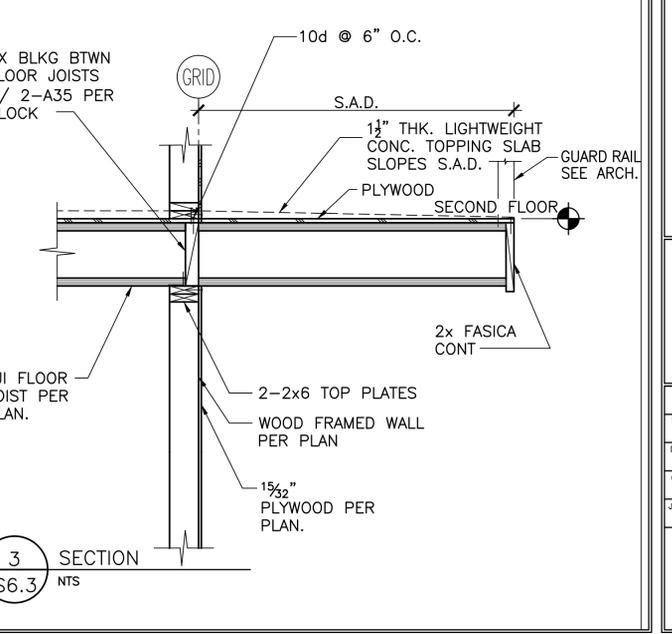
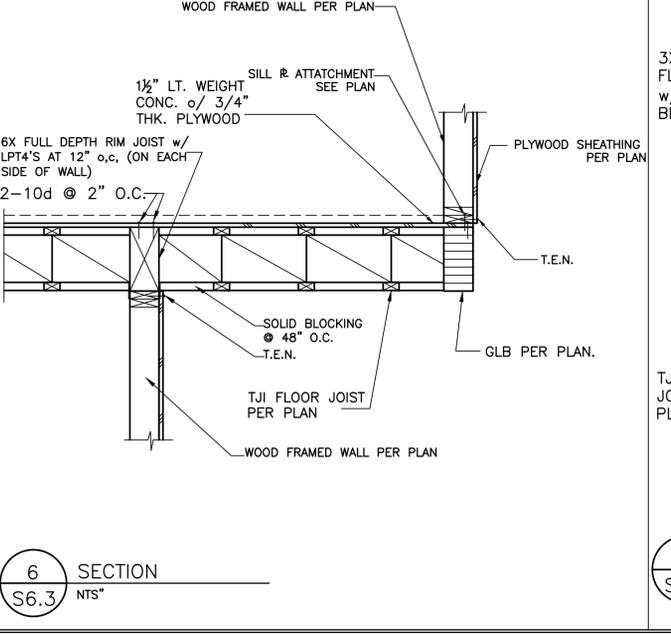
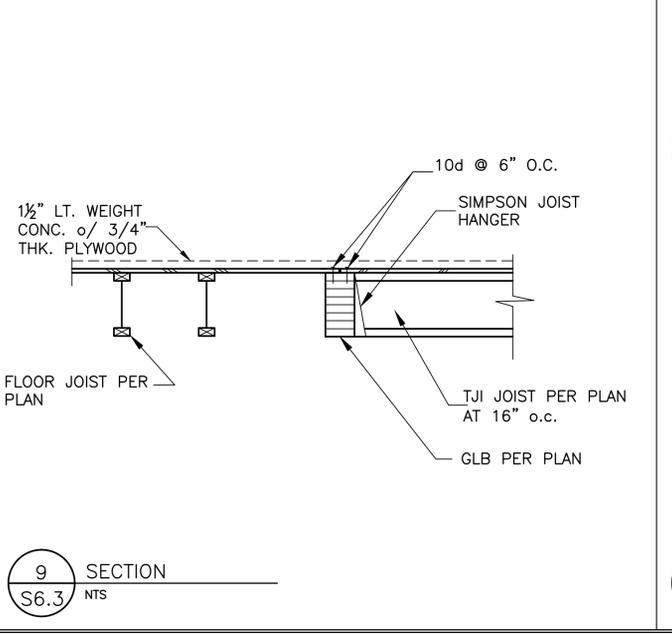
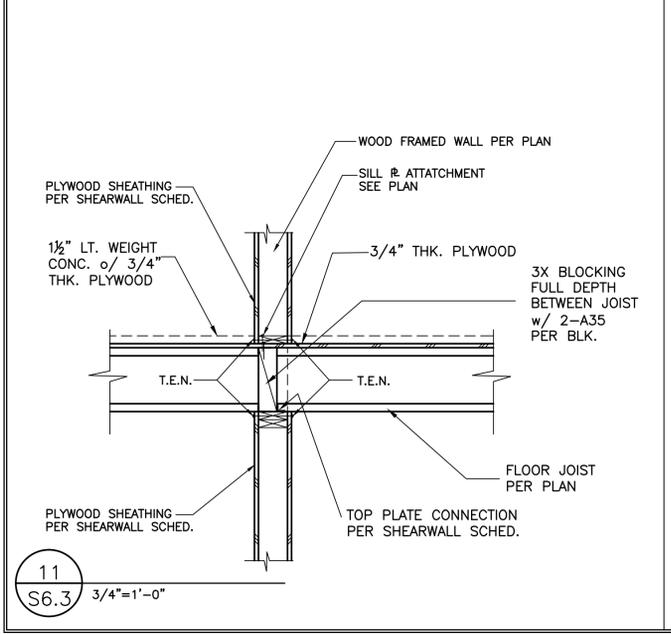
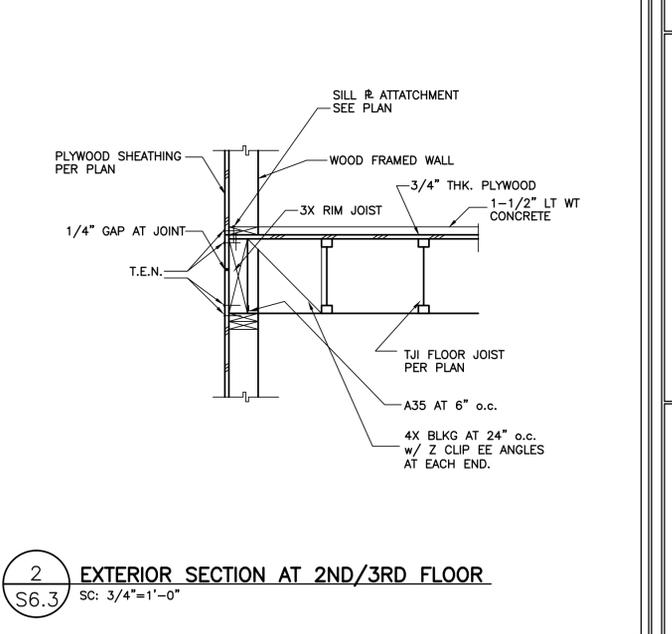
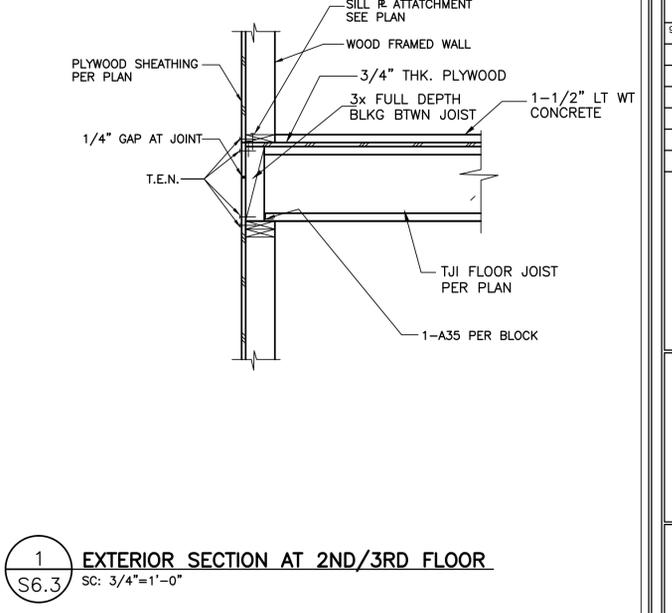
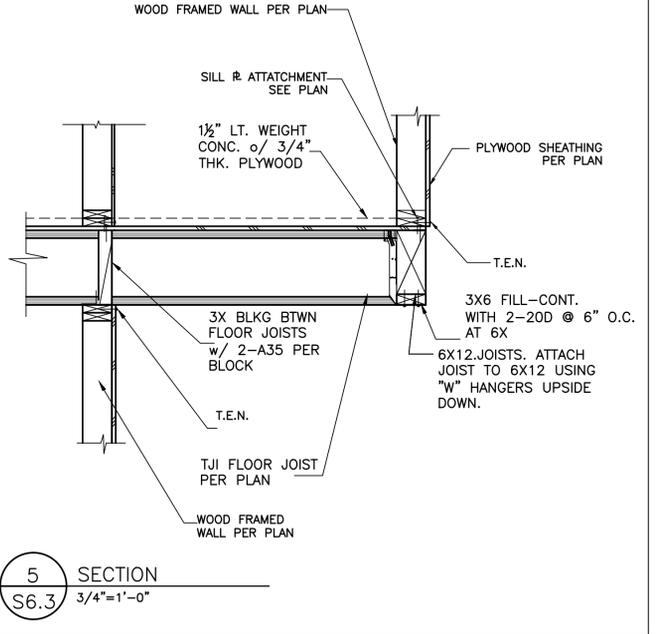
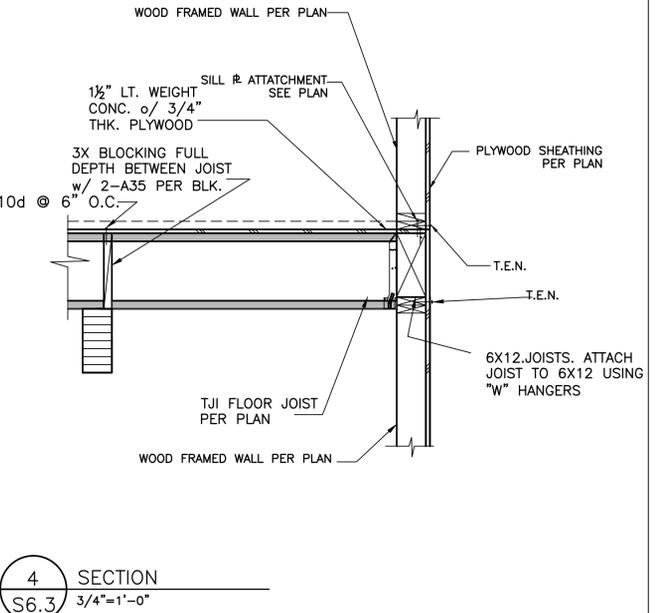
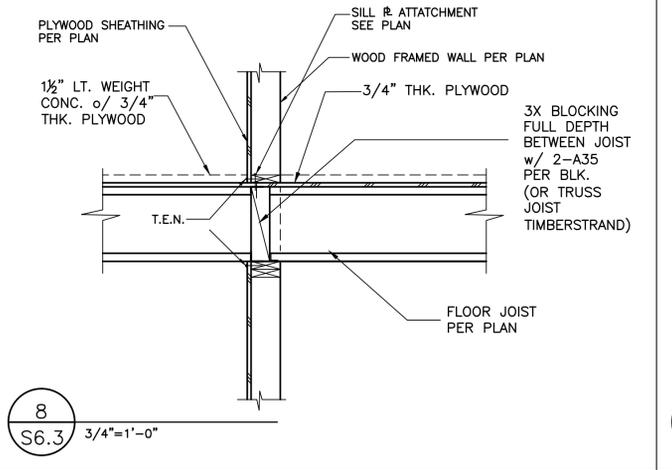
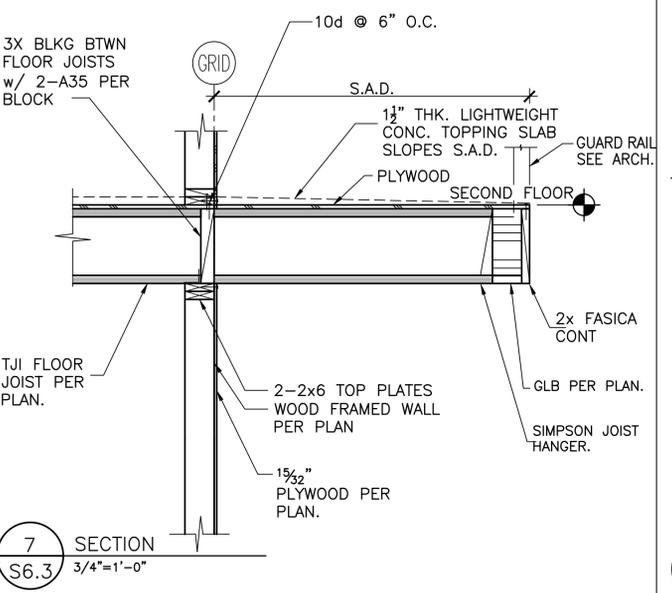
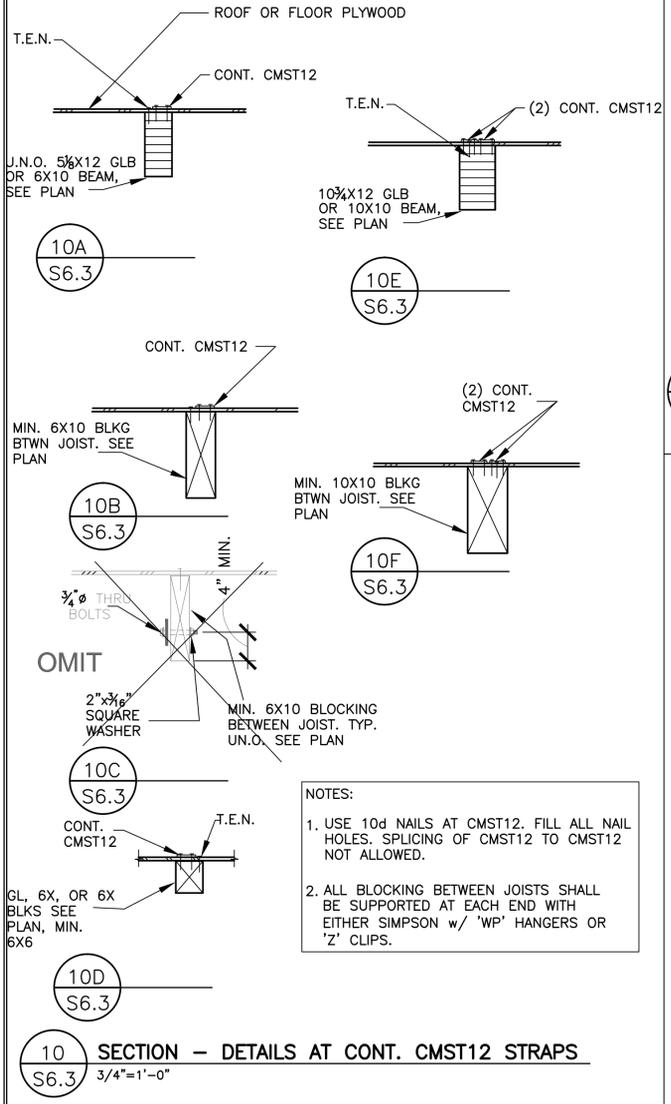
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TYPICAL SHEAR WALL DETAILS

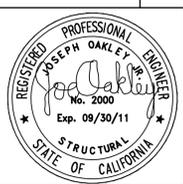
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S6.2

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 DRAWING TITLE: WOOD FRAMING DETAILS



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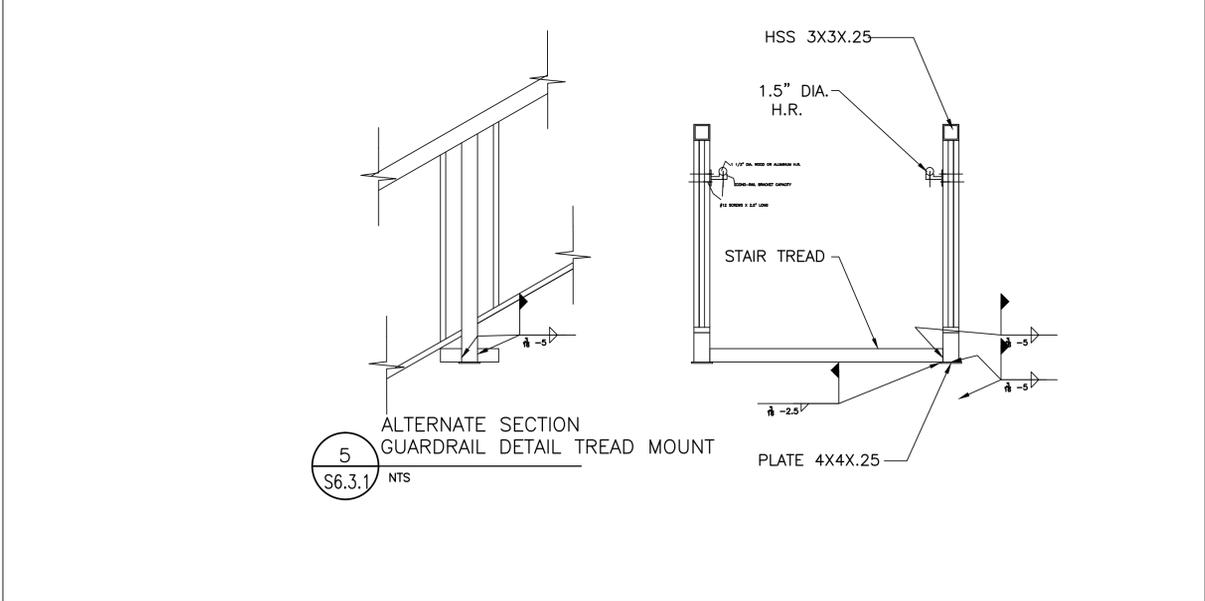
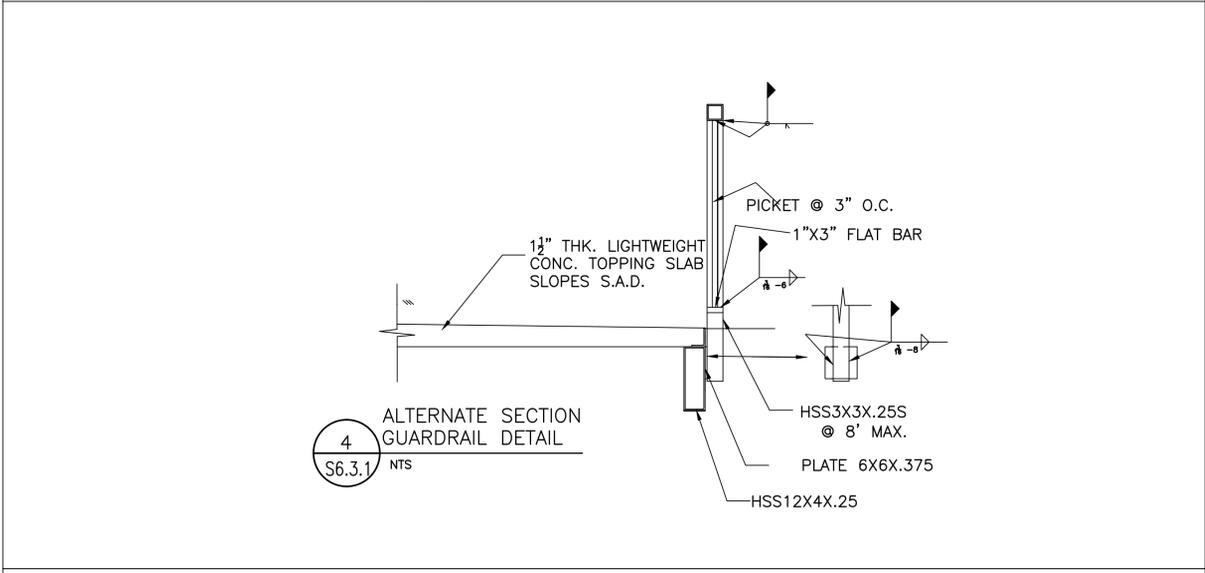
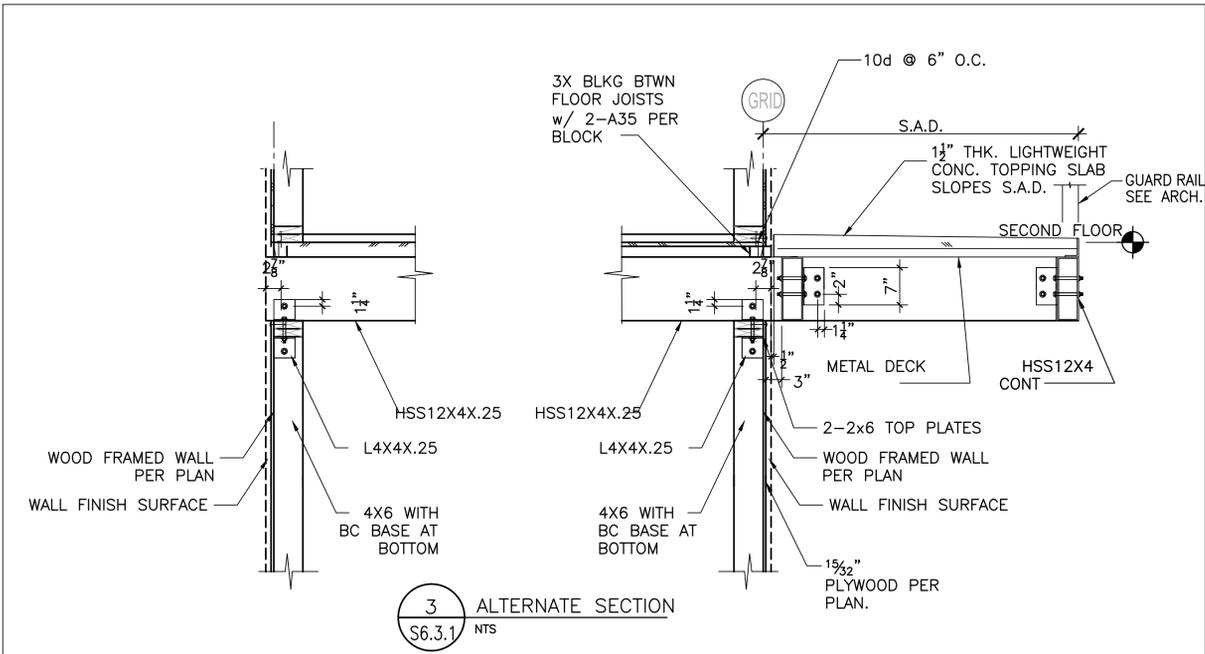


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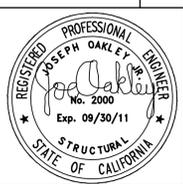
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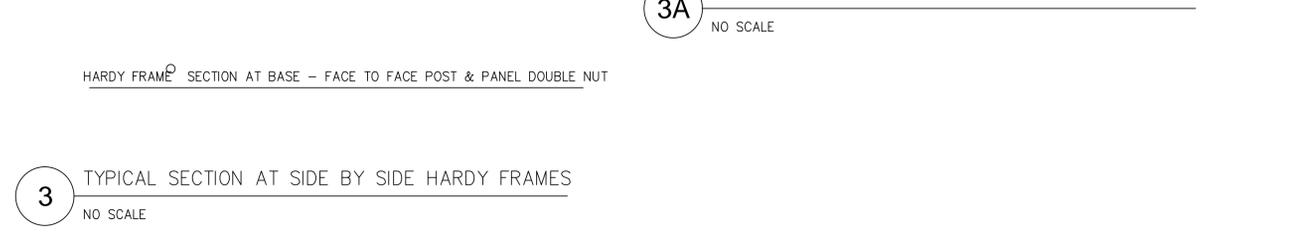
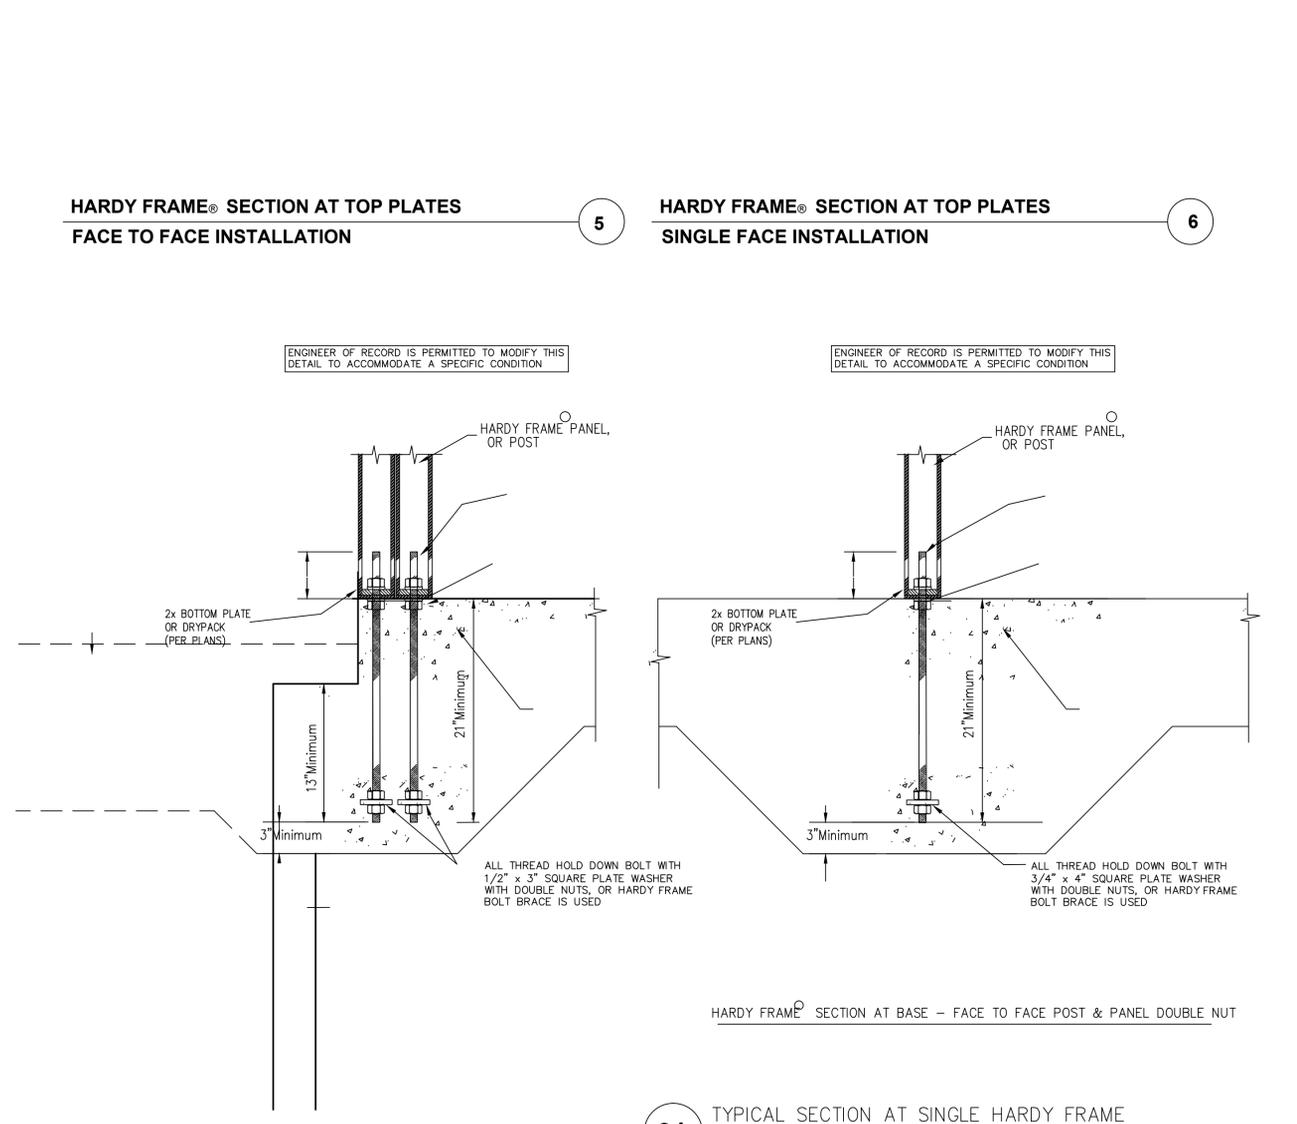
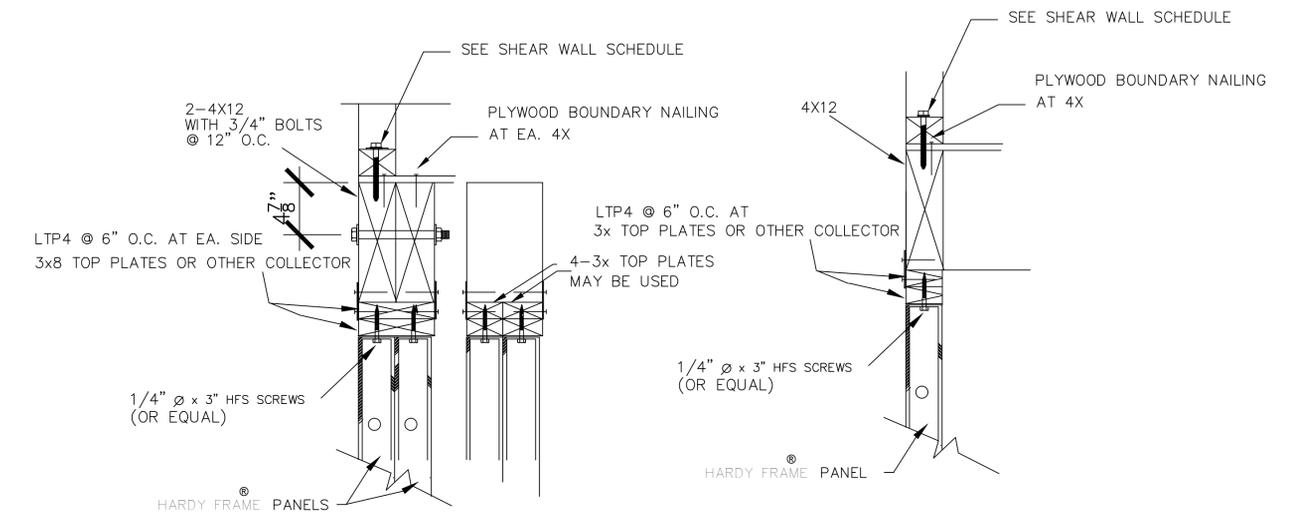
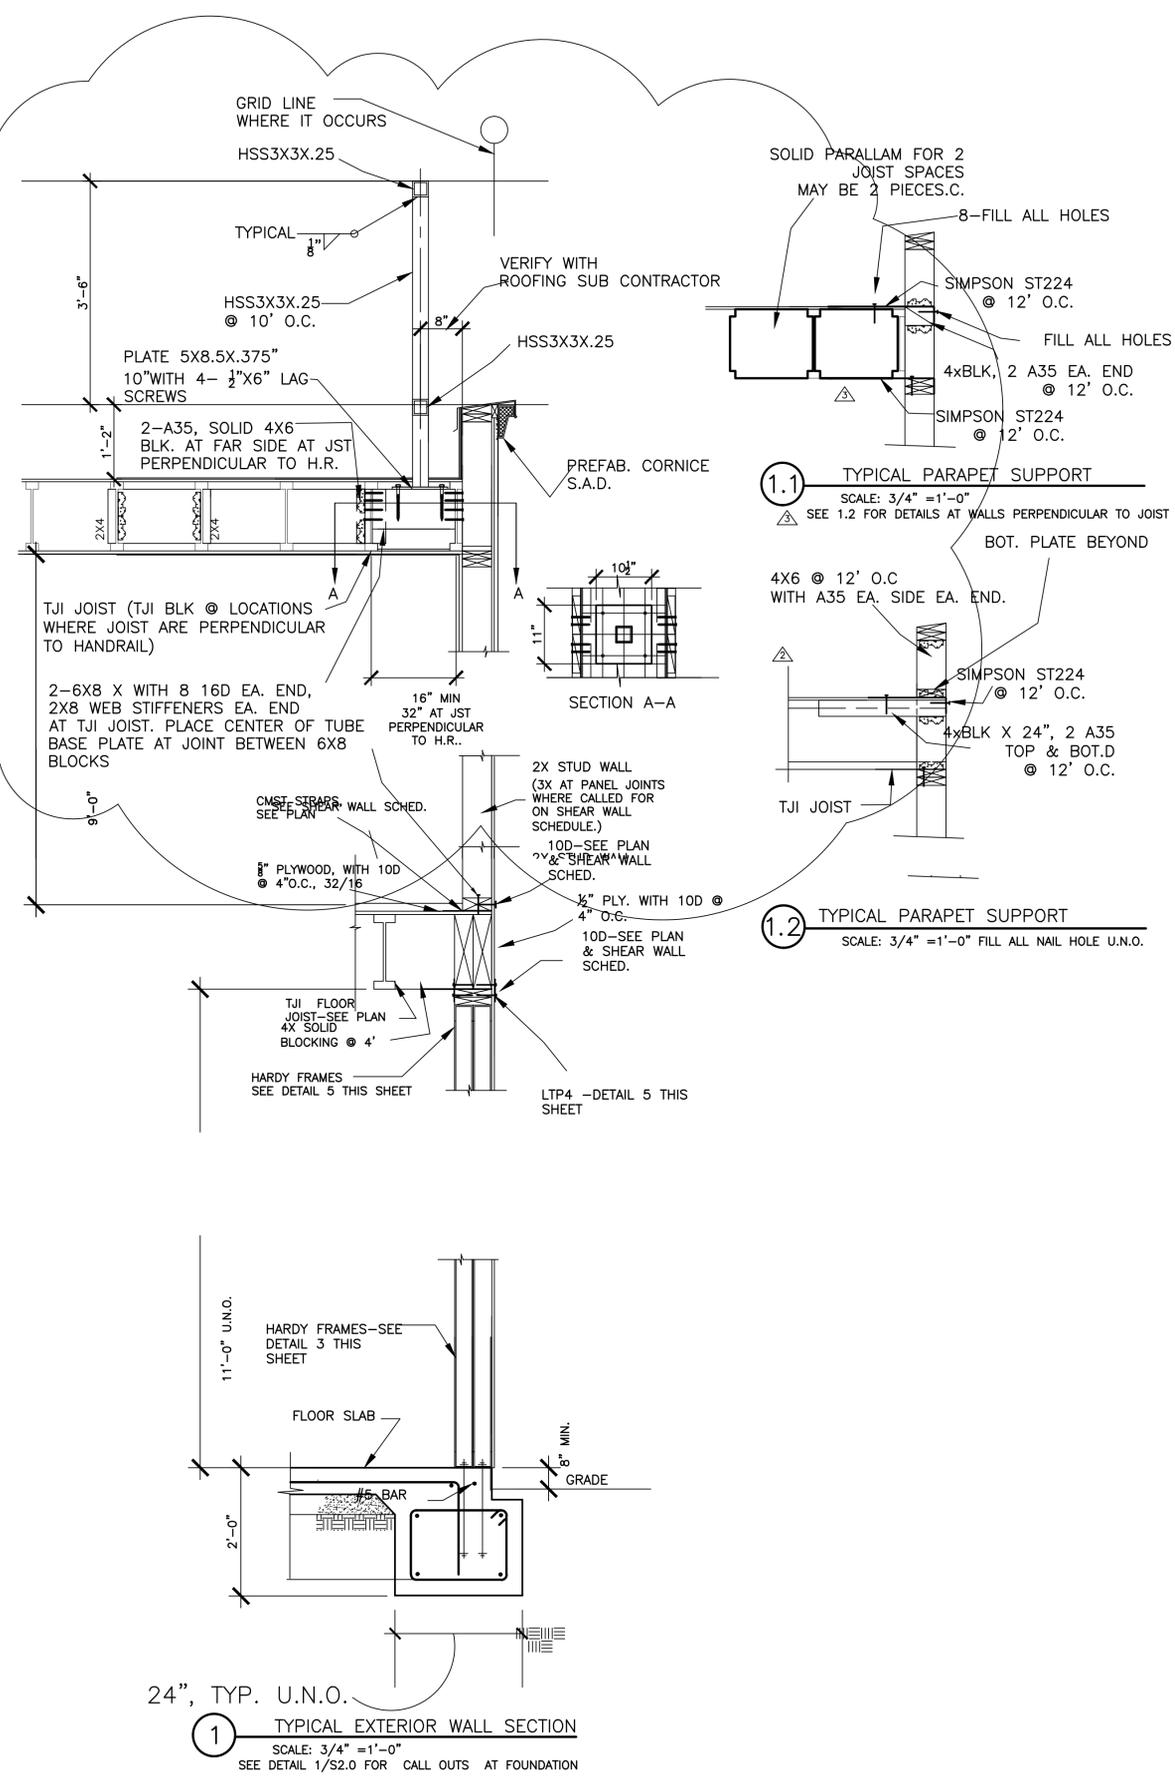
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1-8-14 BIDDING	T.G.
1-27-14 BIDDING	J.O.

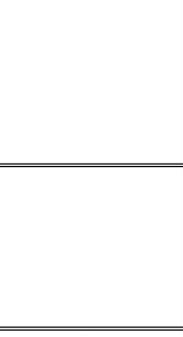
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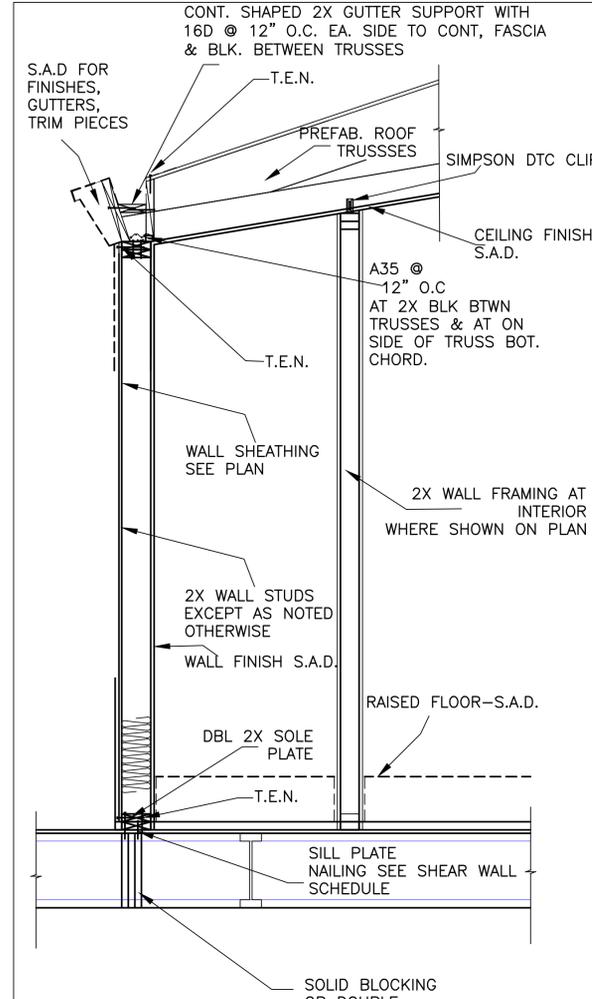
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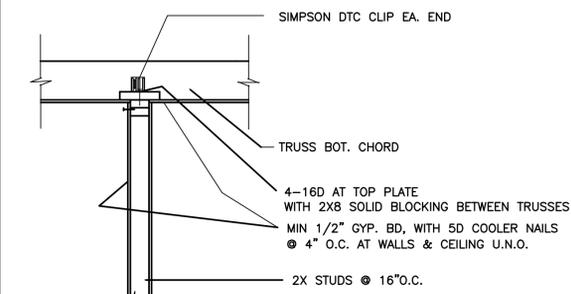
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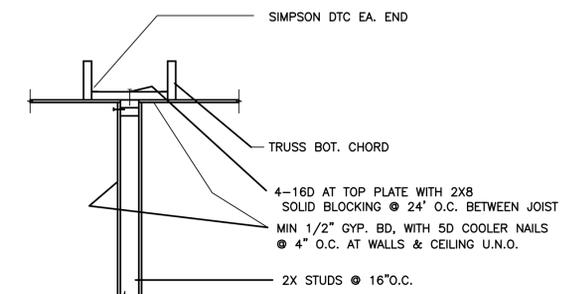
5.1 TYPICAL EXTERIOR WALL SECTION AT GABLE ENDS
S6.4 SCALE 3/4"=1'-0"




5 TYPICAL EXTERIOR WALL SECTION
S6.4 SCALE 3/4"=1'-0"




8 TYPICAL BACKING DETAIL-NON BEARING WALLS
S6.4 SCALE 3/4"=1'-0"

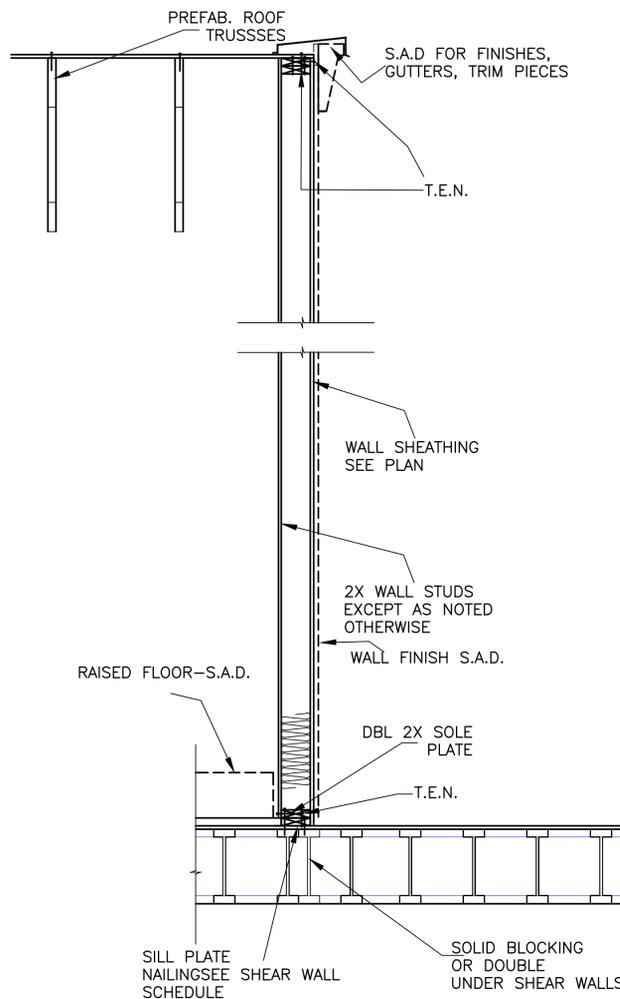


9 TYPICAL BACKING AT WALLS PARALLEL TO JOIST
S6.4 SCALE 3/4"=1'-0"

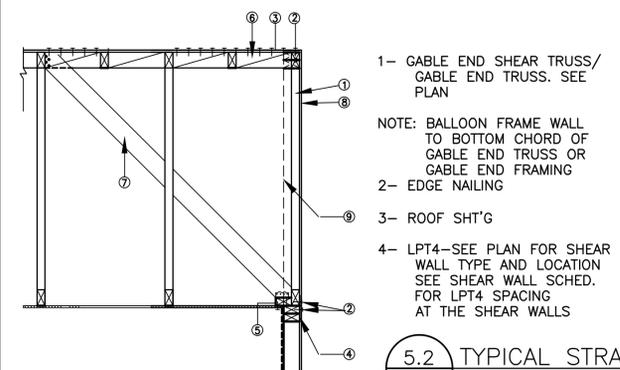


5.2 TYPICAL STRAP DETAILS AT TRUSSES
S6.4 SCALE 3/4"=1'-0"

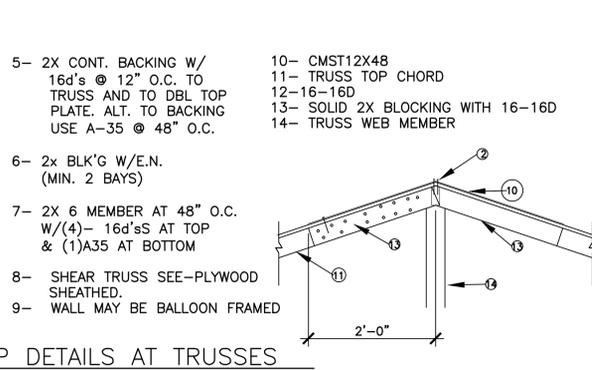


7 SHEAR TRANSFER DETAIL AT THIRD FLOOR ROOF
S6.4 SCALE 3/4"=1'-0"

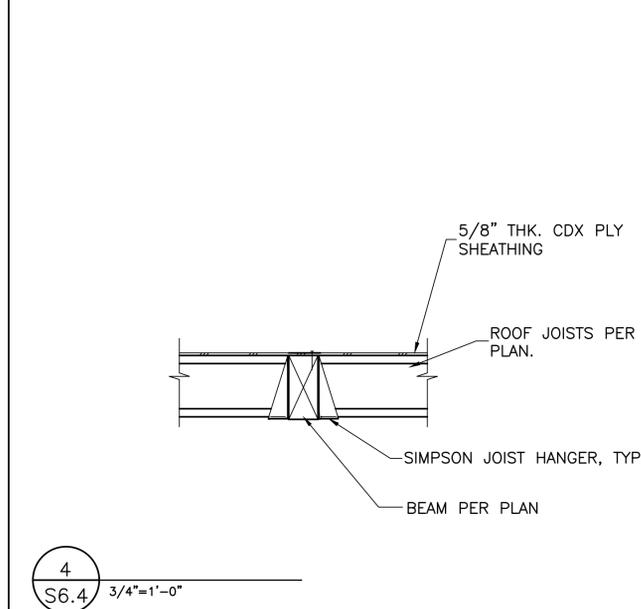


4 S6.4 3/4"=1'-0"

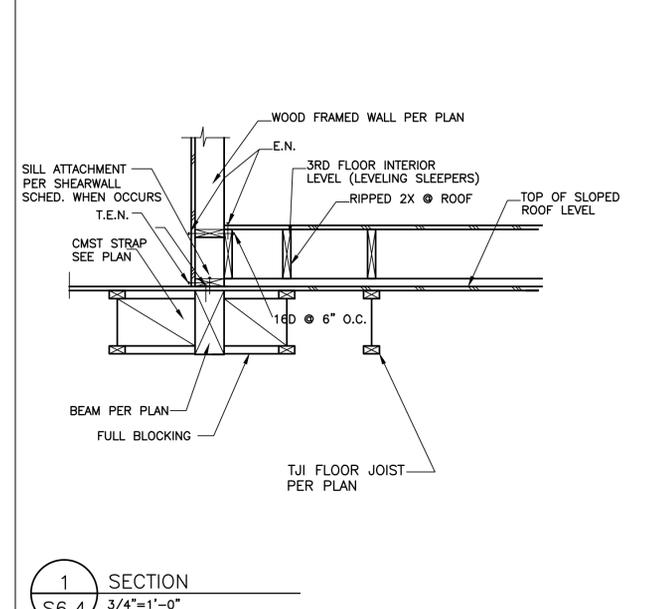


1 SECTION
S6.4 3/4"=1'-0"

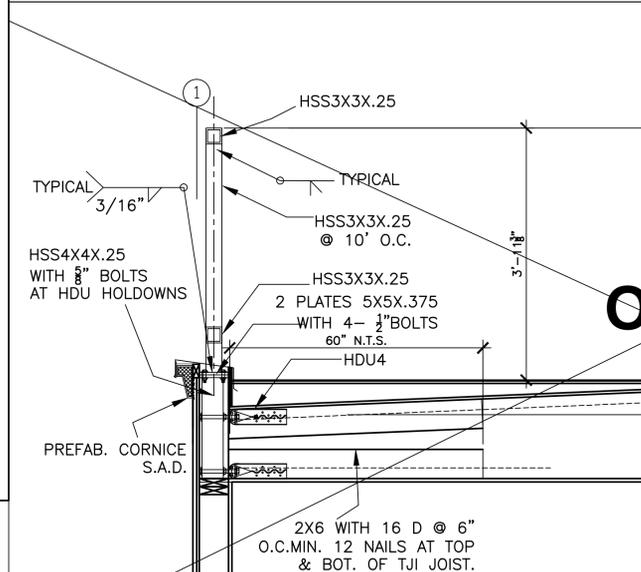


6 BALUSTER AT THRID FLOOR ROOF AND EXTERIOR DECKS
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2 BALUSTER AT THRID FLOOR ROOF AND EXTERIOR DECKS
S6.4 SCALE 3/4"=1'-0"

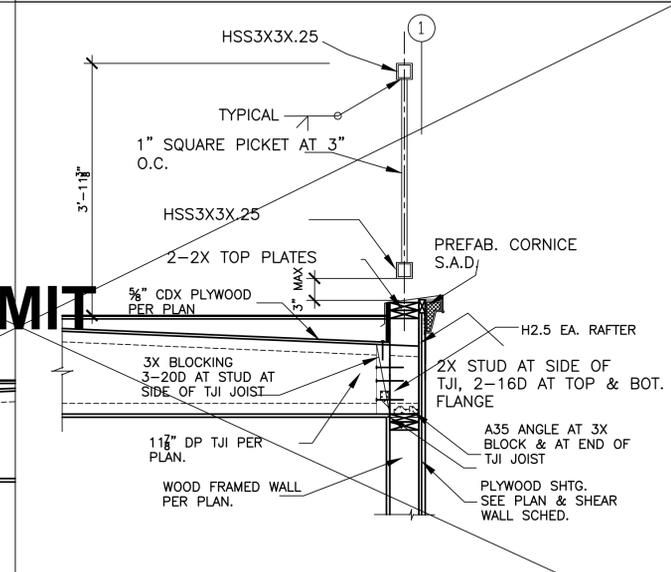


7 SHEAR TRANSFER DETAIL AT THIRD FLOOR ROOF
S6.4 SCALE 3/4"=1'-0"

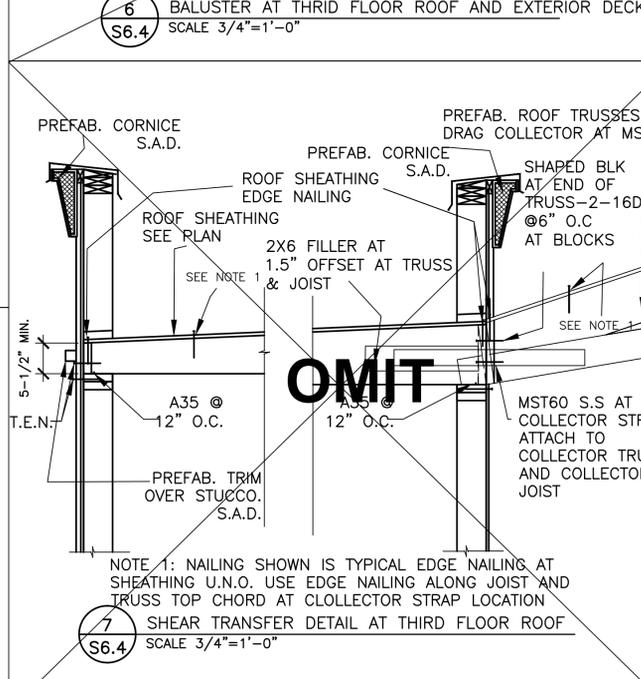

3 S6.4 3/4"=1'-0"
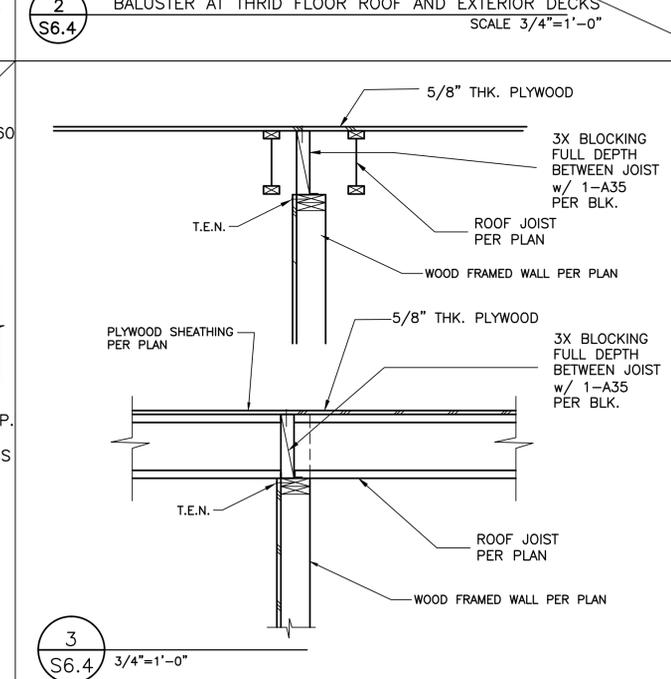
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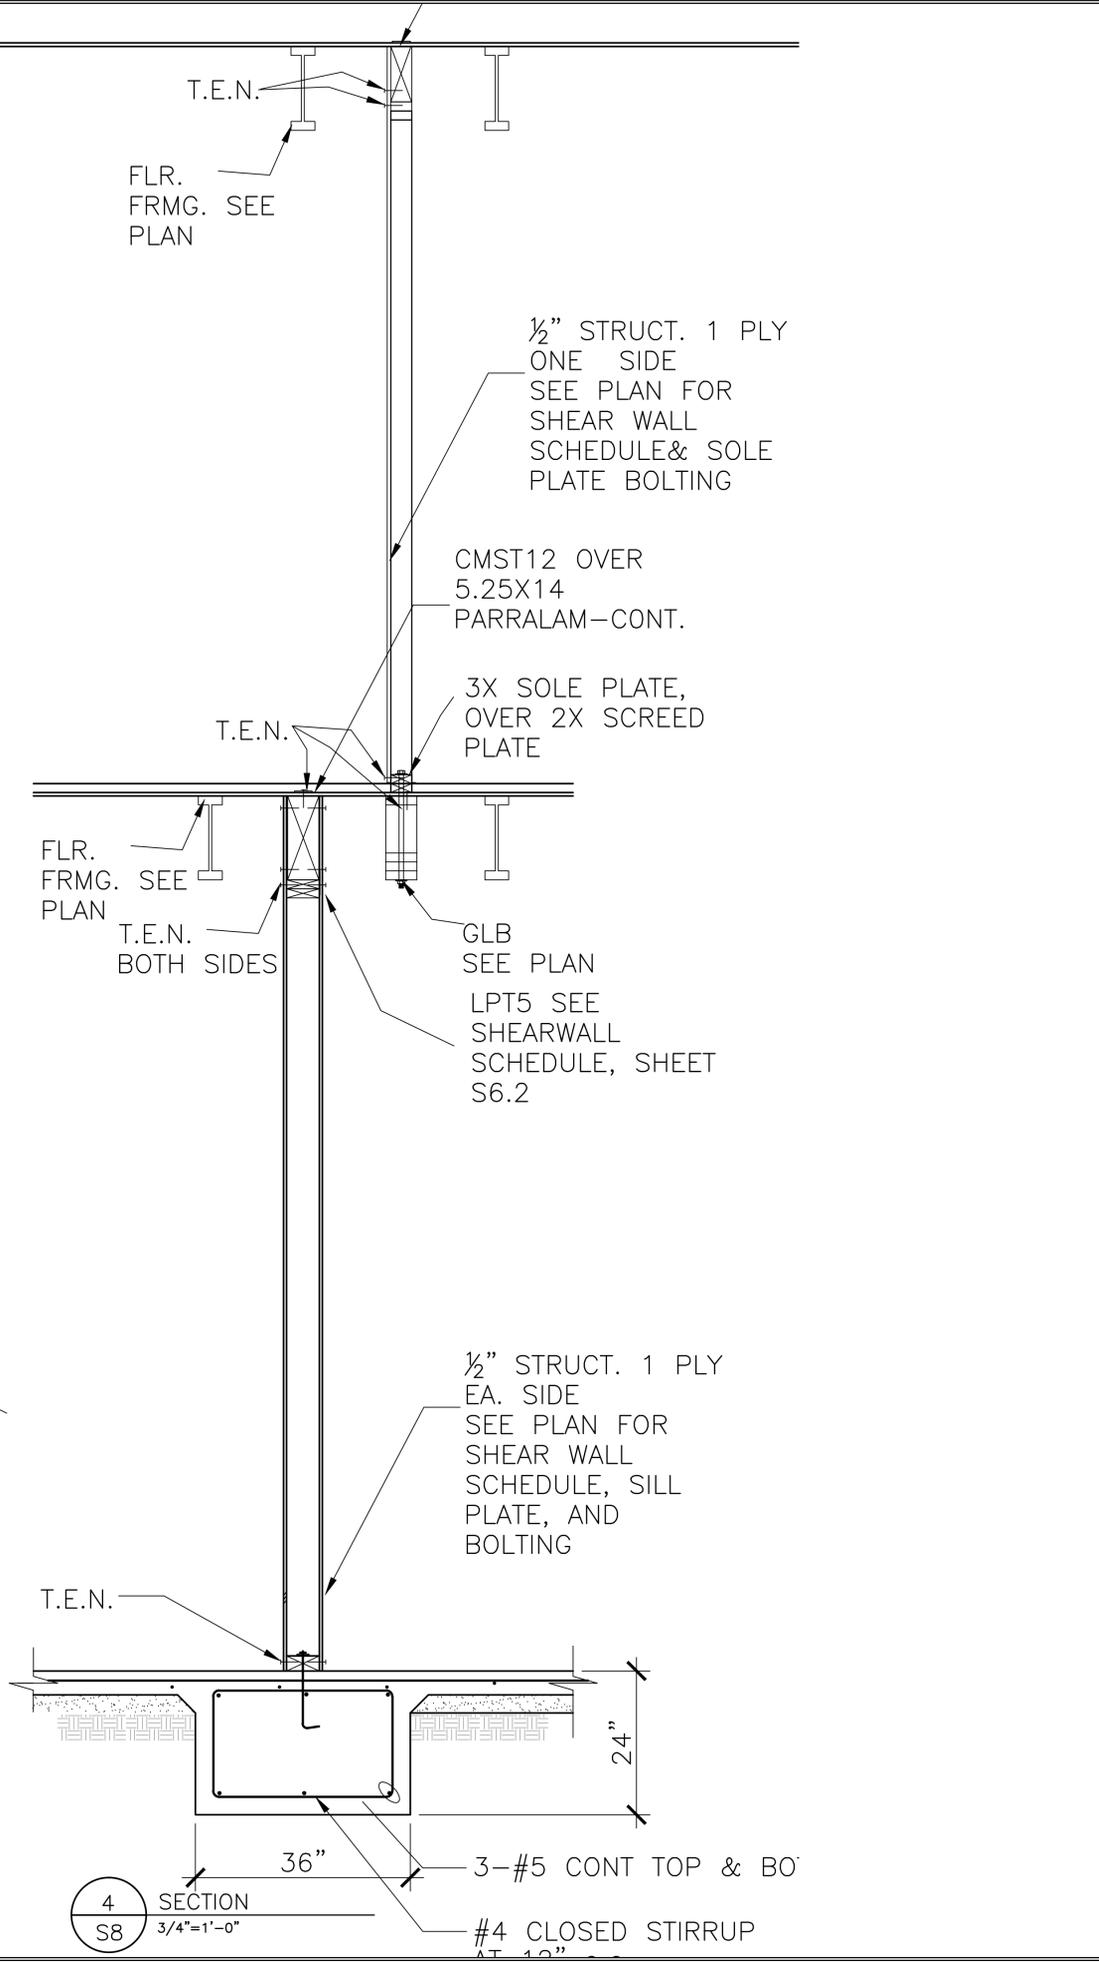
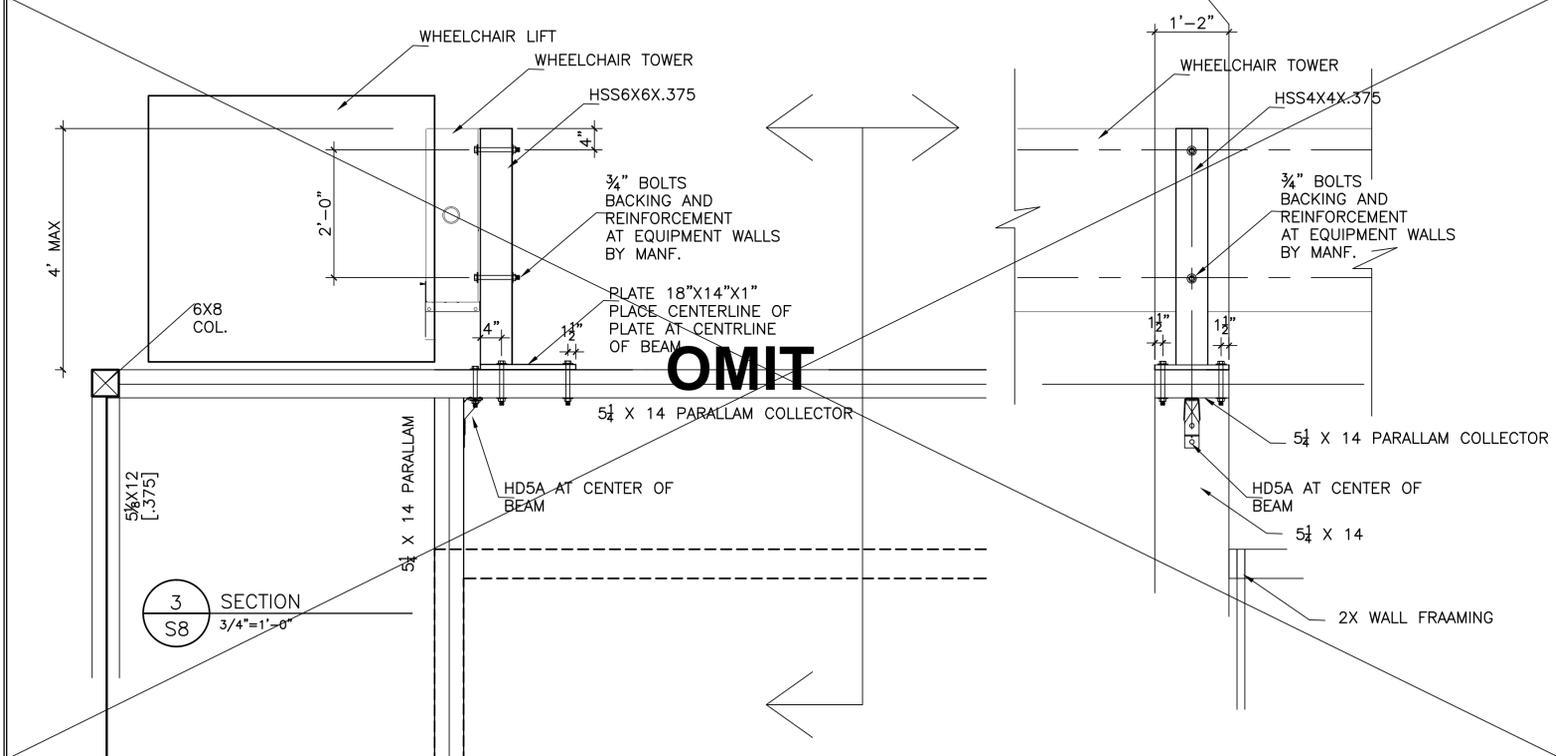
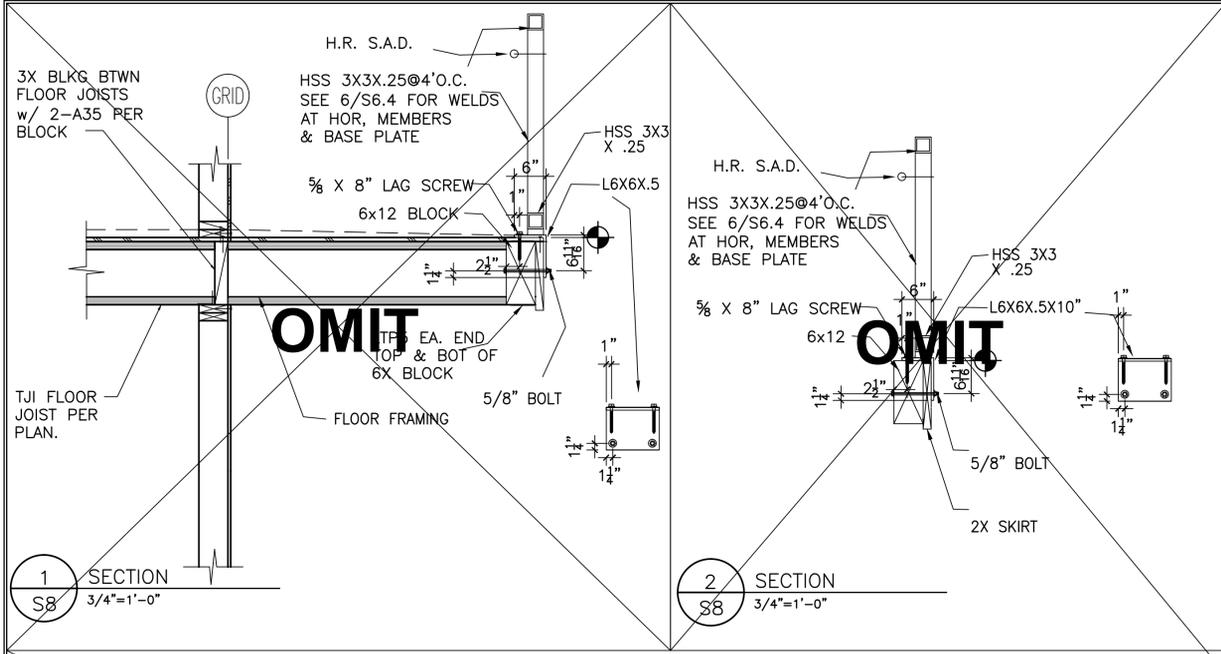

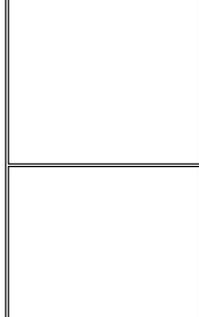
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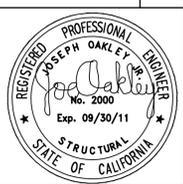
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WOOD FRAMING DETAILS

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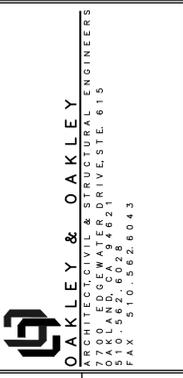
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STRUCTURAL DETAILS



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CHECKED: RY
JOB NO.: 2011-09
SHEET: S8

DATE: 08/30/2011
SCALE: AS NOTED
DRAWN: STAFF
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JOB NO.: 2011-09
SHEET: S8